





Richard Molenaar
ARCHITECT

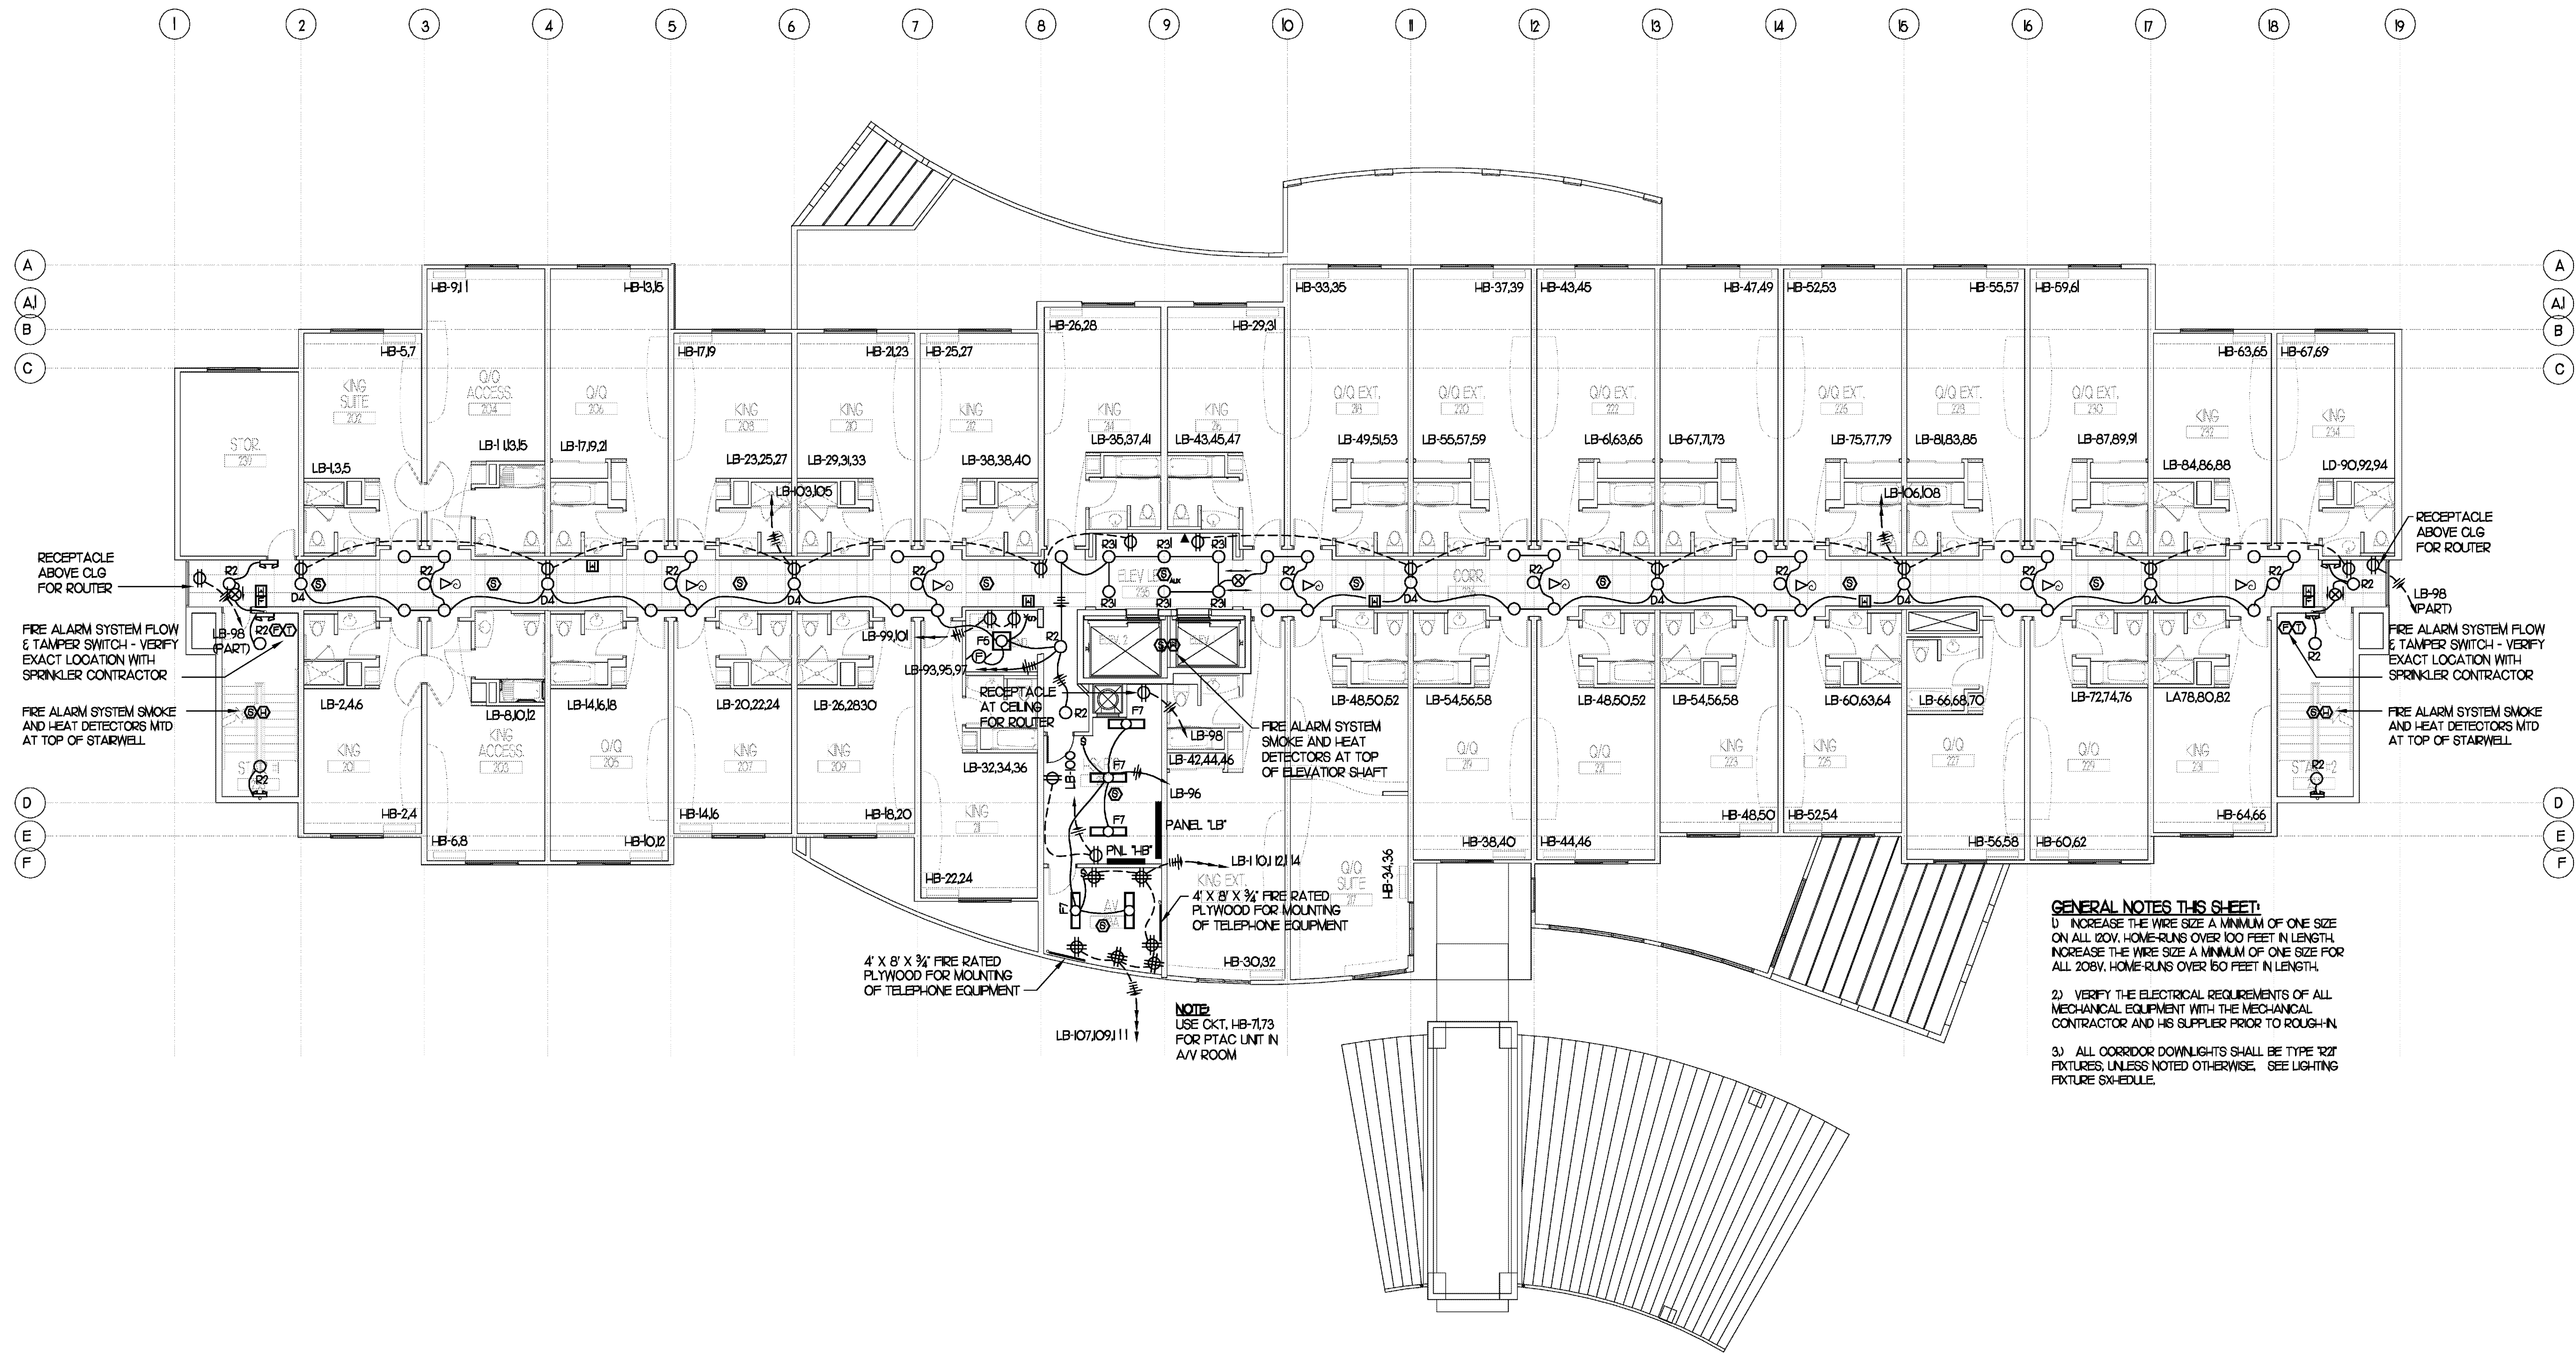

SECOND FLOOR ELECTRICAL PLAN
SCALE: 1/8" = 1'-0"

- GENERAL NOTES THIS SHEET:
- 1) INCREASE THE WIRE SIZE A MINIMUM OF ONE SIZE ON ALL BOV. HOME-RUNS OVER 100 FEET IN LENGTH. INCREASE THE WIRE SIZE A MINIMUM OF ONE SIZE FOR ALL 208V. HOME-RUNS OVER 150 FEET IN LENGTH.
 - 2) VERIFY THE ELECTRICAL REQUIREMENTS OF ALL MECHANICAL EQUIPMENT WITH THE MECHANICAL CONTRACTOR AND HIS SUPPLIER PRIOR TO ROUGH-IN.
 - 3) ALL CORRIDOR DOWNLIGHTS SHALL BE TYPE R2T FIXTURES UNLESS NOTED OTHERWISE. SEE LIGHTING FIXTURE SCHEDULE.

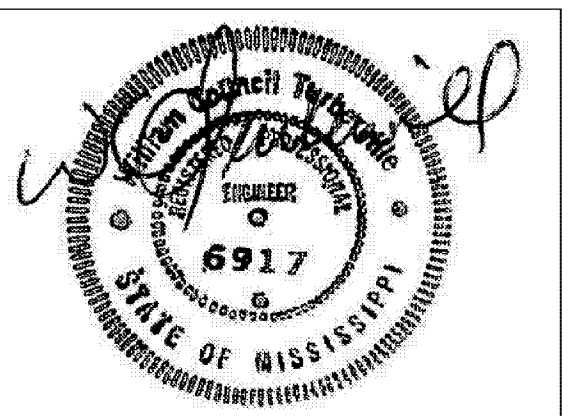

Riverwind Drive Pearl, Mississippi

SHEET TITLE:

SECOND FLOOR ELECTRICAL PLAN

PROJECT NO. 09017 LATEST REVISION:

DRAWN BY: SWJ CHECKED BY: SWJ SHEET NUMBER:

DATE: 9/01/11

E203