




PLAN  
SCALE: 1"=1'  
\* GRATE TO BE TYPE "B" OR "C"  
TYPE "B" SHOWN.

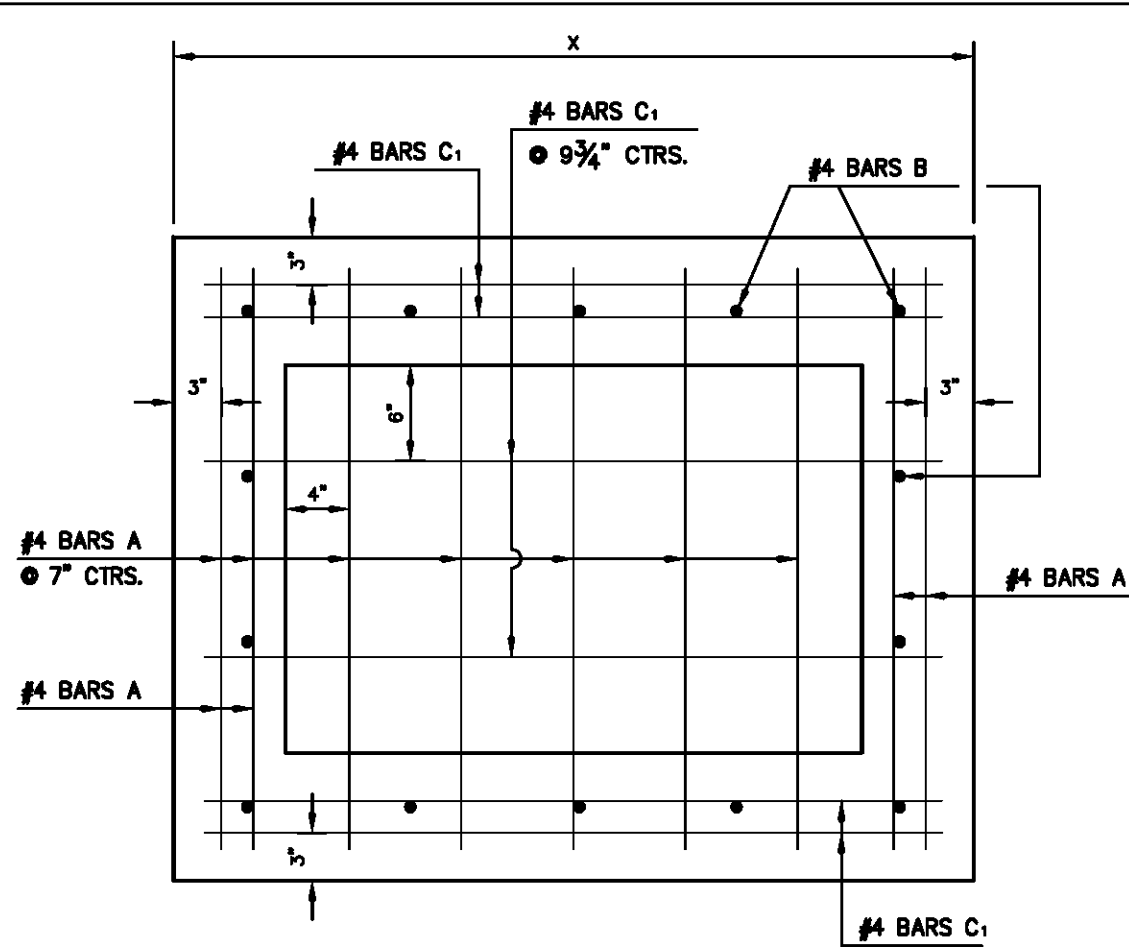

HORIZONTAL SECTION  
SCALE: 1"=1'  
SHOWING BOTTOM SLAB REINFORCING STEEL

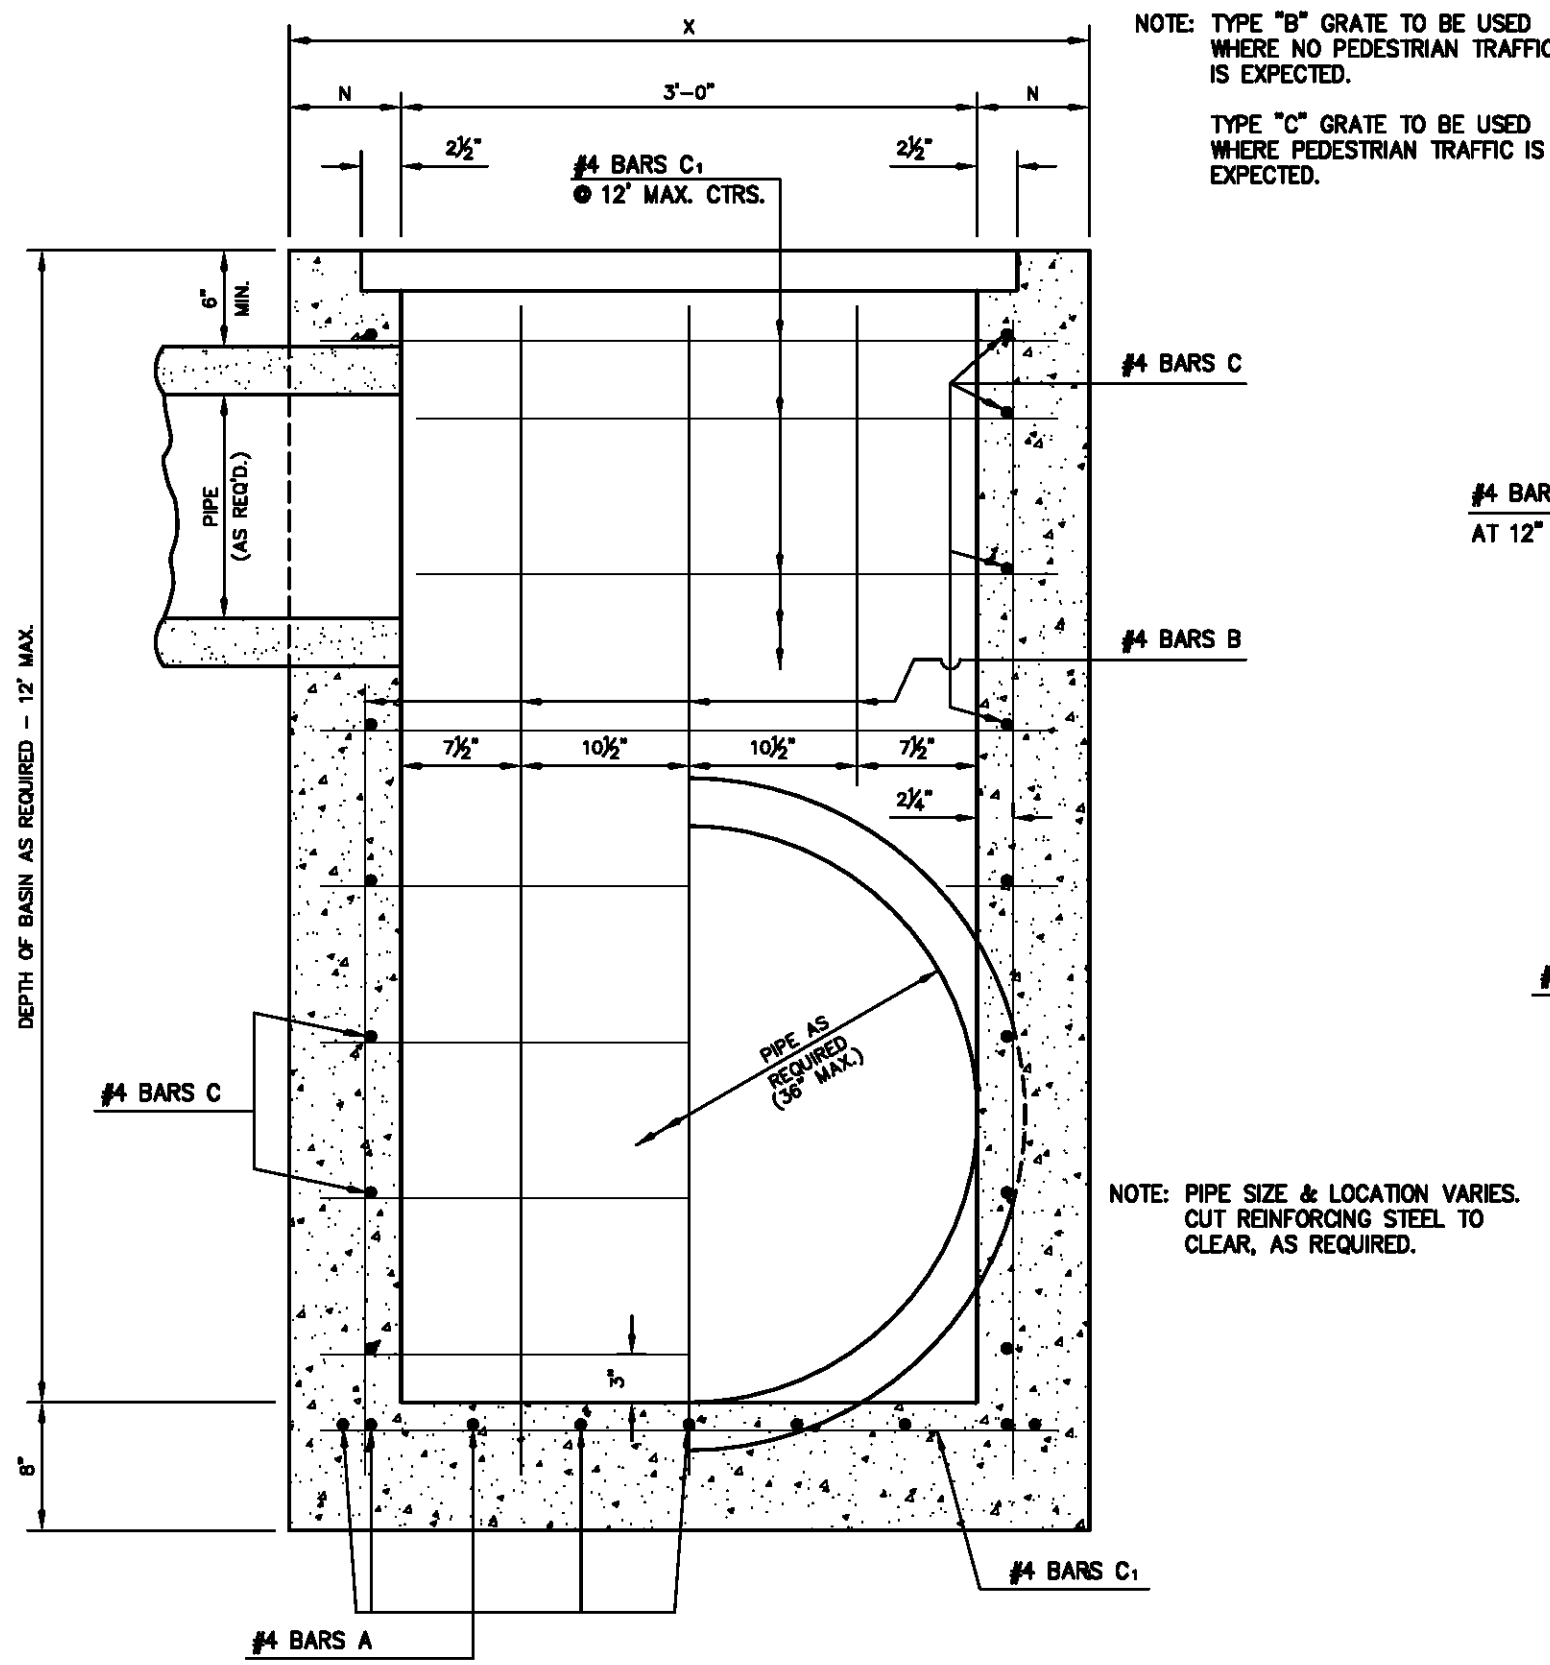


SECTION A-A  
SCALE: 1"=1'

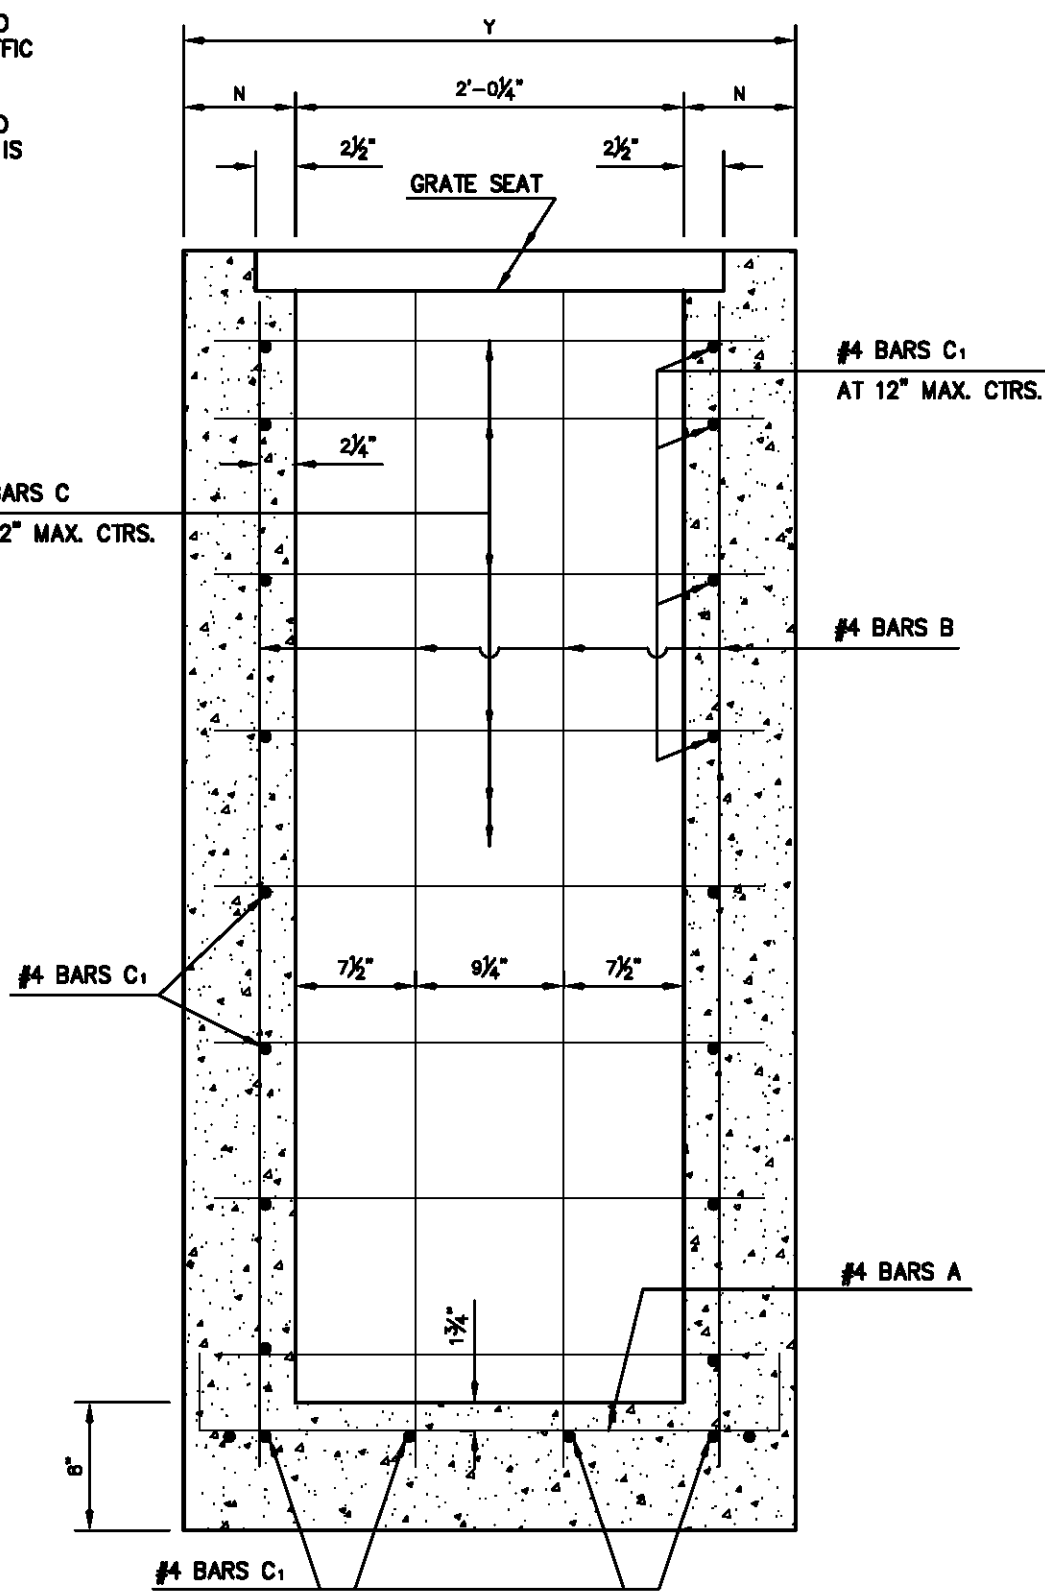

SECTION B-B  
SCALE: 1"=1'


## CATCH BASIN - CB01

DIMENSIONS			
DEPTH OF BASIN	N	X	Y
FT.	IN.	FT.-IN	FT.-IN
0 - 8	7	4-2	3-2 1/4
8.1 - 12	8	4-4	3-4 1/4

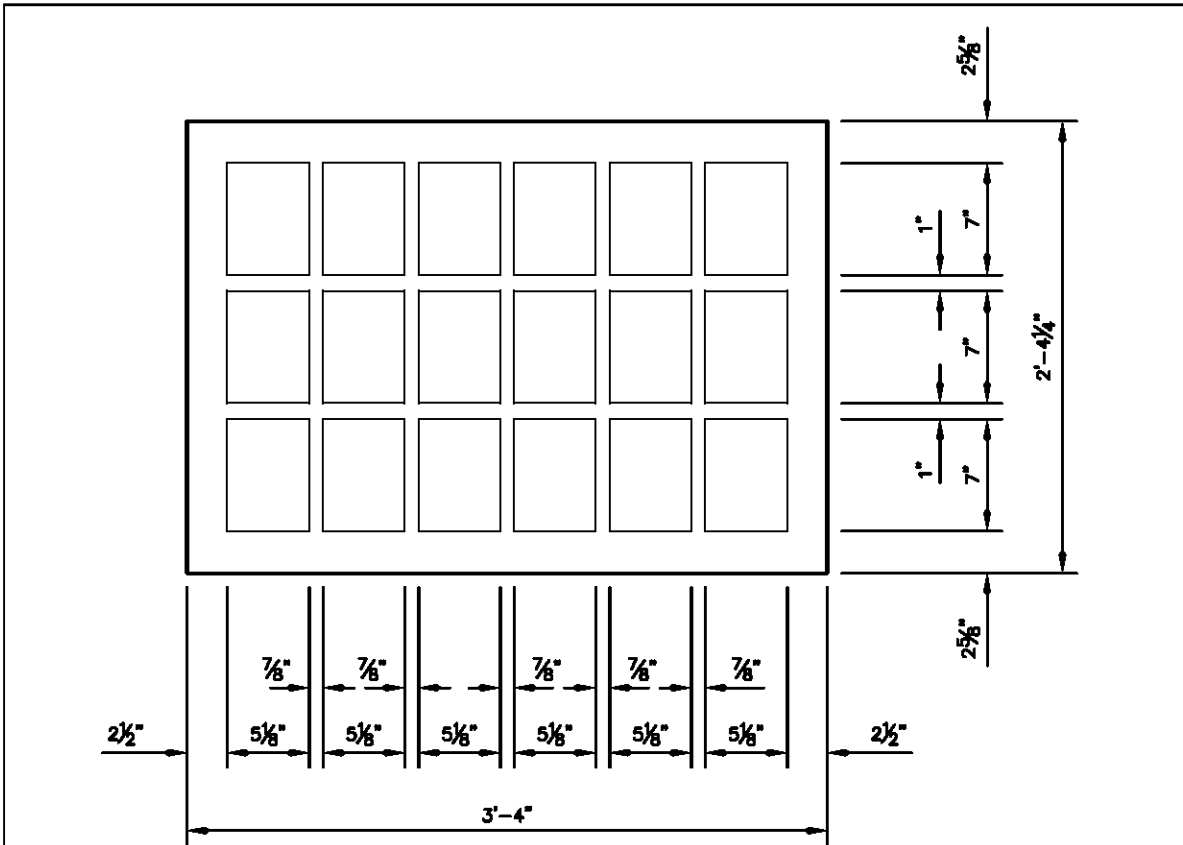

TYPE "B" GRATE

SCALE: 1"=1'

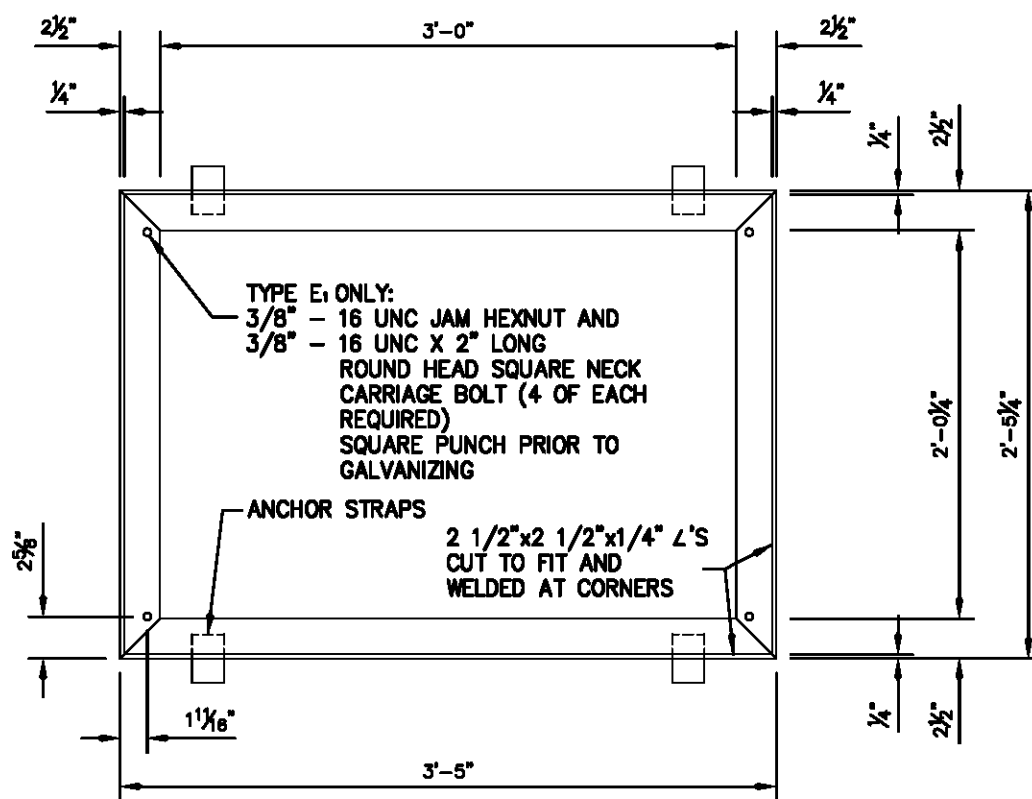

TYPE "E" FRAME


SCALE: 1"=1'

### GENERAL NOTES:

DIMENSIONS RELATING TO REINFORCING STEEL ARE TO BAR CENTERS.

VERTICAL REINFORCING STEEL MAY BE SPLICED. SPLICE LENGTH IS 35 DIAMETERS.

CATCH BASIN TOPS & INVERTS		
DESCRIPTION	TOP	INVERT
CB01-1	119.50	115.50
CB01-2	119.50	114.70
CB01-3	119.50	114.00
CB01-4	119.50	115.50
CB01-5	119.50	115.00
CB01-6	119.50	114.60
CB01-7	119.50	1164.20

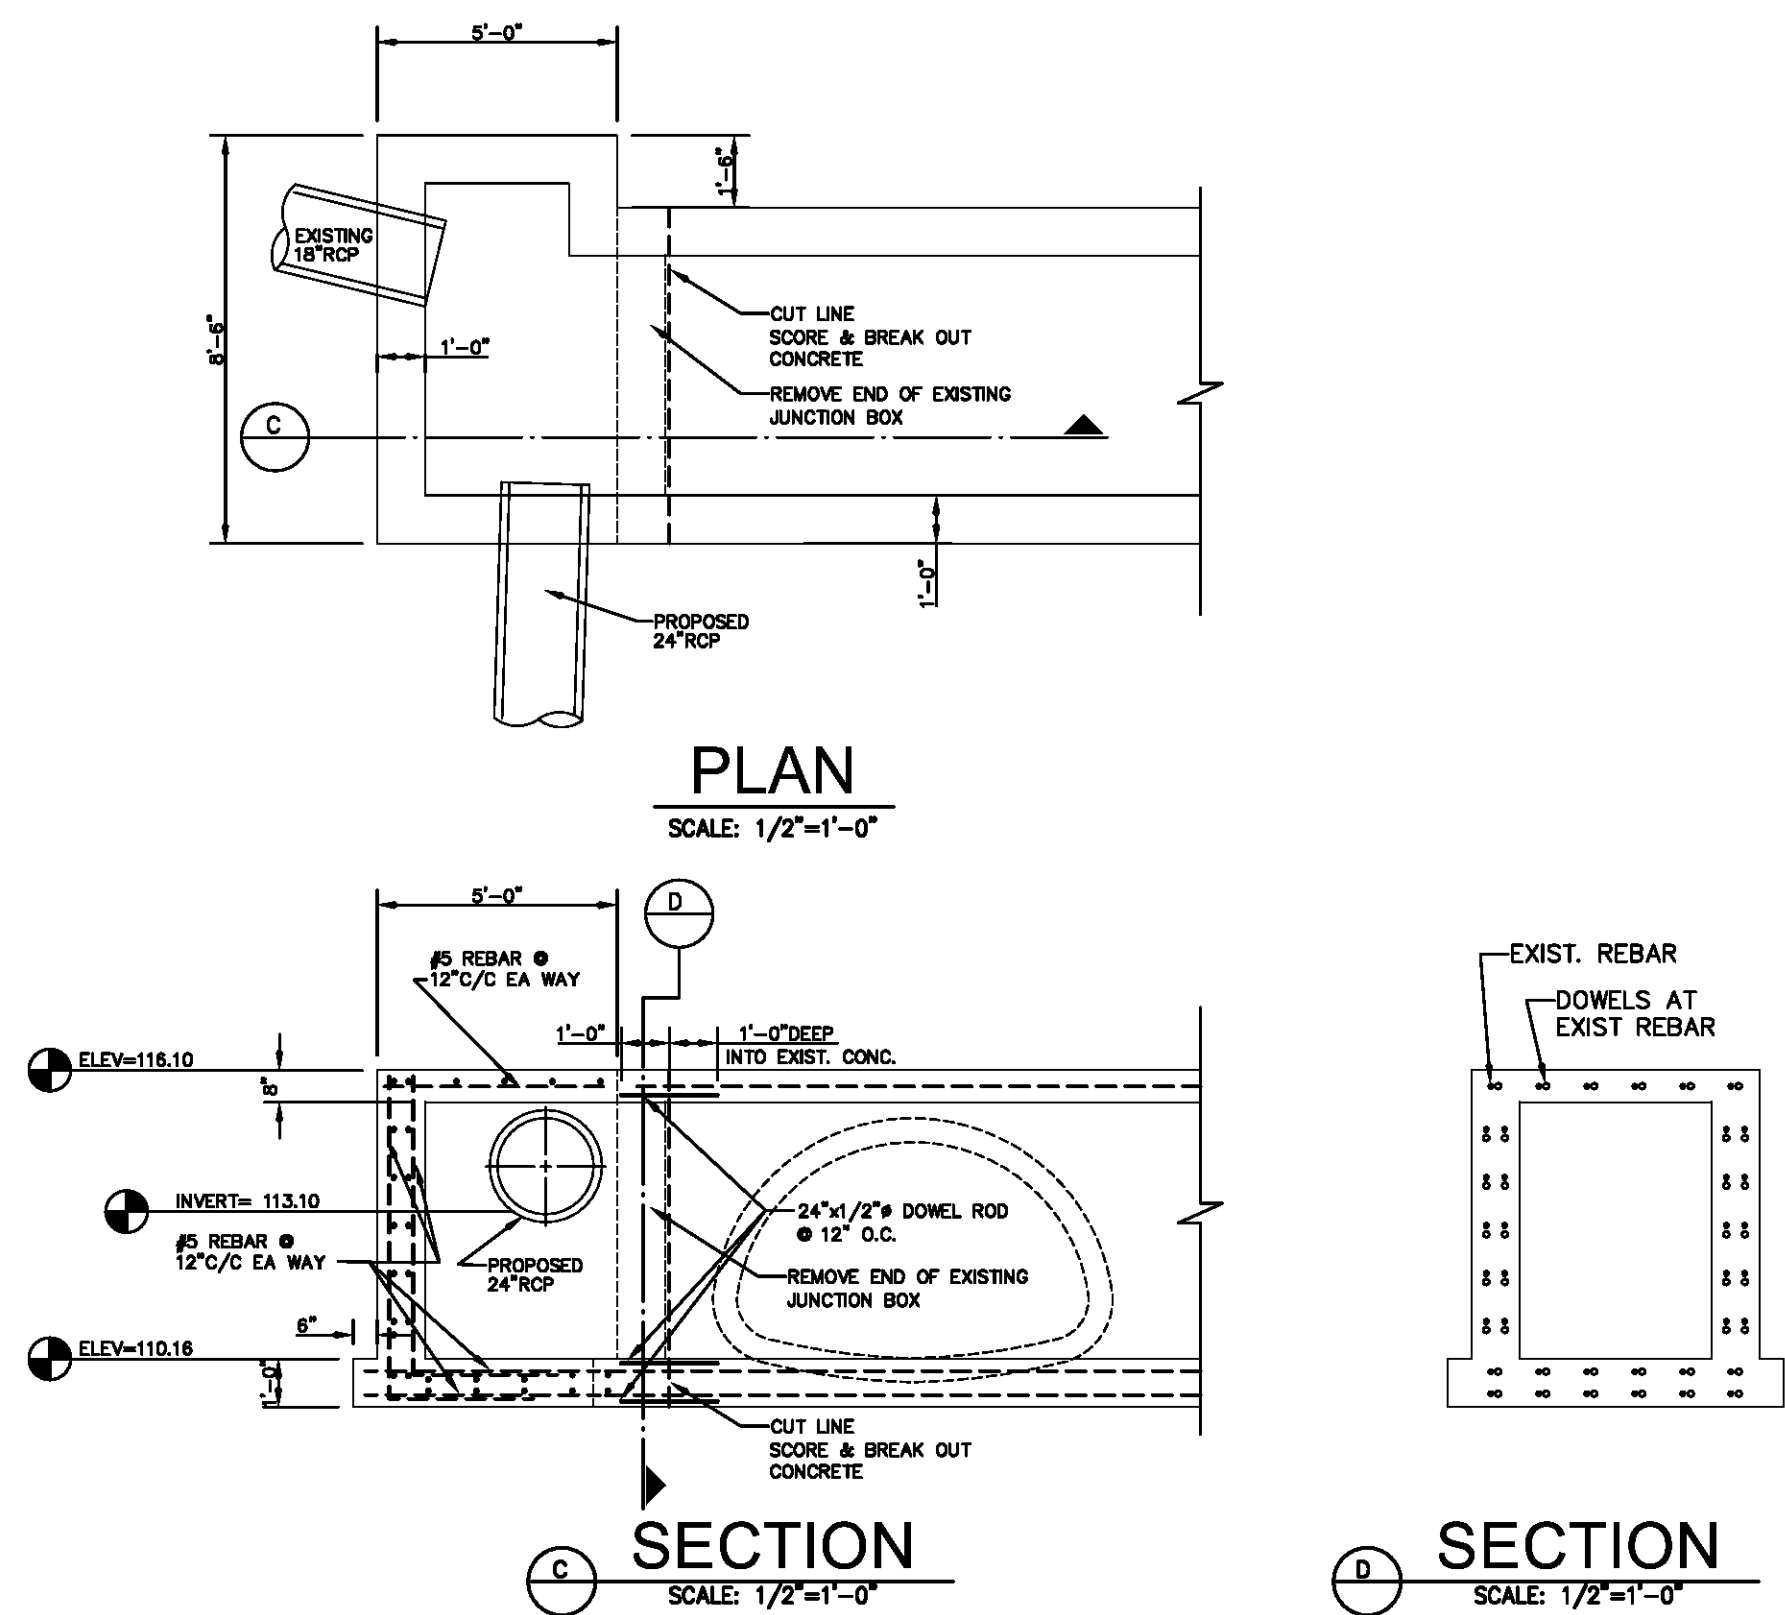

PLAN  
SCALE: 1/2"=1'-0"

SCALE: 1/2"=1'-0"

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SCALE: 1/2"=1'-0"

SCALE: 1/2"=1'-0"

SCALE: 1/2"=1'-0"

SCALE: 1/2"=1'-0"

### REFERENCE DRAWINGS:

C-101 GRADING & DRAINAGE PLAN  
C-103 HORIZONTAL CONTROL PLAN

SEALS:

STATE OF LOUISIANA

RALPH WAYNE MCMICKLE

REGISTERED PROFESSIONAL ENGINEER IN CIVIL ENGINEERING

9/15/10

NOTES:

NO

DATE

REVISION

DESIGN BY :

CNH

DRAW BY :

RSH

PROJECT NAME

Hampton Inn  
Main Street  
West Monroe, Louisiana

DRAWING TITLE

GRADING & DRAINAGE  
DETAILS

JOB NO.

2010-14

DATE

07-08-10

SCALE

AS SHOWN

DRAWING NO.

C-102

REV