


NOTE:


PROVIDE SMOKE DETECTORS AND HEAT DETECTORS IN THE ELEVATOR EQUIPMENT ROOM AND ELEVATOR SHAFT (AT THE TOP AND BOTTOM OF THE ELEVATOR SHAFT) AS REQUIRED BY THE LOCAL ELEVATOR INSPECTOR AND THE LOCAL FIRE MARSHALL. THE SMOKE DETECTORS SHALL INITIATE THE ELEVATOR RECALL CONTROLS. THE HEAT DETECTORS SHALL BE SUPPLIED POWER BY A SUPERVISED CIRCUIT FROM THE FIRE ALARM CONTROL PANEL. THE HEAT DETECTORS SHALL ACTIVATE THE SPRINKLER SYSTEM SOLENOID VALVE AND ALSO AUTOMATICALLY TRIP THE OVER CURRENT DEVICE SUPPLYING THE MAIN POWER TO THE ELEVATOR EQUIPMENT.

THE SMOKE DETECTORS IN THE ELEVATOR LOBBIES SHALL ALSO INITIATE THE ELEVATOR RECALL CONTROLS.

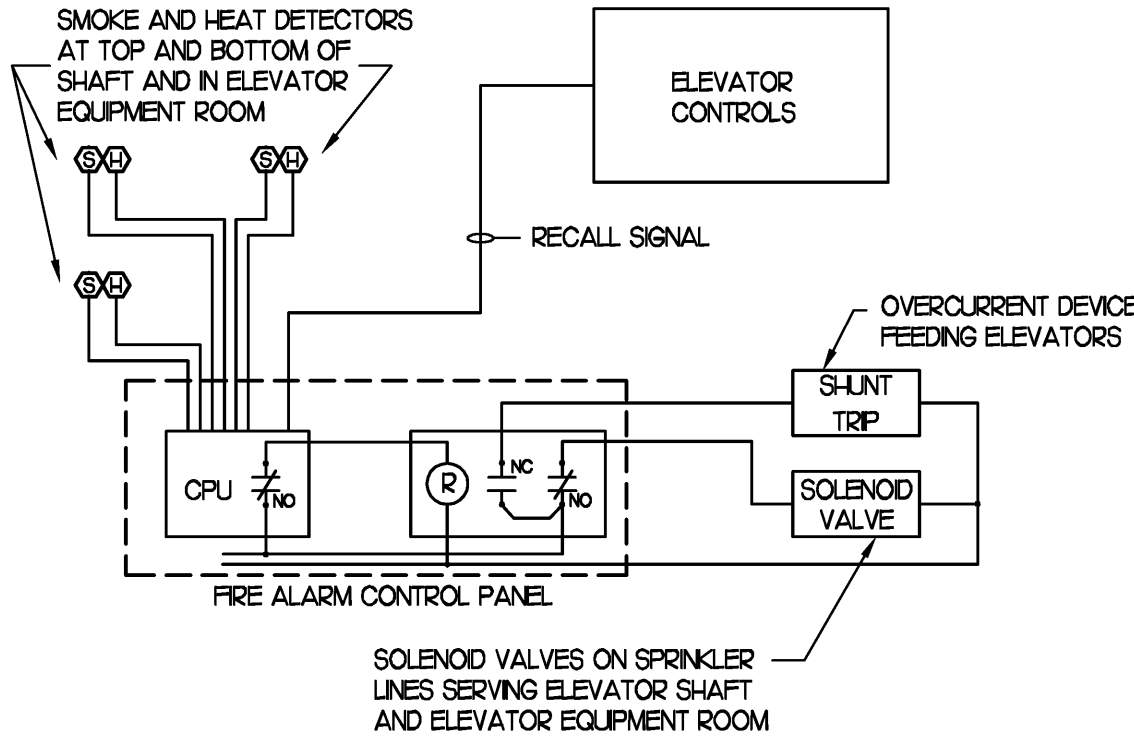


ELEVATOR CIRCUIT BREAKER AND SOLENOID VALVE CONTROLS  
SCHEMATIC - NO SCALE



FIRE ALARM SYSTEM LEGEND	
SYMBOL	DESCRIPTION
	FIRE ALARM SYSTEM BREAKGLASS STATION -- MTD UP 48" AFF
	FIRE ALARM SYSTEM AUDIO / VISUAL DEVICE -- MTD UP 84" AFF.
	FIRE ALARM SYSTEM CONTROL PANEL
	FIRE ALARM SYSTEM HEAT DETECTOR
	FIRE ALARM SYSTEM SMOKE DETECTOR
	FIRE ALARM SYSTEM DUCT SMOKE DETECTOR
	FIRE ALARM SYSTEM STROBE LIGHT -- MTD UP 84" AFF
	FIRE ALARM SYSTEM SYSTEM MINI-HORN -- MTD UP 84"
	FIRE ALARM SYSTEM MINI-STROBE IN GUESTROOM BATH MTD UP 84"
	FIRE ALARM SYSTEM CARBON MONOXIDE DETECTOR
	FIRE ALARM SYSTEM REMOTE ANNUNCIATOR
	FIRE ALARM SYSTEM MAGNETIC DOOR HOLDER
	FIRE ALARM SYSTEM FLOW SWITCH
	FIRE ALARM SYSTEM TAMPER SWITCH
	FIRE ALARM SYSTEM SMOKE DETECTOR W / AUXILIARY CONTACTS FOR ELEVATOR RECALL

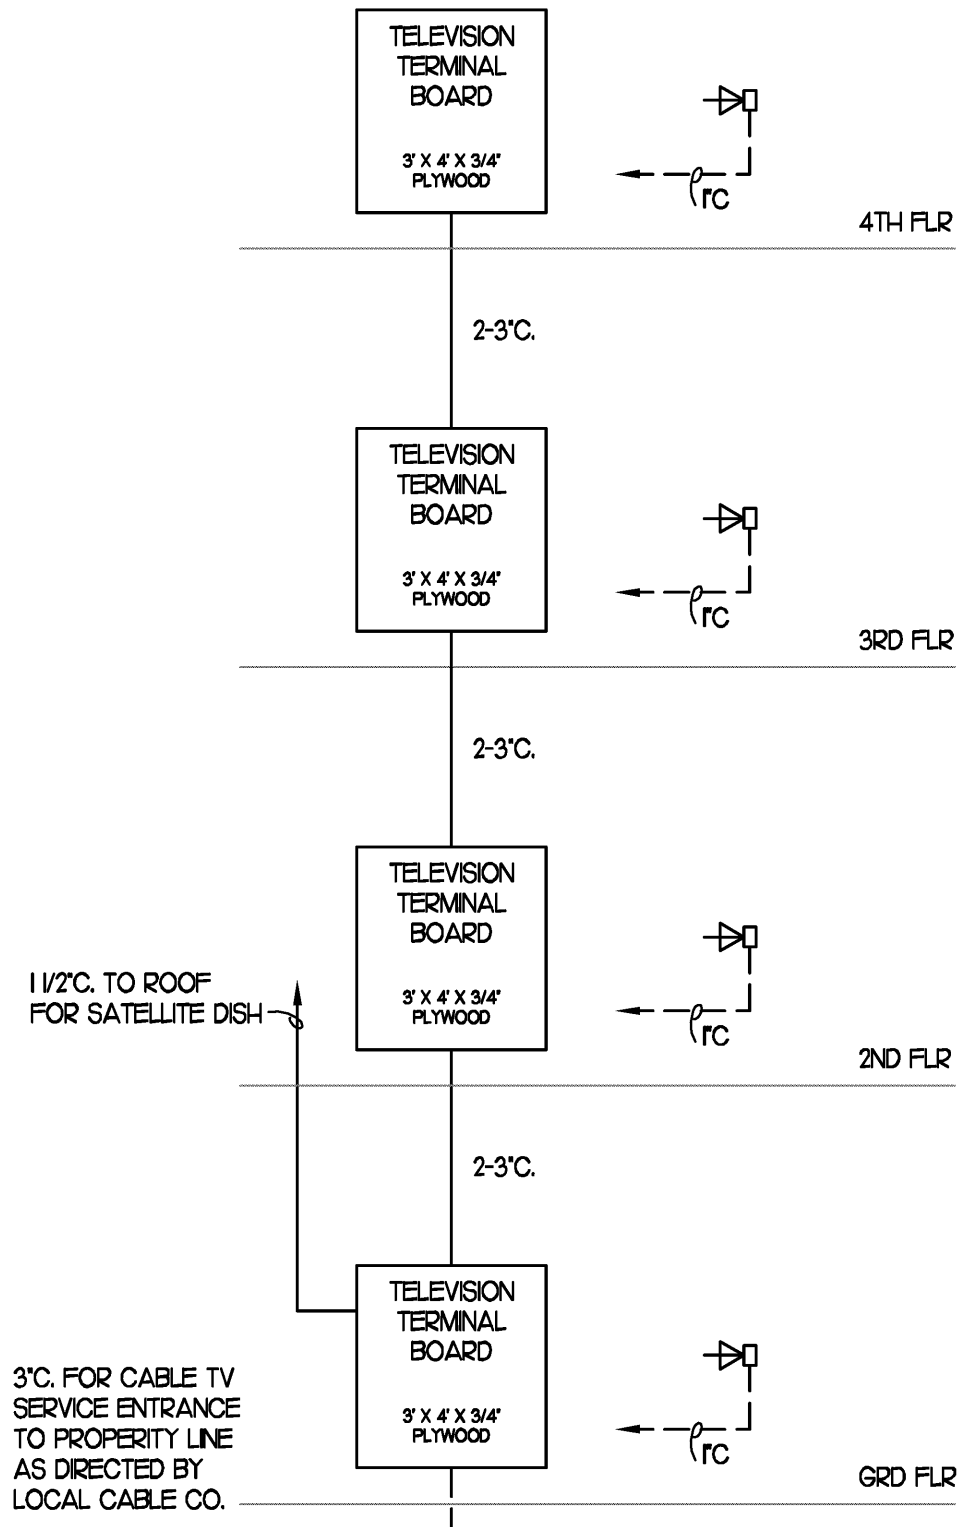


TELEVISION CONDUIT DIAGRAM  
SCHEMATIC - NO SCALE

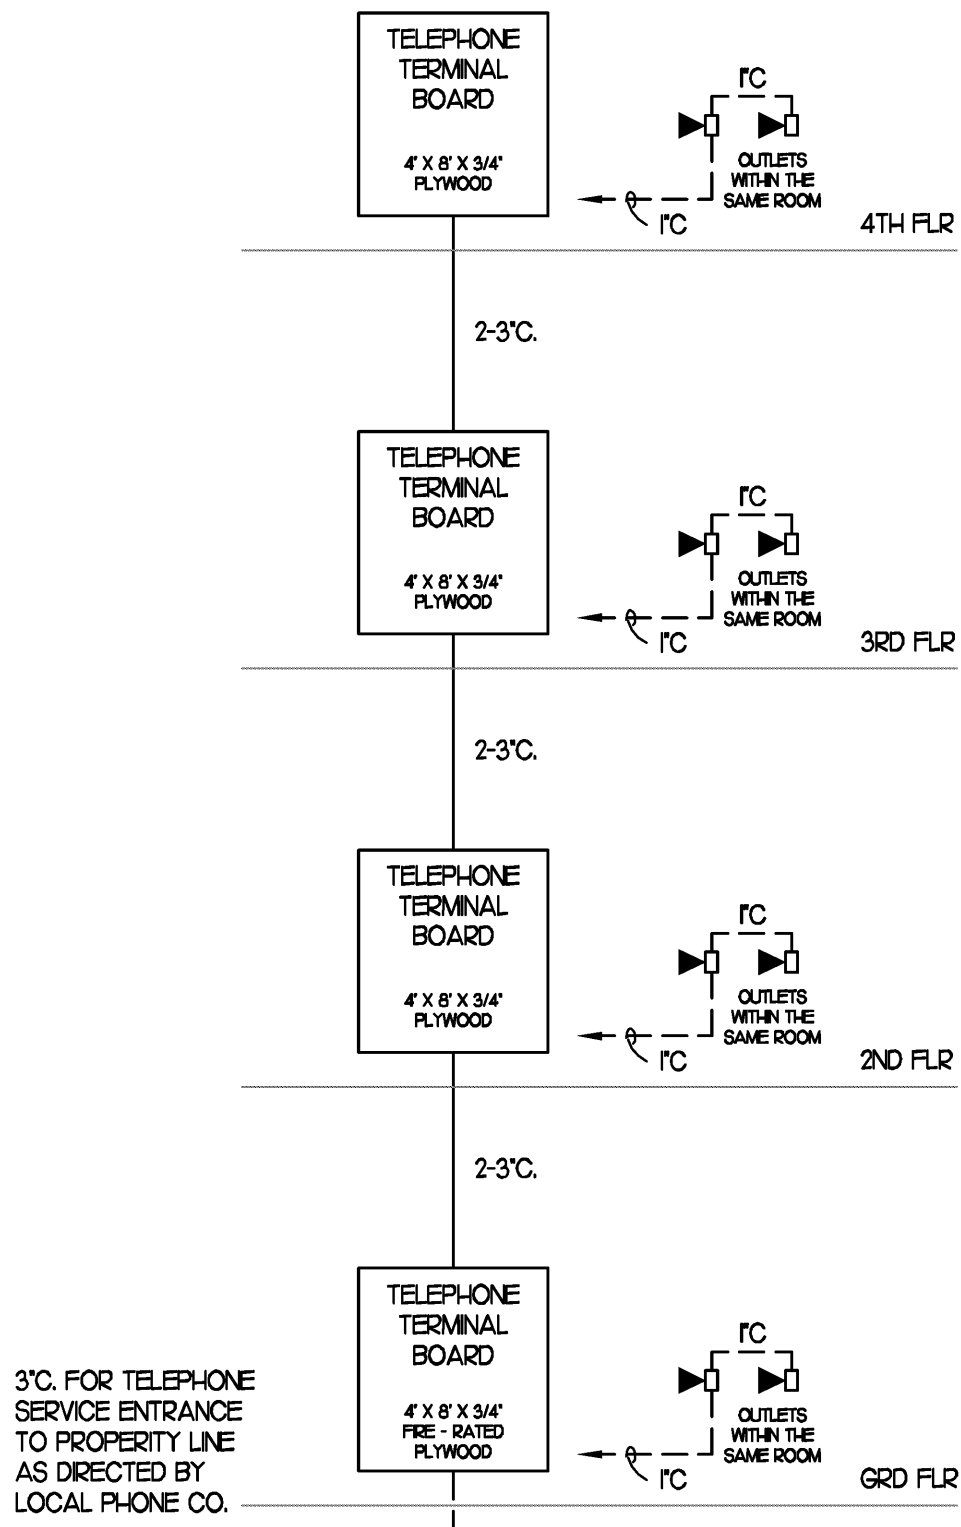

TELEPHONE CONDUIT DIAGRAM  
SCHEMATIC - NO SCALE

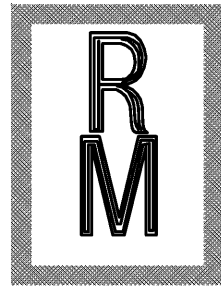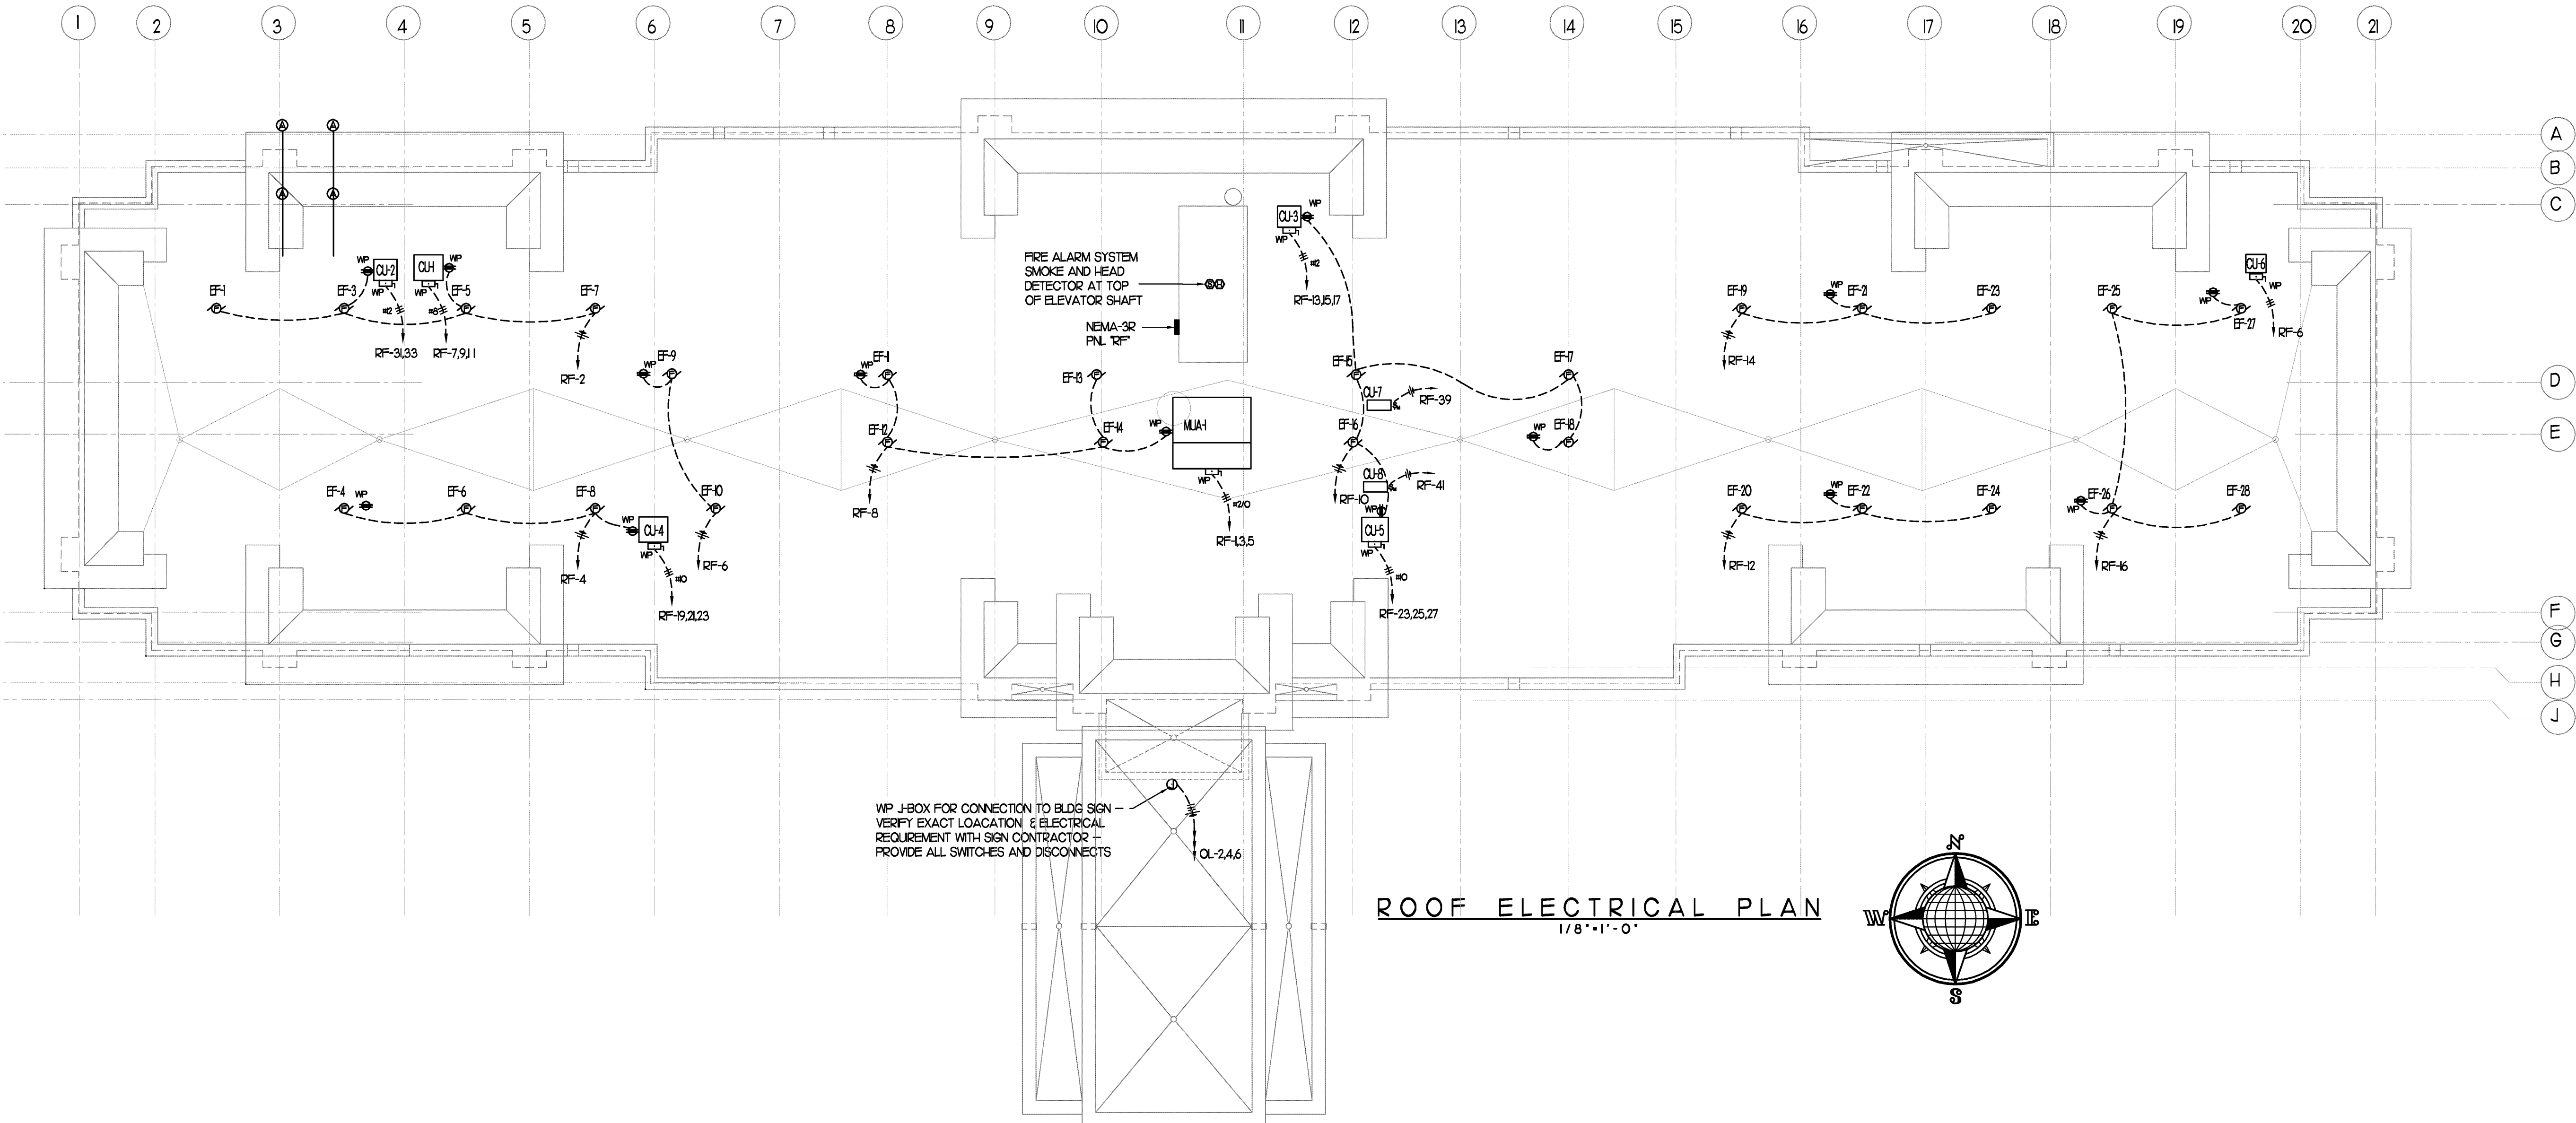

Richard Molenaar  
ARCHITECT

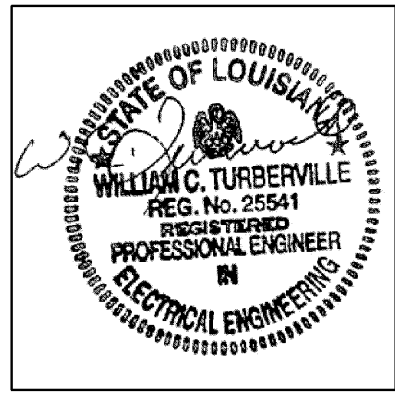

PROJECT NAME:  
**Hampton Inn**  
Maine Street  
West Monroe, Louisiana

SHEET TITLE:  
**ROOF ELECTRICAL PLAN**

Scale: 13/32" = 1' - 0"

PROJECT NO.  
09017

LATEST REVISION:

DRAWN BY:  
SMJ

CHECKED BY:  
SMJ

SHEET NUMBER:

DATE:  
09/13/10

E205