
TYPE	MFR. & MODEL	REMARKS
CD LAY-IN	PRICE ASCDA	ADJUSTABLE LOUVERED FACE, ALUMINUM CONSTRUCTION WITH 4 CONES, LAY-IN T-BAR FRAME (TYPE 3) AND OPPOSED BLADE DAMPERS.
CD SURFACE	PRICE ASCDA	ADJUSTABLE LOUVERED FACE, ALUMINUM CONSTRUCTION WITH 4 CONES, SURFACE MOUNTING FRAME (TYPE 3), 12×12 OR 24×24 AMF FRAME FOR SURFACE MOUNTING, AND VCR9 OPPOSED BLADE DAMPERS.
RAG/EAG CEILING	PRICE APDDR	FLUSH PERFORATED FACE, ALUMINUM FACEPLATE WITH MAXIMUM SQUARE NECK FOR PLENUM RETURN AND FRAME FOR LAYIN CEILING OR SURFACE MOUNTING WITH 12×12 OR 24×24 AMF FRAME.
SAR	PRICE 620-S	DOUBLE DEFLECTION SIDEWALL, ALUMINUM CONSTRUCTION, 3/4" BLADE SPACING WITH FRONT BLADES PARALLEL TO THE SHORT DIRECTION, SURFACE MOUNTING FRAME AND VCS3 OPPOSED BLADE DAMPER.
RAG/EAG SIDEWALL	PRICE 635D	FIXED LOUVERS (FULL FACE, NO FILLER PANELS) ½" SPACING AT 45" DEFLECTION, ALUMINUM CONSTRUCTION, FRAME FOR SURFACE MOUNTING.
DG	PRICE ATG1-BF	HEAVY DUTY ALUMINUM DOOR GRILLE WITH SIGHTPROOF APPEARANCE AND FLAT BORDER FRAME BOTH SIDES.

NOTE:

- CONTRACTOR SHALL EXAMINE AND COORDINATE WITH ALL COMPONENTS 1. OF BUILDING CONSTRUCTION PRIOR TO LOCATING & SETTING OF H.V.A.C. EQUIPMENT AND NOTIFY ARCHITECT OF ANY CONFLICT WHICH MAY INTERFERE WITH LOCATION OF EQUIPMENT, STRUCTURE OR WORK OF OTHER TRADES.
- 2. CONTRACTOR SHALL COORDINATE W/ ARCHITECTURAL REFLECTED CEILING PLAN FOR VARIOUS CEILING TYPES AND SHALL BE RESPONSIBLE FOR FURNISHING TYPE OF FRAME STYLE NEEDED. I.E. LAY-IN OR SURFACE MOUNT.
 - 3. SMOKE DETECTOR SHALL BE FURNISHED, INSTALLED AND WIRED BY THE MECHANICAL CONTRACTOR, IN THE RETURN AIR DUCTS OF ALL UNITS PER CODE, AND SHALL SHUT DOWN UNIT & SHALL CAUSE A VISUAL & AUDIBLE SIGNAL, SIMPLEX 4098-9687 W/ 4098-984 CONTROL STATION, & SHALL BE IDENTIFIED AS "AIR DUCT DETECTOR TROUBLE".
 - 4. REFRIGERANT PIPE SIZES SHALL BE AS RECOMMENDED BY THE EQUIPMENT MANUFACTURER.
 - 5. ALL AHU'S TO BE SET ON RAISED PLATFORMS.

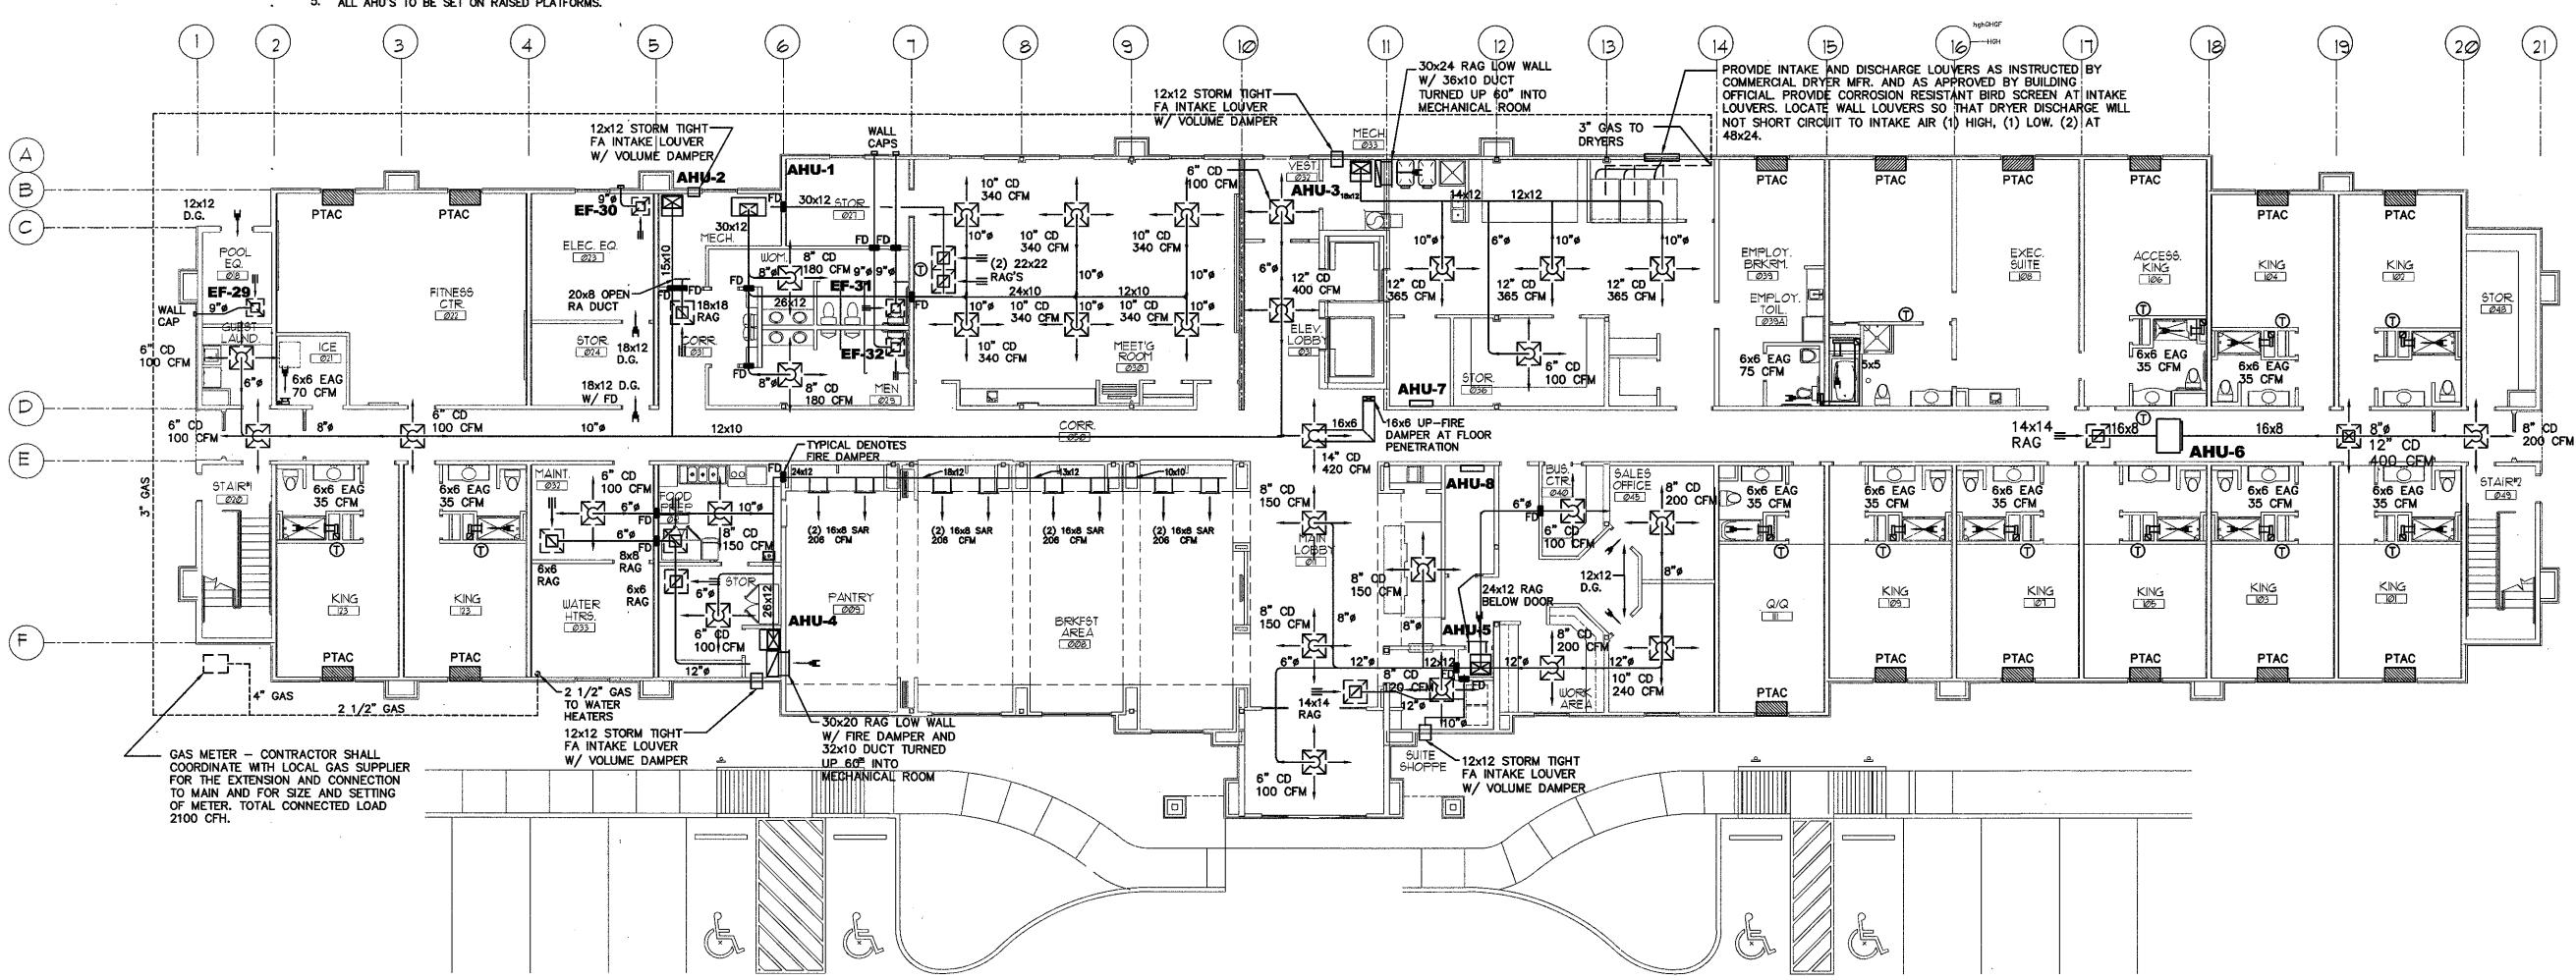


РТ/	AC H	IEA1	ΓΡ	JMF	AIR C	:ON	
MARK	ARK TOTAL CFM		COOLII ENT. /	NG COIL AIR WB F	DATA TOTAL CAPACITY AMB		
PTAC	270	35	80 ° F	67 ° F	8.900	95'F	

ACCESSORIES: (1) ELECTRICAL SUBBASE, (2) CONDENSATION EVAPORATION SYSTEM AND SECONDARY DRAIN KIT, EXTEND AND CONNECT TO DRAIN PIPE PROVIDED BY PLUMBER, COORDINATE WITH PLUMBER. (3) CONTROLS SHALL PREVENT OPERATION OF COMPRESSOR AND ELECTRIC HEAT AT THE SAME TIME, (4) ARCHITECTURAL DECORATIVE LOUVER, AS MANUFACTURED BY RELIABLE PRODUCTS. LOUVERS SHALL BE CONSTRUCTED OF ALUMINUM WITH CUSTOM FINISH AS DIRECTED BY THE ARCHITECT, (5) REMOTE MOUNTED THERMOSTAT. EQUAL TO INNCOM MODEL E4-SMART DIGITAL THERMOSTAT. REMOTE THERMOSTAT DOES NOT REQUIRE CONDUIT.

GROUND FLR AIR BALA	NCE	SCHE	DULE
ROOM EXHAUST	1	420	CFM
PUBLIC RR EXH	=	500	CFM
MISC. EXHAUST	=	585	CFM
TOTAL EXHAUST	Ξ	1,505	CFM
OSA THRU AC UNITS	=	1,085	CFM
OSA THRU MUA UNIT	-	420	CFM
TOTAL OSA	=	1,505	CFM
BALANCED AIR FLOW			

HEATING AND AIR CONDITIONING SCHEDULE																
AIR HANDLING UNIT										CONDENSING UNIT						
đ.	MFR. & MODEL	TOTAL CFM	O.S.A. CFM	TOTAL COOLING	SENSIBLE COOLING	E.S.P.	VOLTAGE	H.P.	ELEC HT KW	SINGLE POINT CONNECTION MCA	MFG & MODEL	M.C.A.	COMP. R.L.A.	FAN F.L.A.	VOLTAGE	REMARKS
AHU-1	TRANE TWE090E3	2400	450	76,500	58,100	.8"	208/3/60	1.5	2-STAGE 18.71	72	CU-1 TRANE TTA073D3	31.1	22.4	3.1	208/3/60	COMPLETE W/ WALL MOUNTED 2-STAGE HEAT, T'STAT WITH TIME DELAY AND HARD START KIT.
AHU-2	TRANE 4TEH3F30B	800	120	22,400	17,300	.7"	208/1/60	1/3	5.76	38	CU-2 TRANE 4TTB3024A1	12.0	8.8	0.7	208/1/60	COMPLETE W/ WALL MOUNTED T'STAT WITH TIME DELAY AND HARD START KIT.
AHU-3	TRANE 4TEH3F36B	1200	175	36,500	26,400	.6"	208/1/60	1/2	5.76	40	CU3 TRANE 4TTA3036A3	15.0	11.5	0.7	208/3/60	COMPLETE W/ WALL MOUNTED T'STAT WITH TIME DELAY AND HARD START KIT.
AHU-4	TRANE 4TEH3F60B	2000	240	59,700	43,400	.6*	208/3/60	1.0	7.20	37	CU-4 TRANE 4TTA3060A3	24.0	18.1	1.3	208/3/60	COMPLETE W/ WALL MOUNTED T'STAT WITH TIME DELAY AND HARD START KIT.
AHU-5	TRANE 4TEH3F48B	1400	100	41,800	29,500	.7"	208/3/60	3/4	7.2	37	CU-5 TRANE 4TTA3042A3	18.0	13.5	1.3	208/3/60	COMPLETE W/ WALL MOUNTED T'STAT WITH TIME DELAY AND HARD START KIT.
AHU-6	FIRST CO. 18HX-5	600	80	17,300	13,300	.2"	240/1/60	1/8	5.0	30	CU-6 TRANE 4TTB3018A1	9.0	6.4	0.7	208/1/60	COMPLETE W/ WALL MOUNTED T'STAT WITH TIME DELAY AND HARD START KIT.
AHU7	SANYO KS0971	250	0	9,000	7,650	.1"	115/1/60	13.8W			CU7 SANYO CO971		6.55	0.6	115/1/60	COMPLETE W/ WALL MOUNTED T'STAT, WITH TIME DELAY AND HARD START KIT.
AHU-8	SANYO KS0971	250	ο	9,000	7,650	.1*	115/1/60	13.8W			CU8 SANYO C0971		6.55	0.6	115/1/60	COMPLETE W/ WALL MOUNTED T'STAT, WITH TIME DELAY AND HARD START KIT.

AC UNIT ACCESSORIES: I. 7-DAY PROGRAMMABLE THERMOSTAT

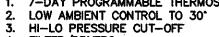

4. FILTER/DRYERS LIQUID LINE SOLENOID

HARDSTART KIT

7. AUX. DRAIN PAN 8. SMOKE DETECTOR IN RA DUCT

NDITIONER SCHEDULE ELECTRIC HEATER ELECTRICAL MAX FUSE DATA (MCA) EER REMARKS VOLTAGE KW 230/208V. 19.4 /1/60 208/1 20 AMP AMANA PTH093E35 12.0 3.5 208/1/60

3/32"=1'-0"

GROUND FLOOR PLAN







PROJECT NAME:



West Monroe, Louisiana

SHEET TITLE: **GROUND FLOOR** HVAC

project no. PROJ#		LATEST REVISION:	\sum
drawn by: RHP	CHECKED BY: HIP	SHEET NUMBER:	
DATE: 09-13-1		M10 1	