

# HOLIDAY INN EXPRESS & SUITES

A503 King & King Suite

A520 Stair Details

A504 Accessible King Suite & King X wide

Administrative Area Layout

Casework Types and Details

A522 Pool, Restrooms and Elevator

Interior Elevations

Interior Elevations

Casework Details

Casework Details

Casework Details Casework Details Room Schedule

Door & Window Schedule

Firewall Plan 1st Floor

A802 Firewall Plan 2nd Floor

A803 Firewall Plan 3rd Floor A804 Firewall Plan 4th Floor

A505 Accessible X wide King and Double Queen

Double Queen Suite and Accessible Double

## **ABBREVIATIONS**

ADJ	ADJACENT	MAX.	MAXIMUM
A.F.F.	ABOVE FINISH FLOOR	MECH.	
			PLUMBING
ALT.	ALTERNATE	MIN. or MN.	MINIMUM
ALUM	ALUMINUM	MISC.	MISCELLANEOU
APPROX.	APPROXIMATE	MNT.	MOUNT OR MOU
ARCH.	ARCHITECT	MTL	METAL
BD.	BOARD	N.I.C.	<b>NOT IN CONTRA</b>
BLDG.	BUILDING	NO.	NUMBER
C.A.	CLEAR ANODIZED	NOM.	NOMINAL
CEM.	CEMENT	N.S.F.S.	NEAR SIDE AND
CER.	CERAMIC	N.T.S.	NOT TO SCALE
C.G.	CORNER GUARD	O.C.	ON CENTER
C.J.	CONTROL JOINT	OD.	OUTSIDE DIAME
CLG.	CEILING	O.F.C.I.	OWNER FURNIS
C.M.U.	CONCRETE MASONRY UNIT		CONTRACTOR
COL.	COLUMN	OPP.	OPPOSITE
CONC.	CONCRETE	O.R.D.	<b>OVERFLOW ROO</b>
CONT.	CONTINUOUS	P.L. or PLAM	PLASTIC LAMINA
CORR.	CORRIDOR	PLYWD.	PLYWOOD
C.T.	CERAMIC TILE	PNT	PAINT
DET.	DETAIL	P.S.B.	PENCIL SHARPE
	DIAMETER		PRESSURE TRE
DIA.		P.T.	
DN.	DOWN	Q.T.	QUARRY TILE
D.S.	DOWNSPOUT	RAD.	RADIUS
DWG	DRAWING	R.D.L.	ROOF DRAIN LE
EA.	EACH	REINF	REINFORCEMEN
E.I.F.S.	EXTERIOR INSULATION	REQD.	REQUIRED
	AND FINISH SYSTEM	RES.	RESILIENT
E.J.	EXPANSION JOINT	RM.	ROOM
ELEC.	ELECTRICITY	R.D.	ROOF DRAIN
ELEV.	ELEVATOR	R.O.	ROUGH OPENIN
E.O.S.	EDGE OF SLAB	S.C.	SOLID CORE
EQ.	EQUAL	SCWD.	SOLID CORE WO
EXIST.		S.F.	SQUARE FEET
	EXISTING		
EXP.	EXPANSION	SHT.	SHEET
EXT.	EXTERIOR	SIM.	SIMILAR
F.D.	FLOOR DRAIN	ST.	STAIN
F.E.	FIRE EXTINGUISHER	STD.	STANDARD
F.E.C.	FIRE EXTINGUISHER CABINET		STAGGER TOP A
F.H.C.	FIRE HOSE CABINET	STL.	STEEL
FIN.	FINISH	STOR.	STORAGE
FL.	FLOOR	STRUCT.	STRUCTURE
F.O.B.	FACE OF BRICK	SUSP.	SUSPENDED
F.O.S.	FACE OF STUD	SYNTH.	SYNTHETIC
F.R.P.	FIBER REINFORCED	T.O.S.	TOP OF STEEL
1 .1 (.1 .	PANEL	TEL.	TELEPHONE
грт			
F.R.T.	FIRE RETARDANT TREATED	TEMP.	TEMPERED
F.S.	FLOOR SINK	THK.	THICKNESS
GALV.	GALVANIZED	TYP.	TYPICAL
GL.	GLASS	U.O.N. or U.N.O	UNLESS OTHER
GWB.	GYPSUM WALL BOARD	UTIL.	UTILITY
GYP.	GYPSUM	V.C.T.	VINYL COMPOSI
HGT	HEIGHT	VERT.	VERTICAL
HORIZ.	HORIZONTAL	V.W.C.	VINYL WALL COV
HR.	HOUR	WC.	WATER CLOSET
ID.	INSIDE DIAMETER	WD.	WOOD
ID.	ILACIDE DIVINE LEIV	L	*****

DUNTED RACT ND FAR SIDE 1ETER SHED INSTALLED OOF DRAIN NATE ENER BOARD EATED LEADER IENT ING VOOD AND BOTTOM

RWISE NOTED SITION TILE WATER PROOFING WEIGHT WELDED WIRE FABRIC W.W.F. WITH WITHOUT

**EXISTING** 

OCCUPANCY CLASSIFICATION: R1 TYPE OF CONSTRUCTION: IV-B; WOOD-FRAMED WITH WOOD FLOORS JOISTS (FULLY SPRINKLERED) MAXIMUM HEIGHT OF BUILDING: 52 FEET **ROOM LEGEND** GUESTROOM

12 9 0 1 3 2 0 0 0 1 1 1 1 0 0 30

SECOND FLOOR | 11 | 9 | 1 | 0 | 3 | 1 | 0 | 1 | 0 | 1 | 0 | 1 | 1 | 0 | 1 | 30

AREA (SQUARE FEET)

14, 776

14, 497

14, 497

14, 497

58, 267

FOURTH FLOOR | 13 | 8 | 0 | 1 | 2 | 2 | 0 | 0 | 1 | 0 | 0 | 1 | 1 | 1 | 0 | 30 39 26 1 2 8 5 1 1 1 1 1 4 3 1 1 95 ACCESSIBLE ROLLIN KING: 1 ACCESSIBLE ROOMS: 4 TOTAL NUMBER OF ACCESSIBLE ROOMS: 5 **TOTAL HEARING IMPAIRED ROOMS: 9** 

<u>FLOOR</u>

First Floor:

Third Floor:

Second Floor:

Fourth Floor:

GRAND TOTAL:

TOTAL NUMBER OF ROOMS: 95

TOTAL PARKING: 101 (INCLUDING 4 ADA)

TOTAL NUMBER OF FLOORS: FOUR

# MATERIAL LEGEND

MASONRY OPENING

INSULATION

JOIST

JOINT

LAMINATE


MACHINE

JST.

LAM. M.O.

MACH.

INSULATION

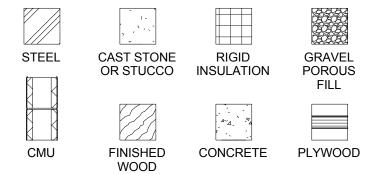

WOOD BLOCKING GYPSUM

OR FRAMING

### REQUIREMENT BY CITY OF SOUTHAVEN:

1. GENERAL CONTRACTOR TO PROVIDE THIRD-PARTY INSPECTIONS FOR THE FOUNDATION, FRAMING AND FIRE CAULKING FOR THE PROJECT. RESULTS OF INSPECTIONS NEED TO BE SUBMITTED TO ARCHITECT AND CITY OF SOUTHAVEN FOR APPROVAL.

Title Sheets			
Sheet #	Sheet Name		
T000	Cover		
T001	Code Information		
T002	UL Details		
T003	UL Details		
T004	UL Details		
T005	UL Details		
T006	ADA Details		
T007	ADA Details		
T008	Mounting Heights		

	Architectural Sheets		Structural Sheets
Sheet #	Sheet Name	Sheet #	Sheet Name
A001	Site Plan	S001	General Notes
A101	First Floor Plan	S002	General Notes
A102	Second Floor Plan	S003	Special Inspections
A103	Third Floor Plan	S101	Foundation and Floor Slab Plan
A104	Fourth Floor Plan	S201	2nd Floor Framing Plan
A105	Roof Plan	S202	3rd and 4th Floor Framing Plan
A201	First Floor RCP	S203	Roof Framing Plan
A202	Second Floor RCP	S301	Foundation, Section and Details
A203	Third Floor RCP	S302	Foundation, Section and Details
A204	Fourth Floor RCP	S401	Floor Framing Section & Details
A301	Elevations	S402	Floor Framing Section & Details
A302	Elevations	S501	Roof Framing Section & Details
A401	Sections	S502	Roof Framing Section & Details
A402	Sections	S601	Simpson ATS Details
A403	Sections	S602	Simpson ATS Elevations
A404	Wall Types		
A405	Roof Details		
A406	Canopy Details		
A407	Canopy Details		Mechanical Sheets
A501	Room Layouts	Sheet #	Sheet Name
A502	Room Layouts		

	Mechanical Sheets
Sheet #	Sheet Name
M001	Mechanical Legend & Schedules
M002	Mechanical Notes and Details
M003	Mechanical Details
M101	Mechanical 1st Floor Plan
M102	Mechanical 2nd Floor Plan
M103	Mechanical 3rd Floor Plan
M104	Mechanical 4th Floor Plan
M201	Mechanical Roof Plan
M301	Mechanical Enlarged Guestroom Plans
M302	Mechanical Enlarged Guestroom Plans

Civil Sheets

General Notes and Details

Grading and Drainage Plan

Water, Sewer & Storm Drain Details

Site Plan

Utility Layout

C3.2 Erosion Control Plan

C4.1 Construction Details

Sheet #

**Sheet Name** 

	Plumbing Sheets
Sheet #	Sheet Name
P001	Plumbing Notes and Legend
P002	Plumbing Schedule
P003	Plumbing Details
P004	Plumbing Details
P100	Plumbing Fisrt Floor Plan Sanitary and Storm
P101	Plumbing Fisrt Floor Plan Water and Gas
P102	Plumbing Second Floor Plan
P103	Plumbing Third Floor Plan
P104	Plumbing Fourth Floor Plan
P105	Plumbing Roof Plan

1 101	i lumbing i isit i looi i lan water and Cas
P102	Plumbing Second Floor Plan
P103	Plumbing Third Floor Plan
P104	Plumbing Fourth Floor Plan
P105	Plumbing Roof Plan
P201	Plumbing Enlarged Guest Room Plans Sanitary
P202	Plumbing Enlarged Guest Room Plans Sanitary
P203	Plumbing Enlarged Guest Room Plans Water
P204	Plumbing Enlarged Guest Room Plans Water
P205	Plumbing Enlarged Plans Sanitary
P206	Plumbing Enlarged Plans Water and Gas
P301	Plumbing Riser Diagrams Sanitary
P302	Plumbing Riser Diagrams Sanitary
P303	Plumbing Riser Diagrams Sanitary
P304	Plumbing Riser Diagrams Water

Electrical Sheets					
Sheet # Sheet Name					
E001	Electrical Specifications				
E002	Electrical Schedules				
E003	Electrical Details				
E004	Electrical Details				
E100	Site Plan-Electrical				
E100A	Site Plan-Photometrics				
E101	1st Floor Plan-Lighting				
E102	2nd Floor Plan-Lighting				
E103	3rd Floor Plan-Lighting				
E104	4th Floor Plan-Lighting				
E201	1st Floor Plan-Power				
E202	2nd Floor Plan-Power				
E203	3rd Floor Plan-Power				
E204	4th Floor Plan-Power				
E205	Roof Plan-Power				
E301	Enlarged Public Area Plan-Power				
E302	Enlarged Public Area Plan-Power				
E303	Enlarged Public Area Plan-Power				
E304	Enlarged Guest Room Plans				
E305	Enlarged Guest Room Plans				
E401	Telephone & Fire Alarm Riser Diagrams				
E402	Power Riser Diagrams				
E501	Electrical Panel Schedules				
E502	Electrical Panel Schedules				
E503	Electrical Panel Schedules				
E504	Electrical Panel Schedules				
E505	Electrical Panel Schedules				



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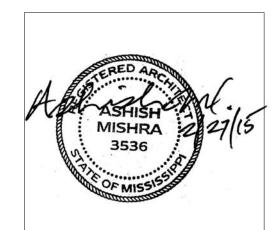
CIVIL: Benchmark Engineering and Surveying 101 Highpointe Court, Suite B Brandon, MS 39042 Phone: (601) 591-1077 Fax: (601) 591-0177 Email:mikebes@bellsouth.net

STRUCTURAL: WGPM, Inc. 11220 Elm Lane, Suite 201 Charlotte, NC 28277 Phone: (704) 542-7199 Fax: (704) 542-7195 Email: lwright@wgpminc.com

MEP: Allied Consulting Engineers 2905-D Queen City Drive Charlotte, NC 28208 Phone: (704) 399-3943 Email: asoler@allied-engineers.com

No. Date Description	R	/ISIONS
	o. Date	Description

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**KEY PLAN** 

Shiva Southaven

Holiday Inn Express & Suites

Lot 16 (Rev Lot 3) Southcrest Southcrest Subdivision Southaven, MS 38671

Drawing Title Cover

Construction Documents

Author Checked by Checker Date Feb. 27, 2015

Chapter 12 Interior Environment. Width 7'-0". Kitchens 3'-0". Furred Ceilings, 7'-0". 1210 Surrounding Materials. Exception 1 and 2, Dwelling and Sleeping Units, and toilet rooms not accessible to the public that do not contain more than one water closet. Chapter 13 Energy Efficiency. Chapter 14 Exterior Walls. Chapter 15 Roof Assemblies and Rooftop Structures. Membrane roof minimum slope is 1/4" per 1'-0". Chapter 25 Gypsum Board and Plaster. Compliance to be determined once final materials and locations to be determined. Chapter 26 Plastics. Chapter 29 Plumbing Systems. Table 2902.1 Required Plumbing Fixtures. B occupancy requires 1:25 then 1:50 water closets, 1:40 then 1:80 lavatories, 1:100 drinking fountains and 1 service sink. 2903.1 Separate water closet compartments shall be provided. Exception, single water closet rooms. Exception, single water closet rooms provided with a urinal. Chapter 30 Elevators and Conveying Systems. same shaft. Chapter 31 Special Construction, not applicable. Wall and floor fire rated construction. Typical Wood Floor Framing. Typical Roof Framing UL P522 1 Hour Fire Rating provided UL U906 2 Hour Fire Rating CMU Block wall with Stucco provided Typical Corridor walls. Interior CMU Bearing Walls. UL U914 3 Hour Fire Rating CMU block provided Additional code compliance requirements: to be combined with a mobility accessible room.

1109.4 Kitchens and Kitchenettes shall be accessible in accessible spaces or rooms. Kitchenettes is accessible

1109.5 Drinking Fountains. No fewer than 2 drinking fountains shall be provided in accessible spaces, one for standing people and one for people in wheelchairs. Exception, one drinking fountain that complies with the requirements of both people standing and in wheelchairs. One drinking fountain is provided and accessible complaint.

1203, Ventilation is provide through the mechanical ventilation system

1205 Natural light equal to 8% or the room floor or artificial light providing an average of 10 foot candles (107 Lux) measured at 30" above the floor.

1207 Sound Transmission. Common interior walls, floors and ceilings between dwelling units and adjacent areas or rooms shall be not less than STC 50. Owner requests STC 50.

1208 Interior Space Dimensions. Habitable spaces shall have the following minimum dimensions.

Ceiling height 7'-6". Kitchens, Bathrooms, Toilets, Storage and Laundries, 7'-0".

1210.1 Floors in Toilets, Bathing and Showers shall have a smooth, hard and none absorbing surface including a 4" wall base.

1210.2 Walls and partitions within 2'-0" of toilets and urinals shall have a smooth, hard and none absorbing surface extending up 4'-0" above the floor.

1210.3 Showers shall have a smooth, hard and non absorbing surface extending up 70" above the drain inlet.

Compliance with the International Energy Code is required.

Exterior Walls shall have an approved weather covering and class I, II or III vapor barrier depending on the cladding system.

Roof assemblies shall have an approved roof covering class C for type IIIB construction type or class B for type IV or VA construction types.

Roof insulation classification to comply with Table 1508.2 material standard for roof insulation.

Compliance to be determined once final materials and locations to be determined.

R1 occupancy requires 1 water closet and bathtub/shower per sleeping unit, Drinking fountain is not applicable and 1 service sink. A-2 occupancy requires 1:75 male water closets, 1:75 male water closets, 1:200 lavatories, 1:500 drinking fountains and 1 service sink.

2902.2 Separate facilities shall be provided for each sex. Exception, dwelling and sleeping units, where occupant load is less than 15.

2903.2 Urinal partitions shall be provided to provide privacy. Partitions shall be at least 18" off the wall or 6" beyond the urinal outer most lip and 12" to 60" off the floor.

3002.2 Where 4 or more elevators serve the all or the same portion of the building, they shall be separated into 2 hoist ways. No more than 4 elevators are permitted to occupy the

3002.4 Elevators in buildings 4 or more stories, at least one elevator shall provide for fire department emergency access to all floors. The elevator car shall be design for an

ambulance stretcher 24" wide by 84" long with 5" radius corners.

3004.1 Hoist way venting is required for elevators servicing more than 3 stories.

Exception 1, Hoist way venting is not required for R1 occupancies with an automatic sprinkler system.

3007 Fire Service Elevators are required in buildings per 403.6.1 exceeding 120' in height. Not applicable.

ICC File No. ER-3433 1 Hour Fire Rating provided

Typical Exterior walls (1 hour fire rating required at load bearing exterior walls). UL U356 1 Hour Fire Rating Wood Studs provided

UL U902 4 Hour Fire Rating CMU Block wall with face bricks or EIFS provided

UL U337 1 Hour Fire Rating Wood Studs bearing wall provided

Typical Demising Walls between guestrooms/guestrooms and bathrooms/bathrooms.

UL U311 1 Hour Fire Rating Wood Studs bearing wall provided

MUA and linen shafts 2 hour rated per UL U334 provided

Structural to determine locations on plywood/OSB building bracing, where required they are in addition to the defined partition types.

ICC ANSI A117.1 and ADA 2010. Guestrooms with communication features per table 224.4 requires 9 rooms be provided, dispersed equally among each room type. 1 is permitted

Owner furnished systems, equipment and furniture must be accessible compliant where requred.

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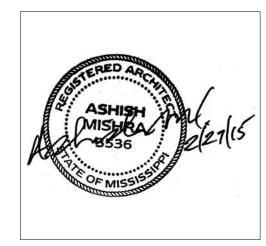
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Allied Consulting Engineers 2905-D Queen City Drive Charlotte, NC 28208 Phone: (704) 399-3943 Email: asoler@allied-engineers.com

REVISIONS		
No.	Date	Description

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**KEY PLAN** 

Shiva Southaven

Holiday Inn Express & Suites

Lot 16 (Rev Lot 3) Southcrest Southcrest Subdivision Southaven, MS 38671

Drawing Title Code Information

Construction Documents 14-081 Prepared by Author Checked by Checker

Review

Date Feb. 27, 2015

5 accessible rooms shall be type A units, all other shall be type B units only if intended to be occupied as a residence.

1109.2 Toilet and Bathing facilities, in each accessible toilet and bathing room at least one of each fixture type shall be accessible.

1107.2 Dwelling and Sleeping units shall comply with Chapter 10 of the ICC A117.1

1106 Parking spaces, Table 106.1 for 76 to 100 numbers of parking spaces provided 4 are required to be accessible. 5 accessible spaces are provided. 1106.5 Van accessible parking spaces, for every 6 required accessible space one shall be van accessible. 1 van accessible accessible spaces are provided.

1107.6 Table 1107.6.1.1 for buildings with 76 to 100 Dwelling and Sleeping units require 4 non roll in accessible showers and 1 roll in type accessible shower.


Exception 2, not required for Dwelling and sleeping units complying with 1107. All public/staff bathrooms are accessible where fittings and fixtures are accessible compliant.

Buildings with 101 to 150 Dwelling and Sleeping units require 5 non roll in accessible showers and 2 roll in type accessible shower. 5 accessible units are provided, all are combined roll in/non-roll in type. Required

1109.2.2 Water Closet compartments. Where six or more water closets or urinals are required, one additional accessible water closet compartment shall be provided. All public/staff bathrooms are accessible where

- 1. Gyp-Crete Gypsum Cement: Minimum 3/4" thick; density 100 pounds per cubic foot (minimum)
- 2. Subfloor: 5/8" plywood installed in accordance with the code
- 3. 2x10 wood joists at 16 o.c.
- 4. 2-1/2" fiberglass insulation; density, 1.5pcf (optional)
- 5. 1/2" deep by 1-1/2" wide, No. 25 gage resilient channels at 24" o.c. fastened to each joist with 1-1/4" long drywall screws
- 6. 5/8" gypsum board fastened to channel with 1" long drywall screws spaced at 12" o.c. All joints taped and sealed with compound

Note: In order to obtain 1-hour fire-resistive floor construction, the 1-1/2" wide No. 25 gage resilient channels must be fastened to each joist with 1-1/4" long Type W or S screws spaced 12" o.c. Additionally, the 5/8" Type 'X' gypsum wallboard must be fastened to channels with 1" long Type S screws.

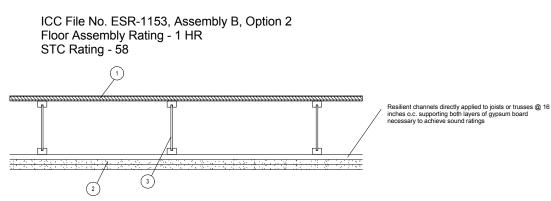

1. 48/24 tongue-and-groove span rated sheathing (Exposure 1), nailed and glued to the TJI joists with construction adhesive conforming to ASTM D3498


- 2. Two layers of 1/2" thick Type C, or 5/8" thick Type X gypsum board
- TJI Joist
- 4. Optional minimum 3-1/2" thick glass fiber insulation or glass fiber insulation rated R-30 or less, with resilient channels (not shown)

Note: In order to obtain an STC rating of 58, the assembly requires 3/4" gypsum concrete topping (minimum) and two layers of 5/8" thick Type X gypsum board with minimum 3-1/2" thick fiber insulation or glass fiber insulation rated R-30 or less.

Note: Assembly B, Option 2 has a minimum STC rating of 58 when constructed with resilient channels spaced at 16" o.c. to separate the ceiling membrane from the structural framing, and with a 3/4" floor topping of gypsum concrete recognized in a current evaluation report.

#### DESIGN NO. U902

#### Bearing Wall Rating -- 4 HR. Alternate Detail

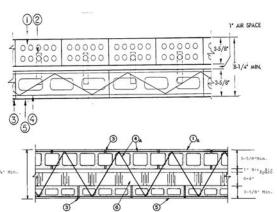

1. Clay Face Brick -- 3-5/8 in. wide by 2-1/4 in. high by 8 in. long.

1A. Concrete Blocks\* -- Various designs, Classification D-2 (2 h). See Concrete Blocks category for list of eligible manufacturers.

1 Brick Ties -- 3/4 in. wide, 7 in. long corrugated 26 MSG galv steel. Spaced one to each brick in every second course of blocks.

2 Mortar -- Bricks and blocks laid in full bed of mortar nom. 3/8 in. thick of not less than 2-1/4 and not more than 3-1/2 parts clean sharp sand to 1 part Portland cement (proportioned by vol) and not more than 50 percent hydrated lime (by cement vol). Vertical joints

**Reinforcement --** Parallel and diagonal rods, 0.150 in. min diam with welded joints a max 16 in. OC. Placed the width of concrete block wall in every second course of blocks alternately with brick ties.

4A. **Masonry Reinforcement** -- Prefabricated steel reinforcement, truss or ladder type, used for embedment in every second horizontal mortar joint. Placed the full width of wall assembly. Side and cross rods No. 9 (0.150 in.) min diam with welded joints a max 16 in. OC.


5. Concrete Blocks\* -- Nom 4 in. wide. OLDCASTLE PRECAST INC, DBA AMACOR PRECAST INC

Concrete Blocks. (Alternate to Hom 5). Verious designs Classification D. 2 (2 h.) See Concrete Blocks estagary for list of cligible.

Concrete Blocks -- (Alternate to Item 5) -- Various designs Classification D-2 (2 h). See Concrete Blocks category for list of eligible manufacturers.
6. Foamed Plastic\* -- (Optional -- Not shown with clay face brick detail) Rigid polystyrene insulation for use between brick and/or concrete blocks. One or more layers of rigid extruded polystyrene insulation, 4 in. thick max having 1 in. min air space with face brick or

THE DOW CHEMICAL CO OC CELFORTEC INC OWENS CORNING SPECIALTY & FOAM PRODUCTS --Type 150 or 250.


6A. Foamed Plastic\* -- (Optional-Not shown with clay face brick detail). Rigid polyisocyanurate insulation for use between brick and/or concrete blocks. One or more layers of rigid extruded polystyrene insulation, 4 in. thick max having 1 in. min air space with face brick or blocks. BPB AMERICA INC --Type Thermax \*Bearing the UL Classification Mark

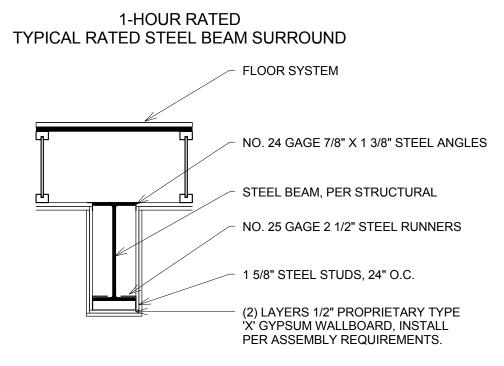

BASED ON GA FILE NO: BM 1137 1 HOUR RATED ASSEMBLY

### DESIGN NO. U906

## Bearing Wall Rating--2HR. Nonbearing Wall Rating--2HR.

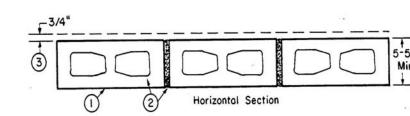

1. Concrete Blocks\* -- Nominal 6 by 8 by 16 in, hollow or solid. Classification D-2 (2 hr). ANCHOR CONCRETE PRODUCTS INC GAGNE & SON CONCRETE BLOCK INC Allowable compressive stress of 57% of max allowable compressive stress in accordance with the empirical design method. BETCO BLOCK & PRODUCTS INC, DBA ARTHUR WHITCOMB WESTBROOK CONCRETE BLOCK CO INC Allowable compressive stress of 75.6% of max allowable compressive stress in accordance with the empirical design method.

1 Mortar -- Blocks laid in full bed of mortar, nom. 3/8 in. thick, of not less than 2-1/4 and not more than 3-1/2 parts of clean sharp sand to 1 part Portland cement (proportioned by volume) and not more than 50 percent hydrated lime (by cement volume). Vertical joints staggered.


Portland Cement Stucco or Gypsum Plaster -- Add 1/2 hr to Classifi\hichcation if used. Attached to concrete blocks (Item 1).
 Foamed Plastic\* -- (Optional-Not Shown) -- 1-1/2 in. thick max, 4 ft wide sheathing attached to concrete blocks (Item 1).

BPB AMERICA INC --Type Thermax \*Bearing the UL Classification Mark

\*Bearing the UL Classification Mark

#### DESIGN NO. U914

#### Bearing Wall Rating--3HR. Nonbearing Wall Rating--3HR.

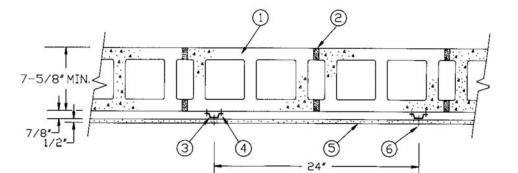

in concrete block of 1-3/8 in. and evaluated in accordance with ASTM E 488 to have ultimate load capacities of 980 lbs (tension) and 1400 lbs (shear) when used in 2000 psi concrete.

Concrete Blocks\* -- Various designs. Classification D-2 (2 hr). See Concrete Blocks category for list of eligible manufacturers.

Mortar -- Blocks laid in full bed of mortar, nom 3/8 in. thick, of not less than 2-1/4 and not more than 3-1/2 parts clean sharp sand to 1 part Portland cement (proportioned by volume) and not more than 50 percent hydrated lime (by cement volume). Vertical joints staggered.

**Furring Channels --** Min 0.019 in. thick (25 gauge) galv steel, 1-3/8 in. wide on top and 2-3/4 in. wide at bottom by 7/8 in. deep. Spaced 24 in. OC perpendicular to floor with a channel parallel to and approximately 3 in. above floor and 3 in. below ceiling. Clearance between vertical and horizontal channels 1/2 in. **Channel Fasteners --** 1-1/4 in. long masonry screws with 3/16 in. body and 5/16 in. diameter head. Fasteners spaced 24 in. O.C. with the fasteners staggered on each long leg of the furring channel.

4A. **Steel Framing Members\* --** (Not Shown) -- Alternate method used to attach furring channels (Item 3) to concrete blocks (Item 1). Clips spaced 48 in. OC., and secured to blocks with 1/4 in. dia. By 3 in. long concrete expansion anchor (Item 4B) through the center grommet. Ends of adjoining channels are overlapped 6 in. and tied together with double strand of No. 18 SWG galv steel wire near each end of overlap. As

concrete expansion anchor (Item 4B) through the center grommet. Ends of adjoining channels are overlapped 6 in. and tied together with double strand of No. 18 SWG galv steel wire near each end of overlap. As an alternate, ends of adjoining channels may be overlapped 6 in. and secured together with two self-tapping #6 framing screws, min. 7/16 in. long at the midpoint of the overlap, with one screw on each flange of the channel. Furring channels are friction fitted into clips.

PAC INTERNATIONAL INC --Type RSIC-1.

4B. Concrete Expansion Anchor -- (Not Shown) -- 1/4 in. dia. by 3 in. long carbon steel, pre-assembled, nail drive expansion anchor with mushroom head driven into the web of the concrete block. Min. embedment

5. Gypsum Board\* -- 1/2 in. thick, 4 ft wide, secured to furring channels with wallboard fasteners (Item 6). Gypsum plaster not more than 1/16 in. thick may be applied to wallboard in addition to joint treatment.

AMERICAN GYPSUM CO --Types AG-C, AGX-C. BPB AMERICA INC -- ProRoc Type C. BPB CANADA INC -- ProRoc Type C. CANADIAN GYPSUM COMPANY -- Types C, IP-X2, IPC-AR. G-P GYPSUM CORP, SUB OF GEORGIA-PACIFIC CORP -- Type 5. LAFARGE NORTH AMERICA INC -- Types LGFC-C, LGFC


C/A. NATIONAL GYPSUM CO -- Types FSK-C, FSW-C, FSMR-C. PABCO GYPSUM, DIV OF PACIFIC COAST BUILDING PRODUCTS INC -- Type PG-C. -- STANDARD GYPSUM L L C -- Type SG-C. TEMPLE-INLAND FOREST PRODUCTS CORP -- Type TG-C. UNITED STATES GYPSUM CO -- Types C, IP-X2, IPC-AR. USG MEXICO S ADE C V -- Types C, IP-X2, IPC-AR.


Wallboard Fasteners -- 1 in. long, self-drilling, self-tapping steel screws with bugle heads. Fasteners attached to each furring channel and spaced 8 in. OC at butt joints and 12 in. OC in the field of the board parallel with furring channels. Clearance between fasteners and edges of wallboard 3/4 in.
 Joint System -- (Not shown) -- Paper tape embedded in cementitious compound over joints. Paper tape and exposed screw heads covered with two layers of compound. Edges of compound feathered out.

\*Bearing the UL Classification Mark

# DESIGN NO. X526

1, 2, 3 and 4 hour

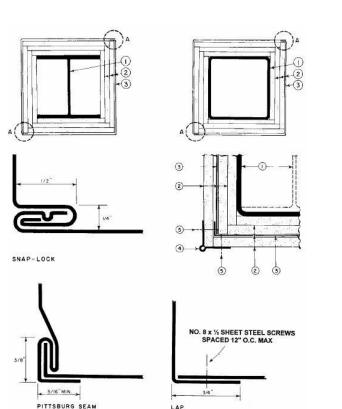

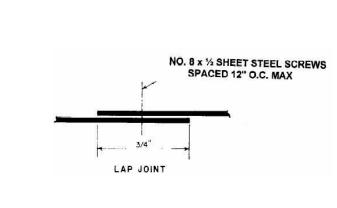

Steel Column -- Min sizes of W shape and tubular steel columns in the AISC Steel Construction Manual as shown under Item 2.
 Gypsum Board -- Any 5/8 in. thick or 1/2 in. thick wallboard bearing the Underwriters Laboratories Inc. Fire Resistance Classification Marking. Min total thicknesses of layers in inches for the various ratings and min column sizes are as follows:

### W Shape Columns Min Column Size Rating Hr Dsg Outside Flange Web In.2 Total Thkns of Dimen-Thkns Thkns Area Layers of Wallboard In. sions In. In.

W4x13 4-1/8x4 0.345 0.280 3.82 1 1-1/2 2-1/4 -- W6x15.5 6x6 0.269 0.235 4.56 1 1-1/2 2-1/4 3-1/8 W10x49 10x10 0.558 0.340 14.4 1/2 1-1/8 1-7/8 2-1/2 Tubular Shape Columns Min Column Size Rating Hr Outside Total Thkns of Dsg Dimensions Thkns In.2 Layers of Wallboard In. In.In.Area1 2 3 4 TS4X4X0.188 4X4 0.188 2.74 1 1-5/8 2-1/2 -- TS8X8X0.250 8X8 0.250 7.48 5/8 -- -- --

Applied in layers as shown in above illustration. Each layer held together with paper masking adhesive tape during erection to allow placement of succeeding layers. For column ratings of 2 hr or less, one layer of wallboard may be applied to the outer surface of steel cover. Boards applied vertically, without horizontal joints, attached to cover with screws located 1 in. from the board edge and 8 in. OC. See **Gypsum Board (CKNX)** category for names of manufacturers. 2A. **Gypsum Board\*** -- As an alternate to Item 2, 3/4 in. thick applied as described in Item 2. **CANADIAN GYPSUM COMPANY** -- Type IP-X3, ULTRACODE, UTRACODE SHC OR ULTRACODE WRC. **UNITED STATES GYPSUM CO** -- Type IP-X3, ULTRACODE, UTRACODE

SHC OR ULTRACODE WRC. **USG MEXICO S ADE C V** -Type IP-X3, ULTRACODE, UTRACODE SHC OR ULTRACODE WRC.

1 Steel Covers -- For seamed joints -- 0.024 in. min thickness (No. 24 MSG) uncoated, galv or stainless steel, for column ratings of 3 hr or less. For 4 hr ratings, only stainless steel cover to be used. Covers consist of two L-shaped sections with Snap-Lock or Pittsburgh sheet steel joints. Width to be determined on the basis of protection thickness and column size. Length of sections to provide 1/8 in. clearance per lineal foot of column length between cover and any restraint. For lapped joints -- (Max ratings 2 hr) -- No. 22 MSG (0.027 in. thick) uncoated or galv steel. Fasteners used at laps to be No. 8 by 1/2 in. steel sheet metal screws spaced a max of 12 in. O.C. Other details to be the same as those stated for seamed joints as shown above.

Corner Bead -- For columns with outer layer of wallboard attached to outside surface of metal cover, No. 28 MSG galv steel, 1-1/4 in. legs corner beads attached to wallboard with screws spaced 12 in. O.C.
 Screws -- For columns with outer layer of wallboard attached to out\hickside surface of metal cover, self-drilling Phillips bugle head, 1 in. long screws for 1/2 or 5/8 in. thick wallboard (1-1/4 in. long screws for 3/4 in. thick wallboard) are used to attach wallboard to steel cover, and corner bead to wallboard.

Sodium Silicate Solution -- (Not shown, optional) -- Used to adhere one layer of wallboard to inside of steel cover prior to assembly.

Finishing System -- (Not shown) -- Joint compound applied over cor

ner beads to a thickness of 1/16in. \*Bearing the UL Classification Mark



6800 S Creek Rd, Charlotte, NC 28277 Ph: (704) 625-6554 Fax: (704) 919-5822 EMAIL:ashish@mishraarch.com WEB: www.mishraarch.com


Benchmark Engineering and Surveying 101 Highpointe Court, Suite B Brandon, MS 39042 Phone: (601) 591-1077 Fax: (601) 591-0177 Email:mikebes@bellsouth.net

STRUCTURAL:
WGPM, Inc.
11220 Elm Lane, Suite 201
Charlotte, NC 28277
Phone: (704) 542-7199
Fax: (704) 542-7195
Email: lwright@wgpminc.com

MEP:
Allied Consulting Engineers
2905-D Queen City Drive
Charlotte, NC 28208
Phone: (704) 399-3943
Email: asoler@allied-engineers.com

No. Date Descript	ion

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KEY PLAN

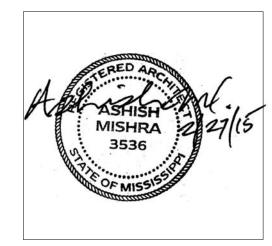Shiva Southaven

Holiday Inn Express & Suites

Lot 16 (Rev Lot 3) Southcrest Pkwy.
Southcrest Subdivision

Southaven, MS 38671

Drawing Title

UL Details

Phase
Construction Documents

 Project No.
 14-081
 Sheet No.

 Prepared by
 Author


 Checked by
 Checker

 Date
 Feb. 27, 2015

Review

ew

# DESIGN NO. U334 Bearing Wall Rating - 2 HR STC Rating -62 (See Item 7

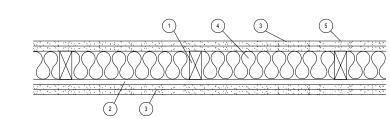

1. Wood Studs - Nom 2 by 4 in., spaced 16 in OC. Studs cross braced at mid-height and effectively fire stopped at top and bottom of wall.

2. Resilient Channel - 25 MSG galv steel, nom 2-1/2 in wide by 1/2 in deep. Resilient channels placed perpendicular to studs, spaced 24 in OC, flange portion attached to each intersecting stud with 1 in long Type S steel screws.

2A. Steel Framing Members (Optional, Not Shown)\* - As an alternate to Item 2, furring channels and resilient sound isolation clip as described below:

a. Furring Channels - Formed of No. 25 MSG glv steel 2-3/8 in wide by 7/8 in deep, spaced 24 in OC perpendicular to studs. Channels secured to stud as described in Item B. Ends of adjoining channels are overlapped 6 in and tied together with double strand of No. 18 SWG galv steel wire near each end of overlap. As an

overlap, with one screw on each flange of the channel.

b. Steel Framing Members\* - resilient sound isolation clips used to attach furring channels (Item a) to studs (Item 1). Clips spaced 48 in OC, and secured to studs with No. 8x 2 1/2 in coarse drywall screw through the center grommet. Furring channels are friction fitted into clips.

alternate, ends of adjoining channels may be overlapped 6 in and secured together with two self-tapping #6 framing screws, min 7/16 in long at the point of

PAC INTERNATIONAL INC- Type PSIC-1

3. Gypsum Board\* - 5/8 in. thick, 4 ft wide. Attach to furring channels: base layer with 1 in. long Type S steel screws spaced max 24 in. OC, face layer with 1-5/8 in long Type S steel screws spaced max 12 in OC. Attach to wood studs: base layer with 1-7/8 in long 6d coated nails spaced max 14 in OC, face layer with 2-3/8 in long 8d coated nails spaced 7 in OC. Base layers installed vertically. Face layers installed horizontally with butt joints offset 16 in from base layers.

AMERICAN GYPSUM CO - Types AG-C, AGX-C .
BPB AMERICA INC - ProRoc Type C.
CANADIAN GYPSUM COMPANY - Types C, IP-X2, IPC-AR.
G-P GYPSUM CORP, SUB OF GEORGIA-PACIFIC CORP - Type 5.
LAFARGE NORTH AMERICA INC - Types LGFC-C, LGFC-C/A.
NATIONAL GYPSUM CO - Types FSK-C, FSW-C, FSW-G.
PABCO GYPSUM, DIV OF PACIFIC COAST BUILDING PRODUCTS INC - Type C or PG-C.
STANDARD GYPSUM L L C - Type SG-C.
TEMPLE-INLAND FOREST PRODUCTS CORP - Type TG-C.
UNITED STATES GYPSUM CO - Types C, IP-X2, IPC-AR.
USG MEXICO S A DE C V - Types C, IP-X2, IPC-AR.

4. Batts and Blankets\* - Nom. 2 in thick mineral wool insulation, 96 in long, cut to 15 in widths, friction fitted between studs in wall cavity

THERMAFIBER L L C - Type SAFB

4A. Batts and Blankets\*- Glass fiber insulation. The cavities formed by the studs friction fit with R-19 unfaced fiberglass insulation batts measuring 6-1/4 in thick and 15-1/4 in wide. See Batts and Blankets\*(BZJZ) category for names of Classified Companies.

5. Joint Tape and Compound- Vinyl, dry or premixed joint compound, applied to joints, screw heads, and nail heads (two applications); paper tape, 2 in wide, embedded in first layer of compound over all joints


6. Caulking and Sealants- (not shown, optional) A bead of acoustical sealant applied around the partition perimeter for sound control

7. STC Rating- The STC rating of the wall assembly is 62 when it is constructed as described by Items 1 through 5, except:

a. Item 2A, above- Steel Framing Members\* shall be used to attach wallboard to studs on either the acoustical source or the receiving side of the wall assembly.
 b. Item 4A, above- Batts and Blankets\* as described above, fiberglass insulation shall be used

c. Item 6, above- Caulking and Sealants (not shown) A bead of acoustical sealant shall be applied around the partition perimeter for sound control

\*Bearing the UL Classification Mark

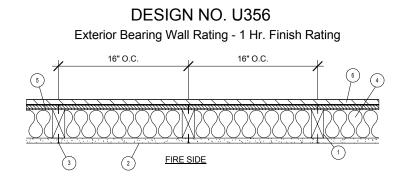

1. Wood Studs - Nom 2 by 4 in. spaced 16 in. OC with two 2 by 4 in. top and one 2 by 4 in. bottom plates. Studs laterally-braced by wood structural panel sheathing (Item 5).

2. Gypsum Board\* - Any Classified 5/8 in. thick, 4 ft wide, applied vertically and nailed to studs and bearing plates 7 in. OC with 6d cement-coated nails, 1-7/8 in.

3. Joints and Nailheads - (Not Shown) - Wallboard joints covered with tape and joint compound. Nail heads covered with joint compound.

Batts and Blankets\* - Mineral fiber or glass fiber insulation, 3-1/2 in. thick, pressure fit to fill wall cavities between studs and plates.

5. Wood Structural Panel Sheathing - Min 7/16 in. thick, 4 ft wide wood structural panels, min grade "C-D" or "Sheathing".

6. Exterior Facings - Installed in accordance with the manufacturer's installation instructions. One of the following exterior facings is to be applied over the

heathing:

. Vinyl Siding - Molded Plastic\*

B. Particle Board Siding

Wood Structural Panel or Lap Siding


Cementitious Stucco
 Brick Veneer

F. Exterior Insulation and Finish System (EIFS)G. Siding - Aluminum or steel siding

. Fiber-Cement Siding

Bearing the UL Classification Mark

#### DESIGN NO. U337

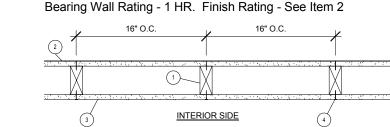

1. Wood Studs - Nom 2 by 4 in. spaced 16 in. OC, effectively cross braced at mid-height and fire stopped at top and bottom.

2. Gypsum Board\*-5/8in. thick, 4 ft wide, applied vertically. Wallboard attached to studs and bearing plates with 1-3/4in. long gavl nails wit 0.128 in diam. shank nail 7/16 in. diam head, spaced 8 in. on center.

G-P GYPSUM CORP, SUB OF GEORGIA-PACIFIC CORP - Type DGG (finish rating 20 min), Type DAP, DD, DS.

3. Gypsum Board\*-5/8in. thick, 4 ft wide, applied vertically. Wallboard attached to studs and bearing plates with 1-3/4in. long galv. nails with 0.128 in.

shank and 7/16in. diam head, spaces 8 in. on center.

AMERICAN GYPSUM GO - Type AGX-7 (finish rating 20 min).
BEIJING NEW BUILDING MATERIALS CO LTD - Type DBX-1 (finish rating 24 min).-Type CG3-3 (finish rating 20 min), Type CG5-5 (finish rating 20 min), Type CG6-6

(finish rating 20 min), Type CG9-9 (finish rating 20 min), Type CGTC-C (finish rating 20 min)
BPB AMERICA INC - Type EGRG (finish rating 23 min).

G-P GYPSUM CORP, ŚUB OF GEORGIA-PACIFIC CORP - Type 5,9,C, Type DGG (finish rating 20 min), Type GPFS2 (finish rating 24 min), Type GPFS6 (finish rating 20 min), Type DS, Type DAP, Type DD (finish rating 20 min), DA.

LAFARGE NORTH AMERICA INC - Type LGFC2 (finish rating 24 min), Type LGFC2A, Type LGFC3 (finish rating 20min), Type LGFC6 (finish rating 20 min), Type LGFC-C

(finish rating 20 min), Type LGFC6A (finish rating 34 min), Type LGFC-C/A


PABCO GYPSUM, DIV OF PACIFIC COAST BUILDING PRODUCTS - Type PG-9 SIAM GYPSUM INDUSTRY (SARABURI) CO LTD - Type EX-1 (finish rating 26 min).

4. Joints and Nailheads - Exposed or covered with paper tape and joint compound. For tapered, rounded-edge wallboards, joints with paper tape and joint compound.

\*Bearing the UL Classification Mark

#### DESIGN NO. U311

#### Bearing Wall Rating--1HR. Finish Rating -- 23 Min.

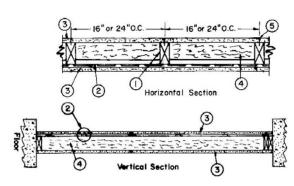

Wood Studs -- Nom 2 by 4 in., spaced 16 or 24. OC. Effectively cross braced.

Resilient Channel -- 25 MSG galv steel. Resilient channels spaced vertically 24 in. OC, flange portion screw attached to

one side of studs with 1-1/4 in. long diamond shaped point, double lead Phillips head steel screws.

2A. Steel Framing Members (Optional, Not Shown)\* -- As an alternate to Item 2, furring channels and resilient sound isolation clip as described below:

a. Furring Channels -- Formed of No. 25 MSG galv steel. 2-3/8 in. wide by 7/8 in. deep, spaced 24 in. OC perpendicular to studs. Channels secured to studs as described in Item b. Ends of adjoining channels are overlapped 6 in. and tied together with double strand of No. 18 SWG galv steel wire near each end of overlap. As an alternate, ends of adjoining channels may be overlapped 6

in. and secured together with two self-tapping #6 framing screws, min. 7/16 in. long at the midpoint of the overlap, with one screw on each flange of the channel.

b. **Steel Framing Members\*** -- Resilient sound isolation clip used to attach furring channels (Item a) to study (Item 1). Clips spaced 48 in OC and secured to study with No. 8 x 2.1/2 in coarse drawall screw through the center growmet. Furring channels

b. Steel Framing Members\* -- Resilient sound isolation clip used to attach furring channels (Item a) to studs (Item 1). Clips spaced 48 in. OC. and secured to studs with No. 8 x 2-1/2 in. coarse drywall screw through the center grommet. Furring channels are friction fitted into clips.

PAC INTERNATIONAL INC --Type RSIC-1.

3. **Gypsum Board\*** -- 5/8 in. thick, 4 ft wide. Screw attached one side to furring channels with 1 in. long, self-drilling, self-tapping steel screws spaced 12 in. OC, vertical joints located midway between studs and back blocked with furring channels, attached with 1 in. long, self-drilling, self-tapping screws, spaced 12 in. OC, along each edge. Wallboard attached other side to studs with 1-1/4 in. long diamond shaped point, double lead Phillips head steel screws spaced 12 in. OC, vertical joints located over studs. **AMERICAN GYPSUM CO** --Types AG-C, AGX-C. **BPB AMERICA INC** --Type FRPC, ProRoc Type C. **BPB CANADA INC** -- ProRoc Type C. **CANADIAN GYPSUM COMPANY** --Types C, IP-X2, IPC-AR. **G-P GYPSUM CORP, SUB OF GEORGIA-PACIFIC CORP** -- Type 5. **LAFARGE NORTH AMERICA INC** --Types LGFC-C, LGFC

C/A. **NATIONAL GYPSUM CO** --Types FSK-C, FSW-C, FSW-G. **PABCO GYPSUM, DIV OF PACIFIC COAST BUILDING** 

PRODUCTS INC --Type C or PG-C. STANDARD GYPSUM L L C --Type SG-C. TEMPLE-INLAND FOREST PRODUCTS CORP --Type TG-C. UNITED STATES GYPSUM CO --Types C, IP-X2, IPC-AR. USG MEXICO S ADE C V --Types C, IP-X2, IPC-AR.

4. Batts and Blankets\* -- 3 in. thick mineral wool batts, placed to fill interior of wall, attached to the 4-in. face of the studs with

4. Batts and Blankets\* -- 3 in. thick mineral wool batts, placed to fill interior of wall, attached to the 4-in. face of the studs with staples placed 24 in. OC.

ROCK WOOL MANUFACTURING CO --Delta Board. JOHNS MANVILLE INTERNATIONAL INC ROXUL INC THERMAFIBER L L C

4A. Glass Fiber Insulation -- (As an alternate to Item 4) -- 3 in. thick glass fiber batts bearing the UL Classification Marking as to Surface Burning and/or Fire Resistance, placed to fill the interior of the wall, attached to the 4 in. face of the studs with staples placed 24 in. OC. See Batts and Blankets (BKNV or BZJZ) Categories for names of Classi}fied companies.

4B. Fiber, Sprayed\* -- As an alternate to Batts and Blankets (Item 4) -- Spray applied cellulose insulation material. The fiber is applied with water to completely fill the enclosed cavity in accordance with the application instructions supplied with the product. Nominal dry density of 3.0 lb/ft3.

U S GREENFIBER L L C -- Cocoon stabilized cellulose insulation.


5. Joints and Screw heads -- Wallboard joints covered with paper tape and joint


5. **Joints and Screw heads --** Wallboard joints covered with paper tape and joint compound. Screw heads covered with joint compound. As an alternate, nom 3/32 in. thick gypsum veneer plaster may be applied to the entire surface of Classified veneer baseboard. Joints reinforced.

\*Bearing the UL Classification Mark

## DESIGN NO. P522

Unrestrained Assembly Rating - 1 Hour Finish Rating - 25 Min (See Items 3 or 3A)

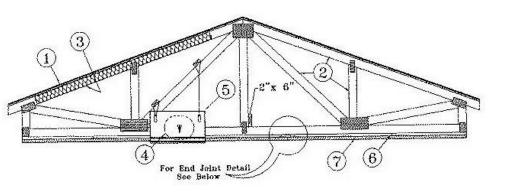

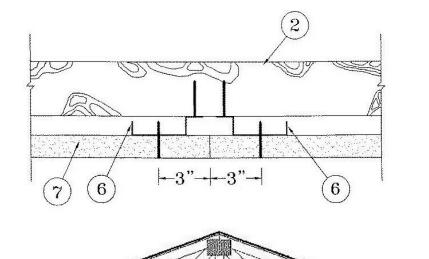

Alternate Insulation Placement

Roofing System\* -- Any UL Class A, B or C Roofing System (TGFU) or Prepared Roof Covering (TFWZ) acceptable for use over nom 15/32 in. thick wood structural panels, min. grade "C-D" or "Sheathing". Nom 15/32 in. thick wood structural panels secured to trusses with No. 6d ringed shank nails spaced 12 in. OC along each truss. Staples having equal or greater withdrawal and lateral resistance strength may be substituted for the 6d nails. Construction adhesive may be used with either the nails or staples.

Trusses -- Pitched or parallel chord wood trusses, spaced a max of 24 in. OC, fabricated from nom 2 by 4 lumber, with lumber oriented vertically or horizontally. Truss members secured

together with 0.040 in. thick galv steel plates. Plates have 5/16 in. long teeth projecting perpendicular to the plane of the plate. The teeth are in pairs facing each other (made by the same punch), forming a split tooth type plate. Each tooth has a chisel point on its outside edge. These points are diagonally opposite each other for each pair. The top half of each tooth has a twist for stiffness. The pairs are repeated on approximately 7/8 in. centers with four rows of teeth per inch of plate width. Where the truss intersects with the interior face of the exterior walls, the min truss depth shall be 5-1/4 in. with a min roof slope of 3/12 and a min. area in the plane of the truss of 21 sq/ft. Where the truss intersects with the interior face of the exterior walls, the min truss depth may be reduced to 3 in. if the batts and blankets (Item 3) are used as shown in the above illustration (Alternate Insulation Placement) and are firmly packed against the intersection of the bottom chords and the plywood sheathing.

3. **Batts and Blankets\* --** (Optional) -- Glass fiber insulation, secured to the wood structural panels with staples spaced 12 in. OC or to the trusses with 0.090 in. diam galv steel wires spaced 12 in. OC. Any glass fiber insulation bearing the UL Classification Marking as to Surface Burning Characteristics and/or Fire Resistance, having a min density of 0.5 pcf. As an option, the insulation may be fitted in the concealed space, draped over the resilient channel/gypsum wallboard ceiling membrane when resilient channels and gypsum wallboard attachment is modified as specified in Items 6 and 7. The finished rating has only been determined when the insulation is secured to the decking.

3A. **Loose Fill Material\*** -- As an alternate to Item 3 -- Any thickness of loose fill material bearing the UL Classification Marking for Surface Burning Characteristics, having a min density of 0.5 pcf, fitted in the concealed space, draped over the resilient channel/gypsum wallboard ceiling membrane when resilient channels and gypsum wallboard attachment is modified as specified in Items 6 and 7. The finished rating when loose fill material is used has not been determined.

Air Duct\* -- Any UL Class 0 or Class 1 flexible air duct installed in accordance with the instructions provided by the damper manufacturer.
 Ceiling Damper\* -- Max nom area, 324 sq in. Max square size, 18 in. by 18 in. rectangular sizes not to exceed 324 sq in. with a max width of 18 in. Max damper height is 14 in. Installed in accordance with manufacturers installation instructions provided with the damper. Max damper openings not to exceed 162 sq in. per 100 sq ft of ceiling area.

C&S AIR PRODUCTS --Model RD-521 POTTORFF --Model CFD-521
5A. Alternate Ceiling Damper\* -- Max nom area, 196 sq in. Max square size, 14 in. by 14 in. Rectangular sizes not to exceed 196 sq in. with a max width of 24 in. Max overall damper height is 7 in. Installed in accordance with the manufacturers installation instructions provided with the damper. Max damper openings not to exceed 196 sq in. per 100 sq ft of ceiling area.

C&S AIR PRODUCTS --Model RD-521-BT POTTORFF --Model CFD-521-BT.

6. Furring Channels -- Resilient channels, nom. 1/2 in. deep by 2-3/8 in. wide at the base and 1-3/8 in. wide at the face, formed from 0.020 in. thick galv steel. Installed perpendicular to the trusses (Item 2), spaced a max of 16 in. OC when no insulation (Item 3 or 3A) is fitted in the concealed spaced, or a max of 12 in. OC when insulation (Item 3 or 3A) is fitted in the concealed space, draped over the resilient channel/gypsum wallboard ceiling membrane. Two courses of resilient channel positioned 6 in. OC at wallboard butt-joints (3 in. from each end of wallboard). Channels oriented opposite at wallboard butt-joints. Channel splices overlapped 4 in. beneath wood trusses. Channels secured to each truss with 1-1/4 in. long Type S screws.

6A. Steel Framing Members -- (Not Shown)\* -- As an alternate to Item 6, furring channels and Steel Framing Members as described below:

a. Furring Channels -- Formed of No. 25 MSG galv steel. 2-3/8 in. wide by 7/8 in. deep, spaced 24 in. OC perpendicular to trusses when no insulation (Items 3 or 3A) is fitted in the concealed space or 12 in. OC when insulation (Items 3 or 3A) is fitted in the concealed space, draped over the furring channel/gypsum wallboard ceiling membrane or 24 in. OC when insulation (Items 3 or 3A) is fitted in the concealed space, draped over the furring channel/gypsum wallboard ceiling membrane and a second layer of gypsum board is attached as described in Item 7 for steel framing

members. Channels secured to joists as described in Item
b. Ends of adjoining channels overlapped 6 in. and tied together with double strand of No. 18 SWG galv steel wire near each end of overlap.

b. **Steel Framing Members** -- Used to attach furring channels (Item a) to trusses (Item 2). Clips spaced 48 in. OC and secured to alternating trusses with No. 8 x 2-1/2 in. coarse drywall screw through the center grommet. Furring channels are friction fitted into clips. Adjoining channels are overlapped as described in Item a. As an alternate, ends of adjoining channels may be overlapped 6 in. and secured together with two self-tapping #6 framing screws, min. 7/16 in. long at the midpoint of the overlap, with one screw on each flange of the channel. Additional clips required to hold furring channel that supports the wallboard butt joints, as described in Item 7. **PAC INTERNATIONAL INC** --Type RSIC-1.

7. **Gypsum Board\*** -- One layer of nom 5/8 in. thick by 48 in. wide boards, installed with long dimension parallel to trusses. Attached to the resilient channels using 1 in. long Type S bugle-head screws. Screws spaced a max of 12 in. OC along butted end-joints and in the field when no insulation (Item 3 or 3A) is fitted in the concealed spaced, or a max of 8 in. OC along butted end-joints and in the field when insulation (Item 3 or 3A) is fitted in the concealed space, draped over the resilient channel/gypsum wallboard ceiling membrane.

When **Steel Framing Members\*** (Item 6A) are used, sheets installed with long dimension perpendicular to furring channels and side joints of sheet located beneath trusses. Wallboard screws are driven through channel spaced 12 in. OC in the field when no insulation (Item 3 or 3A) is fitted in the concealed space, or 8 in. OC in the field when insulation (Item 3 or 3A) is fitted in the concealed space, or 8 in. OC in the field when insulation (Item 3 or 3A) is fitted in the concealed space, or 8 in. OC in the field when insulation (Item 3 or 3A) is fitted in the concealed space, or 8 in. OC in the field when insulation (Item 3 or 3A) is fitted in the concealed space, or 8 in. OC in the field when insulation (Item 3 or 3A) is fitted in the concealed space, or 8 in. OC in the field when insulation (Item 3 or 3A) is fitted in the concealed space, or 8 in. OC in the field when insulation (Item 3 or 3A) is fitted in the concealed space, or 8 in. OC in the field when insulation (Item 3 or 3A) is fitted in the concealed space, or 8 in. OC in the field when insulation (Item 3 or 3A) is fitted in the concealed space, or 8 in. OC in the field when insulation (Item 3 or 3A) is fitted in the concealed space, or 8 in. OC in the field when insulation (Item 3 or 3A) is fitted in the concealed space, or 8 in. OC in the field when insulation (Item 3 or 3A) is fitted in the concealed space, or 8 in. OC in the field when insulation (Item 3 or 3A) is fitted in the concealed space, or 8 in. OC in the field when insulation (Item 3 or 3A) is fitted in the concealed space, or 8 in. OC in the field when insulation (Item 3 or 3A) is fitted in the concealed space, or 8 in. OC in the field when insulation (Item 3 or 3A) is fitted in the concealed space, or 8 in. OC in the field when insulation (Item 3 or 3A) is fitted in the concealed space, or 8 in. OC in the field when insulation (Item 3 or 3A) is fitted in the concealed space, or 8 in. OC in the field when insulation (Item 3 or 3A) is fitted in the concealed space, or 8 in. OC in the fiel

CANADIAN GYPSUM COMPANY --Types C, IP-X2, IPC-AR. UNITED STATES GYPSUM CO --Types C, IP-X2, IPC-AR. USG MEXICO S ADE C V --Types C, IP-X2, IPC-AR.

8. Finishing System -- (Not Shown) -- Vinyl, dry or premixed joint compound, applied in two coats to joints and screw-heads; paper tape, 2 in. wide, embedded in first layer of compound over all joints.

As an alternate, nom 3/32 in. thick veneer plaster may be applied to the entire surface of gypsum wallboard. Alternate Ceiling Membrane -- Not Shown.

a. **Main runners** -- Installed perpendicular to Structural Steel Members -- Nom 10 or 12 ft long, 15/16 in. or 1-1/2 in. wide face, spaced 4 ft OC. Main runners hung a min of 2 in. from bottom chord of Structural Steel Members with 12 SWG galv steel wire. Wires located a max of 48 in. OC.
b. **Cross tees or channels** -- Nom 4 ft long, 15/16 in. or 1-1/2 in. wide face or cross channels, nom 4 ft long, 1-1/2 wide face, installed perpendicular to the main runners, spaced 16 in. OC. Additional cross tees or channels used at 8 in. from each side of butted wallboard end joints. The cross tees or channels may be riveted or screw-attached to the wall angle or channel to facilitate the ceiling

installation.

c. **Wall angles or channels --** Used to support steel framing member ends and for screw-attachment of the gypsum wallboard -- Min 0.016 in. thick painted or galvanized steel angle with 1 in. legs or min. 0.016 in. thick painted or galvanized steel channel witha1by 1-1/2 by 1 in. profile, attached to walls at perimeter of ceiling with fasteners 16 in. OC.

CCC INTERIORS DIV OF CCC INC. Type DGL or RY LISC INTERIORS INC. Type DGL or RY.

CGC INTERIORS, DIV OF CGC INC -- Type DGL or RX. USG INTERIORS INC -- Type DGL or RX.

10. Gypsum Board\* -- For use with Steel Framing Members (Item 9) when Batts and Blankets\* (Item 6) are not used -One layer of nom 5/8 in. thick by 48 in. wide boards, installed with long dimension parallel to the main runners. Wallboard fastened to each cross tee or channel with five wallboard screws, with one screw located at the midspan of the cross tee or channel, one screw located 12 in. from and on each side of the cross tee or channel mid span and one screw located 1-1/2 in. from each wallboard side joint. Except at wallboard end joints, wallboard screws shall be located on alternating sides of cross tee flange. At wallboard end joints, wallboard screws shall be located 1/2 in. from the joint. Wallboard fastened to main runners with wallboard screws 1/2 in. from side joints, midway between intersections with cross tees or channels (16 in. OC). End joints of adjacent wallboard sheets shall be staggered not less than 32 in. Wallboard sheets screw attached to leg of wall angle with wallboard screws spaced 12 in. OC. Joints treated as described in Item 7. For use with Steel Framing Members\* (Item 9) when Batts and Blankets\* (Item 6) are used -Ratings limited to 1 Hour -5/8 in. thick, 4 ft wide; installed with long dimension perpendicular to cross tees with side joints. Fastened to cross tees with 1 in. long wallboard screws spaced 8 in. OC in the field and 8 in. OC along end joints. Fastened to main runners with 1 in. long wallboard screws spaced 8 in. OC in the field and 8 in. OC along end joints. Fastened to main runners with 1 in. long wallboard screws spaced 8 in. OC in the field and 8 in. OC along end joints. Fastened to main runners with 1 in. long wallboard screws spaced 8 in. OC in the field and 8 in. OC along end joints. Fastened to main runners with 1 in. long wallboard screws spaced 8 in. OC in the field and 8 in. OC along end joints. Fastened to main runners with 1 in. long wallboard screws

spaced midway between cross tees. Screws along sides and ends of boards spaced 3/8 to 1/2 in. from board edge. End joints of the sheets shall be staggered with spacing between joints on adjacent boards not less than 4 ft OC. **CANADIAN GYPSUM COMPANY** -- Type C or IP-X2. **UNITED STATES GYPSUM CO** -- Type C or IP-X2. **USG MEXICO S A DE C V** -- Type C or IP-X2.

\*Bearing the UL Classification Mark

M I S H R A

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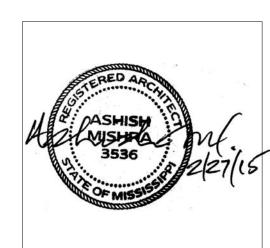
STRUCTURAL:
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Charlotte, NC 28208
Phone: (704) 399-3943
Email: asoler@allied-engineers.com

No. Date Description

D"

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KEY PLAN

Shiva Southaven

Holiday Inn Express & Suites

Lot 16 (Rev Lot 3) Southcrest Pkwy. Southcrest Subdivision Southaven, MS 38671

Drawing Title
UL Details


Construction Documents

 Project No.
 14-081
 Sheet No.

 Prepared by
 Author

 Checked by
 Checker

 Date
 Feb. 27, 2015

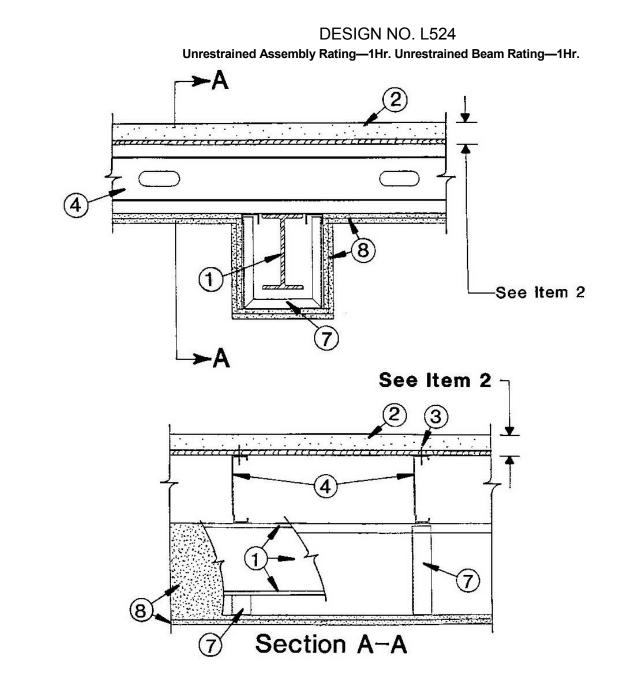

Steel Beam — W8x15, min size.

Flooring Systems — The finish flooring, vapor barrier and subflooring may consist of any of the following systems.

System No. 1 Finish Flooring — Min. nom 19/32 in. thick wood structural panels, min grade "Underlayment" or "Single Floor". Face grain of plywood or strength axis of panels to be perpendicular to joists with joints staggered. Long edges to be T&G. System No. 2 Finish Flooring — Min. nom 19/32 in. thick wood structural panels, min grade "C-D" or "Sheathing". Face grain of plywood or strength axis of panels to be perpendicular to joists with joints staggered. Long edges to be T&G. Vapor Barrier — Commercial rosin-sized building paper, 0.010 in. thick oriented strand board (OSB) wood structural panels, min grade "C-D" or "Sheathing". Face grain of plywood or strength axis of panels to be perpendicular to joists with joints staggered. Long edges to be T&G. Vapor Barrier — Commercial rosin-sized building paper, 0.010 in. thick oriented strand board (OSB) wood structural panels, min grade "C-D" or "Sheathing". Face grain of plywood or strength axis of panels to be perpendicular to joists with joints staggered. Long edges to be T&G. Vapor Barrier — Commercial rosin-sized building paper, 0.010 in. thick oriented strand board (OSB) wood structural panels, min grade "C-D" or "Sheathing". Face grain of plywood or strength axis of panels to be perpendicular to joists with joints staggered. Long edges to be T&G. Vapor Barrier — Commercial rosin-sized building paper, 0.010 in. thick oriented strand board (OSB) wood structural panels, min grade "C-D" or "Sheathing". Face grain of plywood or strength axis of panels to be perpendicular to joists with joints staggered. Long edges to be T&G. Vapor Barrier — Commercial rosin-sized building paper, 0.010 in. thick oriented strand board (OSB) wood structural panels, min grade "C-D" or "Sheathing". Face grain of plywood or strength axis of panels to be perpendicular to joint strange and the parel strange axis of panels axis of panels to be perpendicular to joint strange axis of panels to be perpendicular to joint strange axis of panels to be perpendicular to joint strange axis of panels to be perpendicular to joint strange axis of panels to be perpendicular to joint strange axis of panels to be perpendicular to joint strange axis of panels to be perpendicular to joint strange axis of panels to be perpendicular to joint strange strength axis of panels to be perpendicular to joists with joints staggered.

System No. 3 Finish Flooring — Floor Topping Mixture\* — Compressive strength 1500 psi min, thickness to be 1 in. min. Refer to manufacturer's instructions accompanying the material for specific mix design.

**UNITED STATES GYPSUM CO**—Levelrock 2500, Levelrock RH **Vapor Barrier**—(Optional)—Commercial asphalt saturated felt, 0.030 in. thick. Subflooring — Min nom 15/32 in. thick wood structural panels, min grade "C-D" or "Sheathing". Face grain of plywood or strength axis of panels to be perpendicular to joists with joints staggered

Floor Mat Materials\* — (Optional) — Floor mat material nom 0.4 in. thick loose laid over the subfloor. Floor topping thickness a min 1 in. over the floor mat.

**UNITED STATES GYPSUM CO** — Type USG Sound Mat **Alternate Floor Mat Materials\*** — (Optional) -Floor mat material ranging from 3/8 in. to 3/4 in. thick loose laid over the subfloor. Floor topping thickness a min 1 in. over the floor mat.

**UNITED STATES GYPSUM CO** — Levelrock Brand Sound Reduction Board System No. 4 Finish Flooring — Floor Topping Mixture\* — 10-13 gal. of water to 170 lbs. of floor topping mixture to 595 lbs. of sand. Compressive strength 900 psi min. Thickness to be 3/4 in. min when used with 19/32 in. thick subflooring and 1 in. min when used with 15/32 in. thick subflooring.

ORTECRETE CORP —Type II. Subflooring — Min nom 15/32 in. thick wood structural panels, min grade "C-D" or "Sheathing". Face grain of plywood or strength axis of panels to be perpendicular to joists with joints staggered. System No. 5 Finish Flooring — Floor Topping Mixture\* — Foam concentrate mixed 40:1 by volume with water and expanded at 100 psi through nozzle. Mix at rate of 1.4 cu ft of preformed foam to 94 lbs Type I Port-land cement and 300 lbs of sand with 5-1/2 gal of water. Cast density of floor topping mixture 100 plus or minus 5 pcf. Min compressive strength 1000 psi. Thickness 1-1/2 in.

**ELASTIZELL CORP OF AMERICA** —Type FF. Vapor Barrier — (Optional)— Commercial asphalt saturated felt, 0.030 in thick. Subflooring — Min nom 19/32 in. thick wood structural panels min grade "C-D" or "Sheathing". Face grain of plywood or strength axis of panels to be perpendicular to joists with joints staggered.

System No. 6 Finish Flooring — Floor Topping Mixture\* — 6.8 gal of water to 80 lbs bag of floor topping mixture to 1.9 cu ft of sand. Compressive strength to be 1100 psi min. Thickness to be 3/4 in. min. HACKER INDUSTRIES INC — Firm-Fill Gypsum Concrete, Firm-Fill 4010, Firm-Fill High Strength, Gyp-Span Radiant.

Floor Mat Materials\* — (Optional)— Floor mat material nom 1/4 in. thick adhered to subfloor with Hacker Floor Primer. Primer to be applied to the surface of the mat prior to the placement of a min 1-1/2 in. of floor-topping mixture.

HACKER INDUSTRIES INC —Type Sound-Mat. Vapor Barrier — (Optional) Commercial asphalt saturated felt 0.030 in. thick wood structural panels, min grade "C-D" or "Sheathing". Face grain of plywood or strength axis of panels to be perpendicular to joists with joints staggered

System No. 7 Floor Topping Mixture\* — Foam concentrate mixed 40:1 by volume with water and expanded at 100 psi through a foam nozzle. Mix at rate of 1.4 cu ft of preformed foam to 94 lbs Type I Portland Cement, 62.5 lb of Pea Gravel and 312.5 lbs of sand, with approximately 5.5 gal of water. Cast density of Floor Topping Mixture 100 (+ or -) 5 pcf. Min compressive strength 1000 psi. Thickness 1 in.

LITE-CRETE INC —Type I. Vapor Barrier — (Optional) — Commercial asphalt saturated felt,

0.030 in. thick. Subflooring — Min nom 15/32 in. thick wood structural panels, min grade "C-D" or "Sheathing". Face grain of plywood or strength axis of panels to be perpendicular to joists with joints staggered. System No. 8 Finish Flooring — Floor Topping Mixture\* — Foam concentrate mixed 40:1 by volume with water and expanded at 100 psi through a nozzle. Mix 94 lbs cement, 300 lbs sand, approximately 5.4 gal water,

1.2 cu ft preformed foam, 5 oz Type N fiber and 4 oz Component Z. Cast density of floor topping mixture shall be 105 (+ or -) 5 pcf with a min compressive strength of 1200 psi. Min thickness shall be 3/4 in.

ELASTIZELL CORP OF AMERICA —Type ZC. Subflooring — Min nom 19/32 in. thick wood structural panels, min grade "C-D" or "Sheathing". Face grain of plywood or strength axis of panels to be perpendicular to joists with joints staggered.

System No. 9 Finish Flooring — Floor Topping Mixture\* — 5 to 8 gal of water to 80 lbs of floor topping mixture to 2.1 cu ft of sand. Min compressive strength 1000 psi. Min thickness of 3/4 in. **ULTRA QUIET FLOORS** — Types UQF-A, UQF-Super Blend, UQF-Plus 2000. **Vapor Barrier** — **(Optional)** — Commercial asphalt saturated felt,

oring — Min nom 19/32 in. thick wood structural panels, min grade "C-D" or "Sheathing". Face grain of plywood or strength axis of panels to be perpendicular to joists with joints staggered.

System No. 10 Finish Flooring — Floor Topping Mixture\* — 3 to 7 gal of water mixed with 80 lbs of floor topping mixture and 1.0 to 2.1 cu ft of sand. Compressive strength to be 1000 psi min. Thickness to be 3/4 in. min when used with 19/32 in. thick sub-flooring or 1 in. min when used with 15/32 in. thick sub-flooring.

MAXXON CORP —Type D-C, GC, GC2000, L-R or T-F. Floor Mat Material\* — (Optional)—Floor mat material nom 1/4 in. thick adhered to sub-floor with Maxxon Floor Primer. Primer to be applied to the surface of the mat prior to lath placement.

MAXXON CORP —Type Acousti-Mat. Metal lath — For use with floor mat material, 3/8 in. expanded galva-nized steel diamond mesh, 3.4 lbs/sq yd placed over the floor mat material nom 1/4 in. thick loose laid over the floor mat material. Floor topping thickness a min 1 in. over the floor mat. MAXXON CORP — Type Acousti-Mat II. Vapor Barrier — (Optional) — Commercial asphalt saturated felt 0.030 in. thick wood structural panels, min grade "C-D" or "Sheathing". Face grain of plywood or strength axis of panels to be perpendicular to joists with joints staggered.

System No. 11 Finish Flooring — Floor Topping Mixture\* — 4 to 7 gal of water mixed with 80 lbs of floor topping mixture and 1.4 to 1.9 cu ft of sand. Compressive strength to be 1200 psi min. Thickness to be 3/4 in. min when used with 19/32 in. thick sub-flooring or 1 in. min when used with 15/32 in. thick sub-flooring. **RAPID FLOOR SYSTEMS**—Type RF, RFP or RFU. Floor Mat Material\* — (Optional)— Floor mat material nom 1/4 in. thick adhered to sub-floor with Maxxon Floor Primer. Primer to be applied to the surface of the mat prior to lath placement.

MAXXON CORP —Type Acousti-Mat. Metal lath — For use with floor mat material, 3/8 in. expanded galva-nized steel diamond mesh, 3.4 lbs/sq yd placed over the floor mat material nom 1/4 in. thick loose laid over the floor mat material, and 1 in. over the floor mat material nom 1/4 in. thick loose laid over the floor mat material, and 1 in. over the floor mat material nom 1/4 in. thick loose laid over the floor mat material, and 1 in. over the floor mat material nom 1/4 in. thick loose laid over the floor mat material, and 1 in. over the floor mat material nom 1/4 in. thick loose laid over the floor mat material nom 1/4 in. thick loose laid over the floor mat material nom 1/4 in. thick loose laid over the floor mat material nom 1/4 in. thick loose laid over the floor mat material nom 1/4 in. thick loose laid over the floor mat material nom 1/4 in. thick loose laid over the floor mat material nom 1/4 in. thick loose laid over the floor mat material nom 1/4 in. thick loose laid over the floor mat material nom 1/4 in. thick loose laid over the floor mat material nom 1/4 in. thick loose laid over the floor mat material nom 1/4 in. thick loose laid over the floor mat material nom 1/4 in. thick loose laid over the floor mat material nom 1/4 in. thick loose laid over the floor mat material nom 1/4 in. thick loose laid over the floor material nom 1/4 in. thick loose laid over the floor material nom 1/4 in. thick loose laid over the floor material nom 1/4 in. thick loose laid over the floor material nom 1/4 in. thick loose laid over the floor material nom 1/4 in. thick loose laid over the floor material nom 1/4 in. thick loose laid over the floor material nom 1/4 in. thick loose laid over the floor material nom 1/4 in. thick loose laid over the floor material nom 1/4 in. thick loose laid over the floor material nom 1/4 in. thick loose laid over the floor material nom 1/4 in. thick loose laid over the floor material nom 1/4 in. thick loose laid over the floor material nom 1/4 in. thick loose laid over the floor material nom MAXXON CORP — Type Acousti-Mat II. Vapor Barrier — (Optional) — Commercial asphalt saturated felt 0.030 in. thick wood structural panels, min grade "C-D" or "Sheathing". Face grain of plywood or strength axis of panels to be perpendicular to joists with joints staggered.

System No. 12 Finish Floor — Mineral and Fiber board\*, sizes ranging from 3 ft by 4 ft to 8 ft by 12 ft, by min 1/2 in, thick, All joints to be staggered a min of 12 in, OC with adjacent sub-floor joints. HOMASOTE CO —Type 440-32 Mineral and Fiber Board Sub-flooring —1in. by6in.T&G fastened diagonally to joists; or min nom 15/32 in. thick plywood or strength axis of panels to be perpendicular to joists with joints staggered.

System No. 13 Finish Flooring — Floor Topping Mixture\* — Compressive strength to be 2100 psi minimum. Thick wood structural panels. Refer to manufacturer's instructions accompanying the material for specific mix design. UNITED STATES GYPSUM CO —Levelrock 3500. Levelrock

Commercial RH Vapor Barrier — (Optional) — Commercial asphalt saturated felt 0.030 in. thick. Sub-flooring — 15/32 or 19/32 in. thick wood structural panels min grade "C-D" or "Sheathing". Face grain of plywood to be perpendicular to joists with joints staggered.

Floor Mat Materials\* — (Optional) — Floor mat material nom 0.4 in. thick loose laid over the subfloor. Floor topping thickness a min 1 in. over the floor mat. UNITED STATES GYPSUM CO —Type USG Sound Mat Alternate Floor Mat Materials\* — (Optional) -Floor mat material ranging from 3/8 in. to 3/4 in. thick loose laid over the subfloor. Floor topping thickness a min 1 in. over the floor mat.

UNITED STATES GYPSUM CO — Levelrock Brand Sound Reduction Board

System No. 14 Finish Flooring — Floor Topping Mixture\* — Compressive strength to be 3000 psi minimum. Thickness to be 1/2 in. thick wood structural panels. Refer to manufacturer's instruc-tions accompanying the material for specific mix design. UNITED STATES GYPSUM CO —Levelrock 4500

Vapor Barrier — (Optional) — Commercial asphalt saturated felt 0.030 in. thick. Sub-flooring — 15/32 or 19/32 in. thick wood structural panels min grade "C-D" or "Sheathing". Face grain of plywood to be perpendicu-lar to joists with joints staggered.

Floor Mat Materials\* — (Optional) — Floor mat material nom 0.4 in. thick loose laid over the subfloor. Floor topping thickness a min 1 in. over the floor mat.

UNITED STATES GYPSUM CO — Type USG Sound Mat Alternate Floor Mat Materials\* — (Optional) -Floor mat material ranging from 3/8 in. to 3/4 in. thick loose laid over the subfloor. Floor topping thickness a min 1 in. over the floor mat. UNITED STATES GYPSUM CO — Levelrock Brand Sound Reduction Board

System No. 15 Finish Flooring — Floor Topping Mixture\* — Compressive strength to be 3000 psi minimum. Thick wood structural panels. Refer to manufacturer's instructions accompanying the material for specific mix design.

UNITED STATES GYPSUM CO —Levelrock SLC Vapor Barrier — (Optional) — Commercial asphalt saturated felt 0.030 in. thick wood structural panels min grade "C-D" or "Sheathing". Face grain of plywood to be perpendicu-lar to joists with joints staggered.

Floor Mat Materials\* — (Optional) — Floor mat material nom 0.4 in. thick loose laid over the subfloor. Floor topping thickness a min 1 in. over the floor mat. UNITED STATES GYPSUM CO —Type USG Sound Mat Alternate Floor Mat Materials\* — (Optional) -Floor mat material ranging from 3/8 in. to 3/4 in. thick loose laid over the subfloor. Floor topping thickness a min 1 in. over the floor mat.

**UNITED STATES GYPSUM CO** — Levelrock Brand Sound Reduction Board System No. 16 Finish Flooring—Floor Topping Mixture\* — Foam concentrate mixed

40:1 by volume with water and expanded at 100 psi through nozzle. Mix a rate of 1.2 cu ft of preformed foam to 94 lbs Type I Portland cement and 300 lbs of sand with 5-1/2 gal of water. Cast density of floor topping mixture 100 plus or minus 5 pcf. Min compressive strength of 1000 psi. Thickness 1-1/2 in. CELLULAR CONCRETE L L C Vapor barrier — (Optional) — Commercial asphalt saturated felt.

0.030 in. thick. **Subflooring** — 15/32 or 19/32 in. thick wood structural panels, min grade "C-D" or "Sheathing". Face grain of plywood to be perpendicu-lar to joists with joints staggered.

Flooring Fasteners — The subflooring (first layer) of each floor system or finish flooring system No. 1) is to be fastened to the subflooring is to be fastened to the subflooring with Type S12 by 1-15/16 in. long steel screws are to be spaced 6 in. OC around the perimeter of the floor and at all end (butt) joints of the subflooring with Type S12 by 1-15/16 in. long steel screws are to be spaced 6 in. OC around the perimeter of the floor and at all end (butt) joints of the finish flooring panels. Spacing in the field to be 10 in. OC with rows of screws spaced 16 in. OC. Steel Joists — The joists are channel-shaped, 7 in. min depth with 1-5/8 in. min width flanges and 1/2 in. long stiffening flanges. The joists are fabricated from min of No. 18 MSG, galv steel. Min yield strength of steel is either 33,000 or 40,000 psi with corresponding max working stress of 20,000 and 24,000 psi. Joists are channel-shaped, 7 in. min depth with 1-5/8 in. min width flanges and 1/2 in. long stiffening flanges. The joists are fabricated from min of No. 18 MSG, galv steel. Min yield strength of steel is either 33,000 or 40,000 psi with corresponding max working stress of 20,000 and 24,000 psi. Joists are fabricated from min of No. 18 MSG, galv steel.

Joist Stiffeners — (Not shown.) Min No. 18 MSG, galv steel. Stiffeners are channel-shaped, 6-13/16 in. long, 3-1/2 in. deep with 1-5/8 in. flanges and 1/2 in. stiffening flanges. The joists stiffeners are used at all bearing locations of the joists. Joist Bridging — (Not shown.) — Installed immediately after joists are erected and before construction loads are applied. The bridging consist-ing of cut to length joist section is placed between outer supports, adja-cent to openings and at mid span with 8 ft. O.C. max spacing. Bridging consist-ing of cut to length joist section is placed between outer supports, adja-cent to openings and at mid span with 8 ft. O.C. max spacing. Bridging consist-ing of cut to length joist section is placed between outer supports, adja-cent to openings and at mid span with 8 ft. O.C. max spacing. Bridging consist-ing of cut to length joist section is placed between outer supports, adja-cent to openings and at mid span with 8 ft. O.C. max spacing. Bridging consist-ing of cut to length joist section is placed between outer supports, adja-cent to openings and at mid span with 8 ft. O.C. max spacing. Beam Cage — The cage used to support the gypsum wallboard beam protection is fabricated from No. 24 MSG, electrogalvanized steel channel studs, 2-1/2 in. wide with 1 in. legs. Angles are fastened to the steel joists using 1/2 in. pan head steel sheet metal screws. 8. **Gypsum Board\*** — **For Ceiling** — Two layers of 1/2 in. thick sheets installed with long dimensions perpendicular to joists. Inner layer attached to assembly using 1-1/2 in. long, Type G bugle head steel screws at the butt joints, spaced 8 in. O.C. and located 3/4 in. from the edge, and in long, Type G bugle head steel screws at the butt joints, spaced 8 in. O.C. and located 3/4 in. from the edge, and in long, Type G bugle head steel screws at the butt joints, spaced 8 in. O.C. and located 3/4 in. from the edge, and in located 3/4 in. from the edge, and in long, Type G bugle head steel screws at the butt joints, spaced 8 in. O.C. and located 3/4 in. from the edge, and in long, Type G bugle head steel screws at the butt joints located 1/2 in. thick sheets installed with long dimensions perpendicular to joists.

the field with 1-5/8 in. long, Type S12 bugle head steel screws spaced 12 in. O.C. along the joists. Butt joints of outer layer to occur between joists. Edge joints to be staggered from inner layer fastened to cage using 1-5/8 in. long, Type S12 bugle head steel screws spaced 12 in. O.C. along the joists. Butt joints of outer layer fastened to cage using 1 in. long, Type S12 bugle head steel screws spaced 12 in. O.C. along the joists. Butt joints of outer layer fastened to cage using 1-5/8 in. long, Type S12 bugle head steel screws spaced 12 in. O.C. along the joists. Butt joints of outer layer fastened to cage using 1-5/8 in. long, Type S12 bugle head steel screws spaced 12 in. O.C. along the joists. Butt joints of outer layer fastened to cage using 1 in. long, Type S12 bugle head steel screws spaced 12 in. O.C. along the joists. Butt joints of outer layer fastened to cage using 1-5/8 in. long, Type S12 bugle head steel screws spaced 12 in. O.C. along the joists. Butt joints of outer layer fastened to cage using 1-5/8 in. long, Type S12 bugle head steel screws spaced 12 in. O.C. along the joists. Butt joints of outer layer fastened to cage using 1-5/8 in. long, Type S12 bugle head steel screws spaced 12 in. O.C. along the joists. Butt joints of outer layer fastened to cage using 1-5/8 in. long, Type S12 bugle head steel screws spaced 12 in. O.C. along the joints of outer layer fastened to cage using 1-5/8 in. long, Type S12 bugle head steel screws spaced 12 in. O.C. along the joints of outer layer fastened to cage using 1-5/8 in. long, Type S12 bugle head steel screws spaced 12 in. O.C. along the joints of outer layer fastened to cage using 1-5/8 in. long, Type S12 bugle head steel screws spaced 12 in. O.C. along the joints of outer layer fastened to cage using 1-5/8 in. long, Type S12 bugle head steel screws spaced 12 in. O.C. along the joints of outer layer fastened to cage using 1-5/8 in. long, Type S12 bugle head steel screws spaced 12 in. O.C. along the joints of outer layer fastened to cage using 1-5/8 i C/A. NATIONAL GYPSUM CO -Types FSK-C, FSW-C. PABCO GYPSUM, DIV OF PACIFIC COAST BUILDING PRODUCTS INC -Type SG-C. TEMPLE-INLAND FOREST PRODUCTS CORP -Type TG-C. UNITED STATES GYPSUM CO -Type C. USG MEXICO S A DE C V -Type C.

**ALTERNATE CEILING MEMBRANE** — Not Shown.

9. Hanger Wire — For use with Item 10 -No. 12 SWG galv steel wire secured to steel joists spaced a max 48 in. OC. 10. **Steel Framing Members** — To be installed below the bottom flange of the steel beam.

a. Main runners — Installed perpendicular to Structural Steel Members, -Nom 12 ft long, 15/16 in. or 1-1/2 in. wide face, spaced 4 ft OC. Main runners hung a min of 2 in. from bottom chord of Structural Steel Members with 12 SWG galv steel wire. Wires located a max of 48 in. OC.

b. Cross tees or channels — Nom 4 ft long, 15/16 in. or 1-1/2 in. wide face or cross channels may be riveted or screw-attached to the wall angle or channel to facilitate the ceiling installation. c. Wall angles or channels — Used to support steel framing member ends and for screw-attachment of the gypsum wallboard -Painted or galvanized steel angles with 1 in. legs and 1-9/16 in. deep, attached to walls at perimeter of ceiling with fasteners 16 in. OC.

CGC INTERIORS, DIV OF CGC INC — Type DGL or RX. USG INTERIORS INC — Type DGL or RX.

11. **Gypsum Board\*** — For use with Steel Framing Members (Item 10) -Two layers of nominal 1/2 in. thick by 48 in. oC along butted end joints and 12 in. OC in the field of the board. End joints of adjacent wallboard sheets shall be staggered not less than 4 ft OC. Outer layer attached to the cross tees through inner layer. Rows of screws on both sides of butted end joints of each layer shall be located 3/8 to 1/2 in. from end joints. Butted side joints of outer layer attached to the cross tees through inner layer using 1-7/8 in. long Type S bugle-head steel screws spaced 8 in. OC at butted end joints of outer layer to be offset a min of 18 in. from butted side joints of inner layer.

CANADIAN GYPSUM COMPANY — Type C. UNITED STATES GYPSUM CO — Type C. USG MEXICO S A DE C V — Type C. \*Bearing the UL Classification Mark

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Benchmark Engineering and Surveying 101 Highpointe Court, Suite B Brandon, MS 39042 Phone: (601) 591-1077 Fax: (601) 591-0177 Email:mikebes@bellsouth.net

STRUCTURAL: WGPM, Inc. 11220 Elm Lane, Suite 201 Charlotte, NC 28277 Phone: (704) 542-7199 Fax: (704) 542-7195 Email: lwright@wgpminc.com

Allied Consulting Engineers 2905-D Queen City Drive Charlotte, NC 28208 Phone: (704) 399-3943 Email: asoler@allied-engineers.com

REVISIONS		
No.	Date	Description

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**KEY PLAN** 

Shiva Southaven

Lot 16 (Rev Lot 3) Southcrest Southcrest Subdivision Southaven, MS 38671

Drawing Title **UL** Details


Construction Documents


Date Feb. 27, 2015

14-081 Author Checker


SECTION A-A

SYSTEM NO. CAJ1015

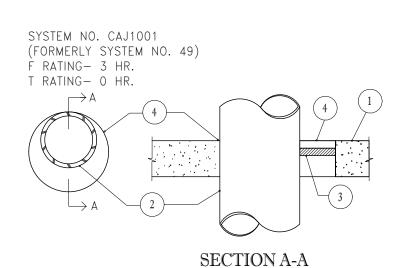

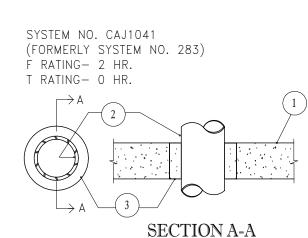

SYSTEM NO. WL2082 F RATING- 1 AND 2 HR. (SEE ITEM 1) T RATING- 1 HR.

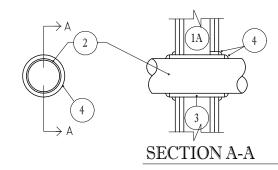

1. FLOOR OR WALL ASSEMBLY- MIN.2-1/2 in. THICK REINFORCED LIGHTWEIGHT OR NORMAL WEIGHT (100-150 PCF) CONCRETE. WALL MAY ALSO BE CONSTRUCTED OF ANY UL CLASSIFIED CONCRETE BLOCK\*. MAX. DIAM. OF OPENING IS 6 in. .

SEE CONCRETE BLOCKS (CAZT) CATEGORY IN THE FIRE RESISTANCE DIRECTORY FOR NAMES OF MANUFACTURERS.

2. THROUGH PENETRANTS— ONE METALLIC PIPE., CONDUIT OR TUBING TO BE CENTERED WITHIN THE FIRESTOP SYSTEM. A NOM. ANNULAR SPACE OF 3/4 in. IS REQUIRED WITHIN THE FIRESTOP SYSTEM. PIPE, CONDUIT OR TUBING TO BE RIGIDLY SUPPORTED ON BOTH SIDES OF FLOOR OR WALL ASSEMBLY. THE FOLLOWING TYPES

AND SIZES OF METALLIC PIPES, CONDUITS OR TUBING MAY BE USED: A. STEEL PIPE NOM. 4 in. DIAM. (OR SMALLER ) SCHEDULE 5 (OR HEAVIER) STEEL PIPE.

NOM. 4 in. DIAM. (OR SMALLER) STEEL ELECTRICAL MATALLIC TUBING OR STEEL CONDUIT.

PACKING MATERIAL MIN 1-1/2 in. THICKNESS OF MIN. 4 PCF MINERAL WOOL BATT INSULATION FIRMLY PACKED INTO OPENING AS A PERMANENT FORM. PACKING MATERIAL TO BE RECESSED FROM BOTH SURFACES OF FLOOR OR WALL AS REQUIRED TO ACCOMMODATE THE REQUIRED THICKNESS OF FILL MATERIAL

4. FILL, VOID OR CAVITY MATERIAL\*-SEALANT -MIN. 1/2 in. THICKNESS OF FILL MATERIAL TO BE APPLIED AT BOTH SURFACES OF FLOOR OR WALL ASSEMBLY.

1. FLOOR OR WALL ASSEMBLY- MIN 4-1/2 in THICK LIGHTWEIGHT OR NORMAL WEIGHT (100-150 PCF)

MINNESOTA MINING & MFG. CO.- TYPES FB-2000 , FB-2000+ ,FB-2003 (TOP SURFACE OF FLOORS

ONLY). (NOTE: L RATINGS APPLY WHEN FB-2000+ IS USED) \* BEARING THE UL CLASSSIFICATION MARKING

CONCRETE. WALL MAY ALSO BE CONSTRUCTED OF ANY UL CLASSIFIED CONCRETE BLOCKS\*. MAX DIAM. OF CIRCULAR THROUGH OPENING IS 22-1/2"IN.

SEE CONCRETE BLOCKS (CAZT) CATEGORY IN THE FIRE RESISTANCE DIRECTORY FOR NAMES OF MANFACTURERS. 1A. STEEL SLEEVE - (OPTIONAL, NOT SHOWN)- NOM 12 in. DIAM. (OR SMALLER ) SCHEDULE 40 (OR

HEAVIER) STEEL PIPE SLEEVE CAST INTO CONCRETE FLOOR OR WALL. SLEEVE TO BE FLUSH WITH OR PROJECT MAX 2 in. FROM TOP SURFACE OF FLOOR OR FROM BOTH SURFACES OF WALL.

2. PIPE OR CONDUIT -NOM. 20 IN. DIAM. (OR SMALLER) SCHEDULE 10 (OR HEAVIER) STEEL PIPE, NOM 6 in. DIAM. (OR SMALLER ) RIGID STEEL CONDUIT OR TYPE L (OR HEAVIER) COPPER TUBE, NOM 4 in. DIAM. (OR SMALLER) CAST IRON PIPE OR STEEL EMT. MAX ONE PIPE OR CONDUIT PER THROUGH OPENING MAX ANNULAR SPACE BETWEEN PIPE OR CONDUIT AND EDGE OF THROUGH OPENING NOT TO EXCEED 2-1/2 in. MIN. ANNULAR SPACE BETWEEN PIPE OR CONDUIT AND EDGE OF THROUGH OPENING IS ZERO IN. (POINT CONTACT). PIPE OR CONDUIT TO BE RIGIDLY SUPPORTED ON BOTH SIDES OF FLOOR OR WALL

3. PACKING MATERIAL— POLYETHYLENE BACKER ROD OR NOM 1 in. THICKNESS OF TIGHTLY-PACKED CERAMIC (ALUMINA SILICA ) FIBER BLANKET. MINERAL-WOOL BATT OR GLASS FIBER INSULATION MATERIAL USED AS A PERMANENT FORM. PACKING MATERIAL TO BE RECESSED FROM TOP SURFACE OF FLOOR OR FROM BOTH SURFACES OF WALL AS REQUIRED TO ACCOMMODATE THE REQUIRED THICKNESS OF CAULK FILL MATERIAL (ITEM 4). AS AN ALTERNATE WHEN MAX PIPE SIZE IS 10 in. DIAM. AND WHEN MAX ANNULAR SPACE IS 1 in. A MIN. 1 in. THICKNESS OF TIGHTLY-PACKED CERAMIC FIBER BLANKET OR MINERAL-WOOL BATT PACKING MATERIAL MAY BE RECESSED MIN 1/2 in. FROM BOTTOM SURFACE OF FLOOR OR FROM EITHER SIDE OF WALL.

4. FILL, VOID OR CAVITY MATERIALS—CAULK— APPLIED TO FILL ANNULAR SPACE TO THE MIN. THICKNESS SHOWN IN THE FOLLOWING TABLE:

MAX ANNULAR SPACE IN	PACKING MATERIAL TYPE (a)	MIN CALUK THKNS IN
1	BR, CF, GF OR MW	1/2 (b)
1	CF OR MW	1/2 (C)
2-1/2	BR, CF, GF OR MW	1 (b)
	SPACE IN  1 1	SPACE IN TYPE (a)  1 BR, CF, GF OR MW 1 CF OR MW

(a) BR= POLYETHYLENE BACKER ROD CF= CERAMIC FIBER BLANKET. GF= GLASS FIBER INSULATION MW= MINERAL-WOOL BATT

(b) CAULK INSTALLED FLUSH WITH TOP SURFACE OF FLOOR OR BOTH SURFACES OF WALL (C) CAULK INSTALLED FLUSH WITH BOTTOM SURFACE OF FLOOR OR ONE SURFACE OF WALL

MINNESOTA MINING & MFG. CO.— -TYPE CP 25 N/S \*BEARING THE UL CLASSIFICATION MARKING

1. FLOOR OR WALL ASSEMBLY- MIN. 3-1/4 in. THICK REINFORCED LIGHTWEIGHT OR NORMAL WEIGHT (100-150 PCF) CONCRETE. WALL MAY ALSO BE CONSTRUCTED OF ANY UL CLASSIFIED CONCRETE BLOCK\*. MAX. DIAM. OF OPENING 6 in. .

SEE CONCRETE BLOCKS (CAZI) CATEGORY IN THE FIRE RESISTANCE DIRECTORY FOR NAMES OF MANFACTURERS.

2. THROUGH PENETRANTS- ONE METALLIC PIPE, CONDUIT OR TUBING TO BE CENTERED WITHIN THE FIRESTOP SYSTEM. A NOM. ANNULAR SPACE OF 3/4 in. IS REQUIRED WITHIN THE FIRESTOP SYSTEM. PIPE, CONDUIT OR TUBING TO BE RIGIDLY SUPPORTED ON BOTH SIDES OF FLOOR OR WALL ASSEMBLY. THE FOLLOWING TYPES AND SIZES OF METALLIC PIPES, CONDUITS OR TUBING MAY BE USED:

A. STEEL PIPE NOM. 4 in. DIAM. (OR SMALLER ) SCHEDULE 5 (OR HEAVIER) STEEL PIPE.

B. CONDUIT NOM. 4 in. DIAM. (OR SMALLER) STEEL ELECTRICAL METALLIC TUBING OR STEEL CONDUIT.

3. FILL, VOID OR CAVITY MATERIAL\*-PUTTY -MIN. 3-1/4 in. THICKNESS OF FILL MATERIAL APPLIED WITHIN THE ANNULUS, FLUSH WITH BOTH SURFACES OF FLOOR OR WALL.

NELSON FIRESTOP PRODUCTS- TYPE FSP PUTTY

\*BEARING THE UL CLASSIFICATION MARKING

1. WALL ASSEMBLY— THE 1 OR 2 H FIRE RATED GYPSUM WALLBOARD/STUD WALL ASSEMBLY SHALL BE CON— STRUCTED OF THE MATERIALS AND IN THE MANNER DESCRIBED IN THE INDIVIDUAL U300 OR U400 SERIES WALL AND PARTITION DESIGNS IN THE UL FIRE RESISTANCE DIRECTORY AND SHALL INCLUDE THE FOLLOWING CONSTRUCTION FEATURES:

A. STUDS — WALL FRAMING MAY CONSIST OF EITHER WOOD STUDS OR STEEL CHANNEL STUDS. WOOD STUDS TO CONSIST OF NOM. 2 BY 4 IN. LUMBER SPACED 16 IN. OC. STEEL STUDS TO BE MIN 2-1/2 IN. WIDE AND

B. WALLBOARD. GYPSUM\* - ONE OR TWO LAYERS OF NOM 1/2 OR 5/8 IN. THICK GYPSUM WALLBOARD AS SPECIFIED IN THE INDIVIDUAL WALL AND PARTITION DESIGN. THE HOURLY F RATING OF THE FIRESTOP SYSTEM IS EQUAL TO THE HOURLY FIRE RATING OF THE WALL ASSEMBLY IN WHICH IT IS INSTALLED.

2. THROUGH PENETRANTS - ONE NONMETALLIC PIPE TO BE CENTERED WITHIN THE FIRESTOP SYSTEM. PIPE TO BE RIGIDLY SUPPORTED ON BOTH SIDES OF WALL ASSEMBLY. THE FOLLOWING TYPES AND SIZES OF NONME-TALLIC PIPES MAY BE USED:

A. POLYVINYL CHLORIDE (PVC) PIPE - NOM 2 AND 3 IN. DIAM. SCHEDULE 40 PVC PIPE FOR USE IN CLOSED (PROCESS OR SUPPLY) OR VENTED (DRAIN, WASTE OR VENT) PIPING SYSTEM.

B. CHLORINATED POLYVINYL CHLORIDE (CPVC) PIPE - NOM 2 AND 3 IN. DIAM. SDR17 CPVC PIPE FOR USE IN CLOSED (PROCESS OR SUPPLY) PIPING SYSTEM.


3. FIRESTOP DEVICE - GALV. STEEL COLLAR LINED WITH INTUMESCENT WRAP STRIPS SIZED TO FIT THE SPECIFIC DIAM. OF THE THROUGH—PENETRANT. PRIOR TO THE INSTALLATION OF THE DEVICE INTO THE OPENING, THE GYP— SUM WALLBOARD IS TO BE NOTCHED ON ONE SIDE OF WALL TO ALLOW THE INSERTION OF THE DEVICE WITH THE HOSE CLAMP INTO THE OPENING. NOTCHED OPENING TO BE COMPLETELY FILLED WITH FILL, VOID OR CAVITY MATERIAL (ITEM 4). DEVICE SHALL BE INSTALLED AROUND THROUGH—PENETRANT IN ACCORDANCE WITH ACCOMPANYING INSTALLATION INSTRUCTIONS. THE DEVICE SIZE, DIAM. OF OPENING IN WALL AND ANNULAR SPACE BETWEEN PIPE AND PERIPHERY OF OPENING IS DEPENDENT UPON THE PIPE DIAM. AS SHOWN IN THE FOLLOWING TABLE:


MAX. PIPE		DIAM. OF	
DIAM. (IN.)	DEVICE SIZE	OPENING (IN.)	ANNULAR SPACE
2	TS2	3-1/2	ANNULAR SPACE
3	TS3	4-3/4	9/16
			5/8


TREMCO INC. - FYRE-CAN SLEEVE THE FIRE CAN MANUFACTURING CO., INC. - FYRE-CAN SLEEVE

4. FILL, VOID OR CAVITY MATERIAL\* — CAULK — MIN. 1/4 IN. BEAD OF FILL MATERIAL TO BE APPLIED AT THE INTERFACE OF THE GYPSUM WALL AND FIRESTOP DEVICE AND AT THE INTERFACE OF THE PIPE AND FIRESTOP DEVICE. ADDITIONAL FILL MATERIAL TO BE APPLIED TO FILL THE NOTCH CREATED FOR THE HOSE CLAMP TO THE FULL DEPTH OF THE WALLBOARD. TREMCO INC. - TREMSTOP WBM

\*BEARING THE UL CLASSIFICATION MARKING

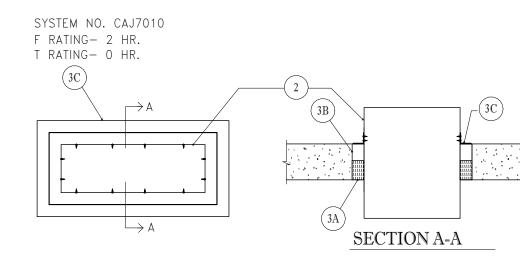

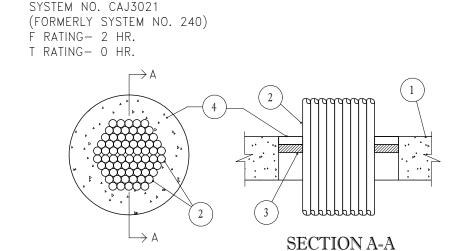

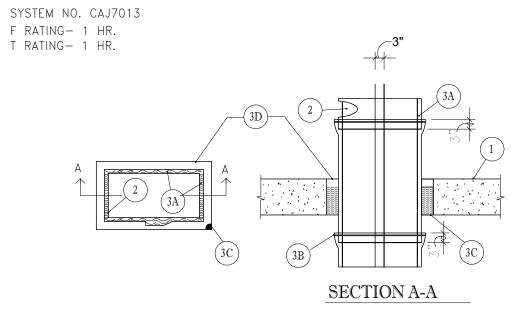

SYSTEM NO. CAJ1036 (FORMERLY SYSTEM NO. 270) F RATING- 2 HR. T RATING- 1-1/2 HR.

SECTION A-A

1. FLOOR OR WALL ASSEMBLY- MIN.4-1/2 in. THICK REINFORCED LIGHTWEIGHT OR NORMAL WEIGHT (100-150 PCF) CONCRETE.FLOOR OR MIN. 6 in. THICK REIFORCED LIGHTWEIGHT OR NORMAL WEIGHT CONCRETE WALL. WALL MAY ALSO BE CONSTRUCTED OF ANY UL CLASSIFIED CONCRETE BLOCKS\*. MAX AREA OF OPENING IS 325 sq.in. WITH MAX DIMENSIONS OF 25 in.

SEE CONCRETE BLOCKS (CAZT) CATEGORY IN THE FIRE RESISTANCE DIRECTORY FOR NAMES OF MANFACTURERS.

ACCOMMODATE THE REQUIRED THICKNESS OF FILL MATERIAL.

1)2. STEEL DUCT- NOM 24 BY 12 in. (OR SMALLER ) NO. 28 GAUGE (OR HEAVIER) STEEL DUCT. ONE DUCT TO BE INSTALLED WITHIN THE FIRESTOP SYSTEM WITH A NOM. 1/2 in. ANNULAR SPACE. STEEL DUCT TO BE RIGIDLY SUPPORTED ON BOTH SIDES OF FLOOR OR WALL ASSEMBLY.

3. FIRESTOP SYSTEM— THE FIRESTOP SYSTEM SHALL CONSIST OF THE FOLLOWING: A. PACKING MATERIAL- MIN 3 in.THICKNESS OF MIN 4 PCF MINERAL WOOL BATT INSULATION FIRMLY PACKED INTO OPENING AS A PERMANENT FORM. PACKING MATERIAL TO BE RECESSED FROM TOP SURFACE OF FLOOR AND FROM BOTH SURFACES OF WALL AS REQUIRED TO

B. FILL, VOID OR CAVITY MATERIAL\*-PUTTY -MIN. 1-1/2 in. THICKNESS OF FILL MATERIAL APPLIED WITHIN THE ANNULUS, FLUSH WITH TOP SURFACE OF FLOOR OR WITH BOTH SURFACES OF WALL.

C. STEEL ANGLE- MIN. 1-1/2 in. WIDE BY 1-1/2in. HIGH BY 0.030 in. (NO. 22 MSG) THICK GALV. STEEL ANGLES CUT TO FIT THE CONTOUR OF THE DUCT WITH A 1 in. LAP ON THE TOP SURFACE OF FLOOR OR BOTH SURFACES OF WALL. LEGS OF ANGLES SECURED TO DUCT WITH MIN. NO. 12 SHEET METAL SCREWS , SPACED A MAX 4 in. oc.

\*BEARING THE UL CLASSIFICATION MAKING

\*BEARING THE UL CLASSIFICATION MARKING

1. FLOOR OR WALL ASSEMBLY- MIN.4-1/2 in. THICK LIGHTWEIGHT OR NORMAL WEIGHT (100-150 PCF) CONCRETE. WALL MAY ALSO BE CONSTRUCTED OF ANY UL CLASSIFIED CONCRETE BLOCK\*. MAX. DIAM. OF OPENING IS 6-1/4 in. .

SEE CONCRETE BLOCKS (CAZT) CATEGORY IN THE FIRE RESISTANCE DIRECTORY FOR NAMES OF MANFACTURERS.

1A.STEEL SLEEVE - (OPTIONAL, NOT SHOWN)- NOM 4 in. DIAM. (OR SAMLLER ) SCHEDULE 10 (OR HEAVIER) STEEL PIPE SLEEVE CAST INTO FLOOR OR WALL ASSEMBLY. SLEEVE TO BE FLUSH WITH FLOOR OR WALL SURFACES.

2. CABLES- MIN. 12 PERCENT TO MAX 40 PERCENT FILL AREA PER MAX 4 in. DIAM. STEEL SLEEVED THROUGH OPENING . MIN. 20 PERCENT TO MAX 40 PERCENT FILL AREA PER MAX 6-1/4 in. DIAM. UNSLEEVED THROUGH OPENING. CABLES TO BE RIGIDLY SUPPORTED ON BOTH SIDES OF FLOOR OR WALL ASSEMBLY. THE FOLLOWING TYPES AND SIZES OF CABLE MAY BE USED:

A. MAX. NO. 12 AWG MULTIPLE COPPER CONDUCTOR POWER & CONTROL CABLES WITH POLYVINYL CHLORIDE (PVC) INSULATION AND JACKET MATERIALS.

B. MULTIPLE FIBER OPTICAL COMMUNICATION CABLE JACKETED WITH PVC AND HAVING A MAX OUTSIDE DIAM. OF 3/4in. .

C. MAX 150 PAIR NO. 24 AWG COPPER CONDUCTOR TELEPHONE CABLES PVC INSULATION AND

3. PACKING MATERIAL- NOM. 1 in. THICKNESS OF CERAMIC (ALUMINUM SILICA) FIBER BLANKET OR MINERAL WOOL BATT INSULATION FIRMLY PACKED INTO OPENING AS A PERMANENT FORM. PACKING MATERIAL TO BE RECESSED MIN. 1 in. FROM TOP SURFACE OF FLOOR OR FROM BOTH SURFACES OF WALL.

4. FILL, VOID , OR CAVITY MATERIALS\*-PUTTY- MOLDABLE PUTTY MATERIAL KNEADED BY HAND AND APPLIED TO FILL ANNULAR SPACE (AND INTERSTICES BETWEEN CABLES TO MAX EXTENT POSSIBLE ) TO A MIN. DEPTH OF 1 in. FLUSH WITH TOP SURFACE OF FLOOR. IN WALL ASSEMBLIES, REQUIRED PUTTY DEPTH TO BE INSTALLED SYMMETRICALLY ON BOTH SIDES OF WALL. MINNESOTA MINING & MFG. CO.- TYPE MPS-2 +

1. FLOOR OR WALL ASSEMBLY- MIN.4-1/2 in. THICK REINFORCED NORMAL WEIGHT (140-150 PCF) CONCRETE. FLOOR OR MIN. 4-3/4 in. THICK REIFORCED NORMAL WEIGHT CONCRETE WALL. WALL MAY ALSO BE CONSTRUCTED OF ANY UL CLASSIFIED CONCRETE BLOCKS\*. MAX AREA OF OPENING IS 3069 sq.in. WITH A MAX. DIMENSION OF 93 in.

2. STEEL DUCT- MIN. 0.021 in. THICK STEEL DUCT HAVING A MAX PERIMETER DIMENSION OF 216 in. AND A MAX INDIVIDUAL DIMENSION OF 84 in. . ONE DUCT TO BE CENTERED WITHIN THE FIRESTOP SYSTEM. DUCT TO BE RIGIDLY SUPPORTED ON BOTH SIDES OF FLOOR OR WALL ASSEMBLY. IN ADDITION , FOR DUCTS WITH ANY DIMENSION GREATER THAN 39 in. A 1-1/2in. BY 1-1/2in. by 1/8in. THICK TRANSVERSE STIFFENING ANGLE APPROXIMATELY 2 in LESS IN LENGTH THAN THE MAX DIMENSION SHALL BE SCREW ATTACHED 8 In O.C. TO THE DUCT, 3in. BEYOND THE TOP SURFACE OF THE FLOOR AND BOTH SURFACES OF THE WALL.

FIRESTOP SYSTEM— THE FIRESTOP SYSTEM SHALL CONSIST OF THE FOLLOWING: A. DUCT WRAP MATERIALS\* NOM 1-1/2 in. THICK, 6 PCF REFRACTORY CERAMIC BLANKET TOTALLY ENCAPSULATED WITHIN FOIL—SCRIM FACERS. THE STEEL DÚCT SHALL BÉ WRAPPED WITH ONE LAYER OF DUCT WRAP INSTALLED IN ACCORDANCE WITH THE MANUFACTURER'S INSTALLTION INSTRUCTIONS, MAINTAINING MIN. 3 in. TRANSVERSE AND LONGITUDINAL OVERLAPS. ALL CUT EDGES AND ENDS SHALL BE SEALED WITH 3 in. WIDE PRESSURE SENSITIVE ALUMINUM FOIL TAPE. A NOMINAL ANNULAR SPACE OF 3 in. IS REQUIRED BETWEEN THE INSULATED DUCT AND THE PERIPHERY OF THE OPENING.

\*MINNESOTA MINING & MFG. CO.— FIREMASTER DUCT WRAP

B. STEEL BANDING STRAPS- 1/2in. WIDE BY 0.015 in. THICK CARBON STEEL BANDING STRAPS USED IN CONJUNCTION WITH 1/2in. WIDE BY 1 in. LONG STAINLESS STEEL CRIMP CLIPS. BANDING STRAPS SPACED A MAX 12 in. OC AND 3 in. FROM TRANSVERSE JOINTS OF DUCT WRAP.

C. PACKING MATERIAL MIN. 4-1/4 in. THICKNESS OF UNFACED SCRAP DUCT WRAP MATERIAL OR 3 PCF MINERAL WOOL BATT INSULATION FIRMLY PACKED INTO OPENING AS A PERMANENT FORM. PACKING MATERIAL TO BE RECESSED FROM THE TOP SURFACE OF THE FLOOR OR BOTH SURFACES OF WALL TO ACCOMMODATE THE REQUIRED THICKNESS OF FILL MATEIAL.

D. FILL, VOID OR CAVITY MATERIAL\*—CAULK —MIN. 1/4in. THICKNESS OF FILL MATERIAL APPLIED WITHIN THE ANNULUS, FLUSH WITH TOP SURFACE OF FLOOR OR BOTH SURFACES OF WALL. \*MINNESOTA MINING & MFG. CO.- FB-2000+

\*BEARING THE UL CLASSIFICATION MARKING

1. FLOOR OR WALL ASSEMBLY- MIN.4-1/2 in. THICK REINFORCED LIGHTWEIGHT OR NORMAL WEIGHT (100-150 PCF) CONCRETE. WALL MAY ALSO BE CONSTRUCTED OF ANY UL CLASSIFIED CONCRETE BLOCKS\*. MAX. DIAM. OF OPENING IS 8 in. .

SEE CONCRETE BLOCKS (CAZT) CATEGORY IN THE FIRE RESISTANCE DIRECTORY FOR NAMES OF MANFACTURERS.

2. METALLIC PIPES- NOM. 1 in. DIAM. (OR SMALLER ) SCHEDULE 40 (OR HEAVIER) STEEL PIPE. A MAX OF FIVE PIPES TO BE INSTALLED WITHIN THE OPENING. THE SPACE BETWEEN PIPES SHALL BE MIN. 1/2 in. THE SPACE BETWEEN PIPES AND PERIPHERY OF OPENING SHALL BE 1/2 in. MAX 3-1/2 in. PIPES TO BE RIGIDLY SUPPORTED ON BOTH SIDES OF FLOOR OR WALL ASSEMBLY.

3. FIRESTOP SYSTEM— THE FIRESTOP SYSTEM SHALL CONSIST OF THE FOLLOWING:

A. PACKING MATERIAL— MINERAL WOOL BATT INSULATION FIRMLY PACKED INTO OPENING AS A PERMANENT FORM. PACKING MATERIAL TO BE RECESSED FROM TOP SURFACE OF FLOOR OR FROM BOTH SURFACES OF WALL AS REQUIRED TO ACCOMMODATE THE REQUIRED THICKNESS OF FILL MATERIAL. AS AN OPTION TO THE ABOVE. BACKER ROD AND/OR FOAMED PLASTIC BACKER MATERIAL MAY BE USED.

B. FILL, VOID OR CAVITY MATERIAL\*-CAULK -MIN. 1-1/4 in. THICKNESS OF FILL MATERIAL APPLIED WITHIN THE ANNULUS, FLUSH WITH TOP SURFACE OF FLOOR OR WITH BOTH SURFACES OF WALL.

THE RECTORSEAL CORP.— METACAULK 950 \*BEARING THE UL CLASSSIFICATION MARKING

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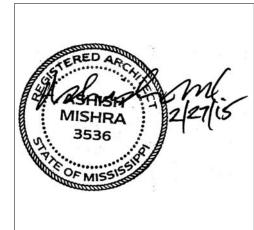
Benchmark Engineering and Surveying 101 Highpointe Court, Suite B Brandon, MS 39042 Phone: (601) 591-1077 Fax: (601) 591-0177 Email:mikebes@bellsouth.net

STRUCTURAL: WGPM, Inc. 11220 Elm Lane, Suite 201 Charlotte, NC 28277 Phone: (704) 542-7199 Fax: (704) 542-7195 Email: lwright@wgpminc.com

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KEY PLAN

Shiva Southaven

Holiday Inn Express & Suites


Lot 16 (Rev Lot 3) Southcrest Pkwy. Southcrest Subdivision Southaven, MS 38671

Drawing Title **UL** Details

Construction Documents

Project No. 14-081 Prepared by Author Checked by Checker

Date Feb. 27, 2015

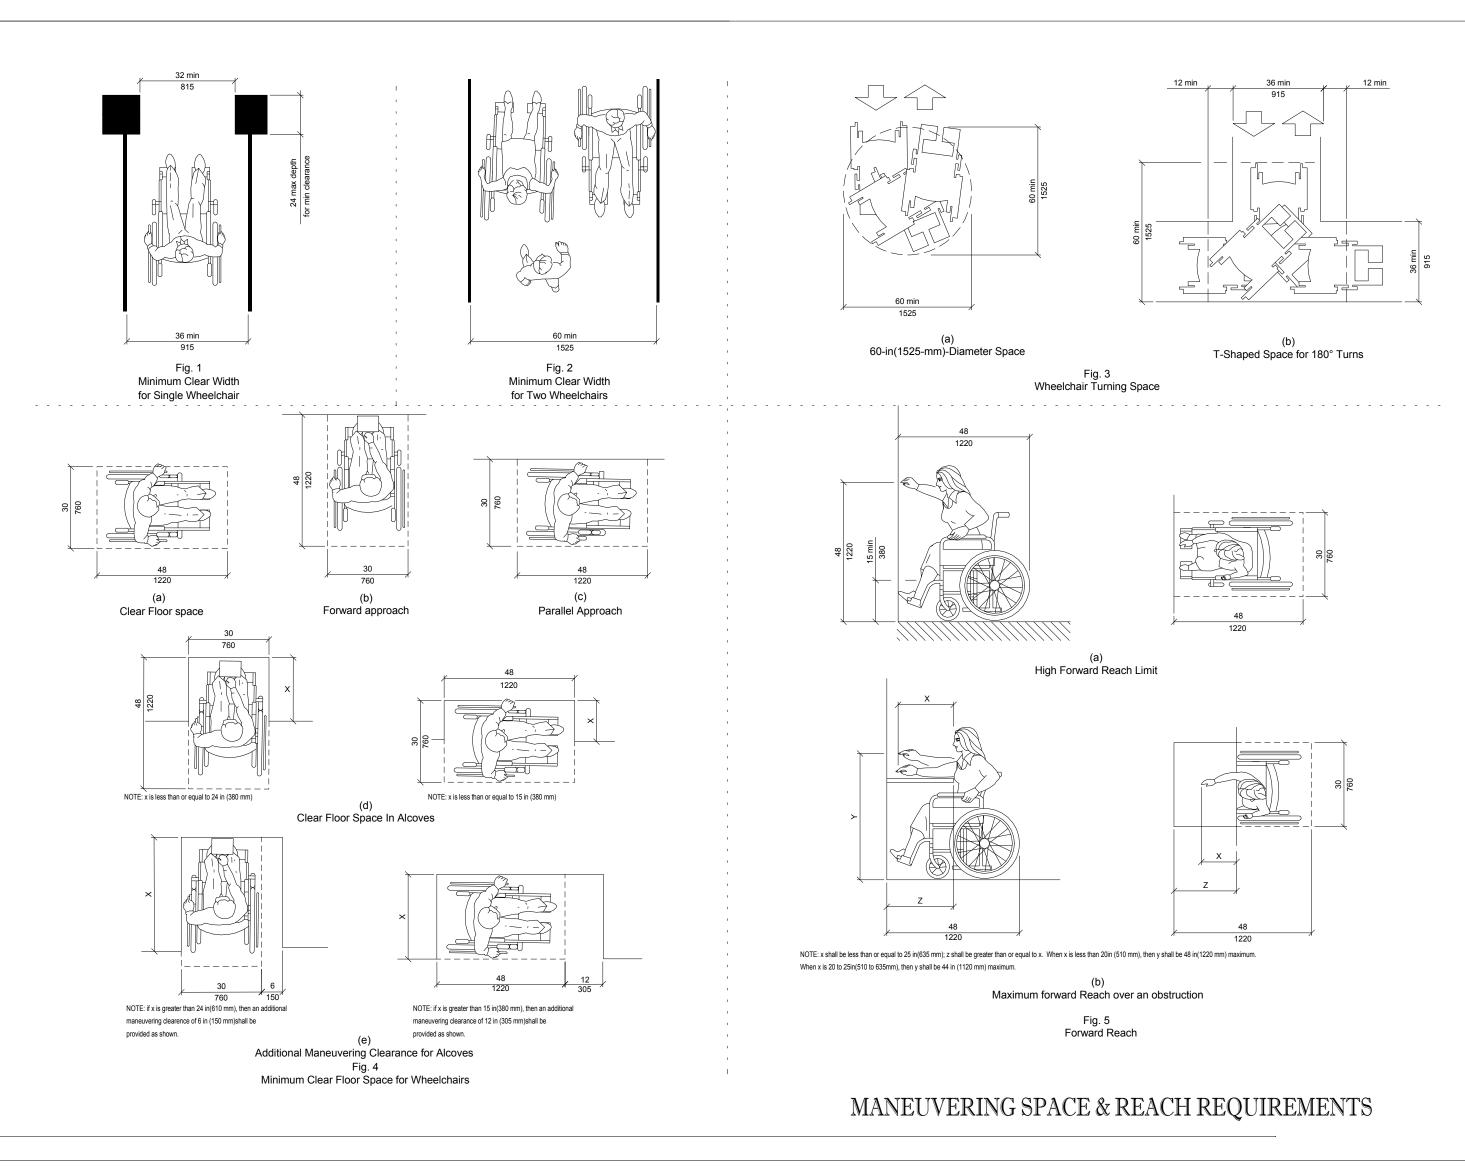

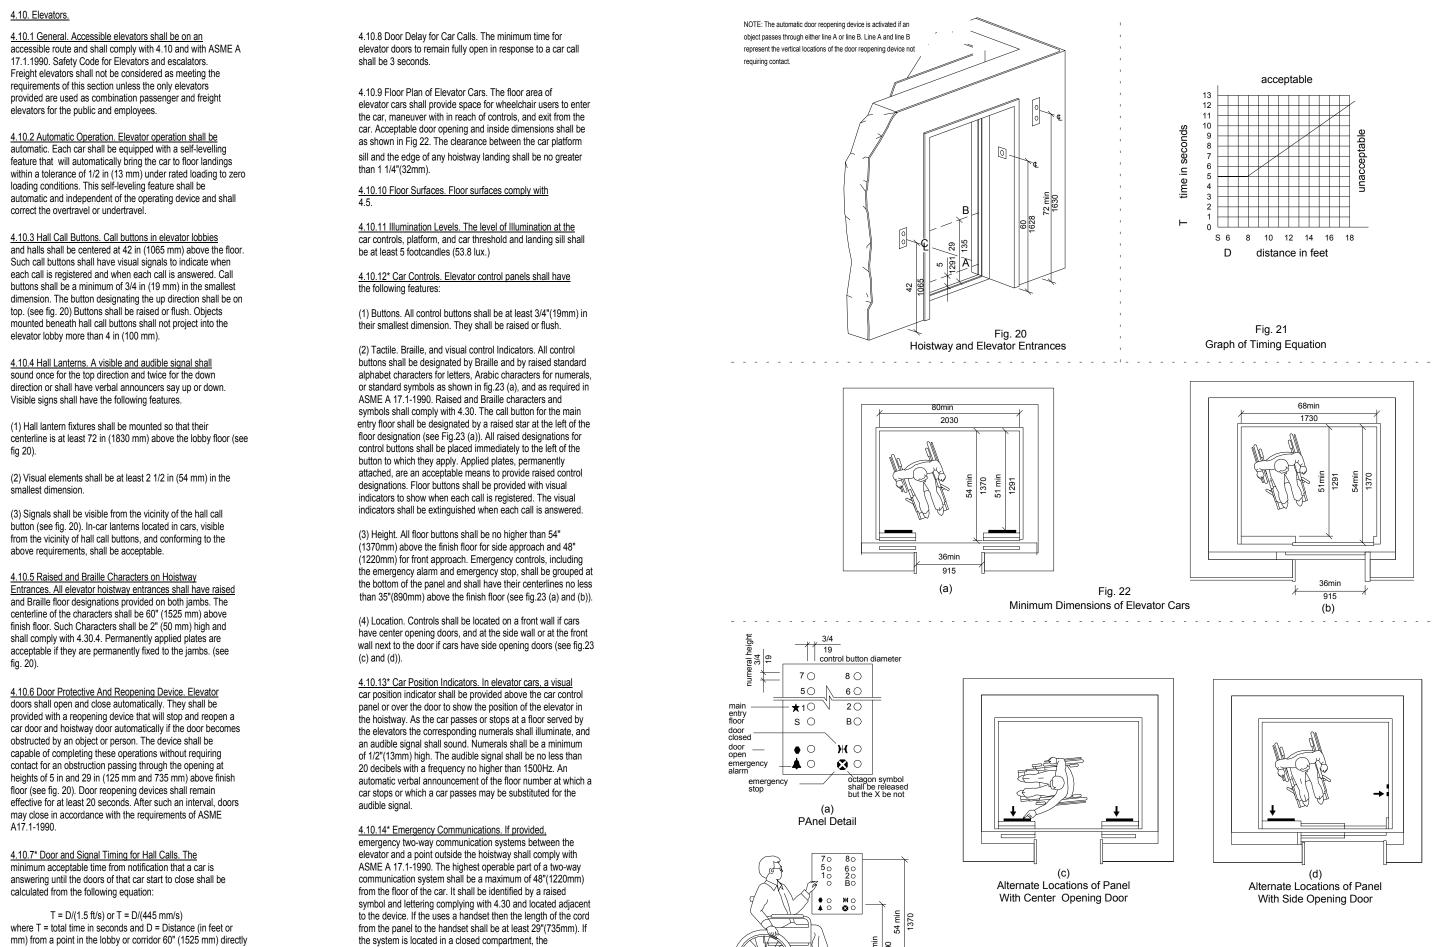


Fig. 23 Car Controls

**ELEVATORS** 

PROTRUDING OBJECTS

4.10. Elevators.

smallest dimension.


in front of the farthest call button controlling that car to the

centerline o fits hoistway door (see fig. 21). For cars with in-

car lanterns, T begins when the lantern is visible from the

vicinity of hall call buttons and an audible signal is sounded.

The minimum acceptable notification time shall be 5 seconds.

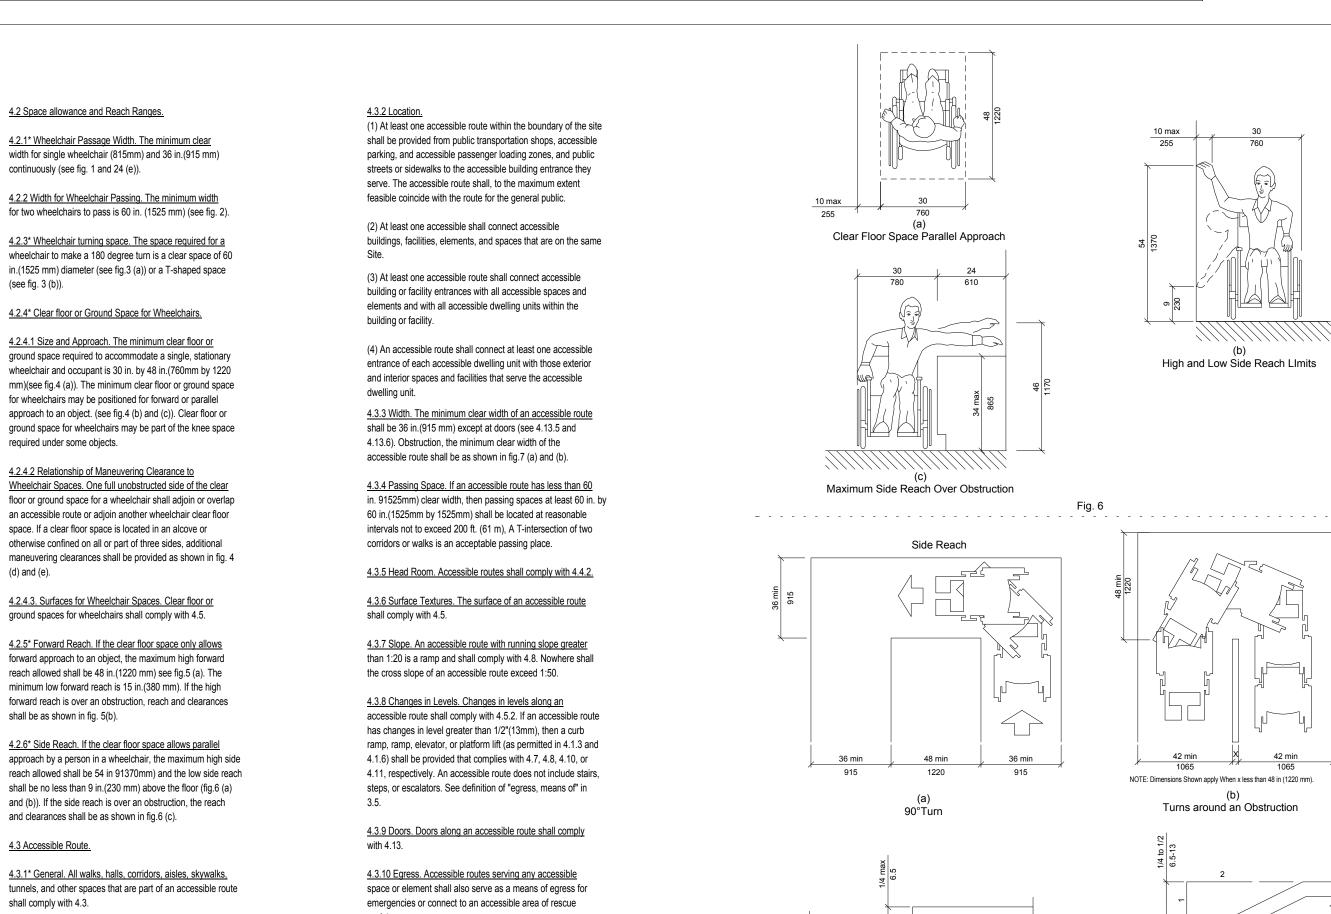


Changes in Level

changes in level

Accessible Route

SPACE ALLOWANCES & REACH RANGES

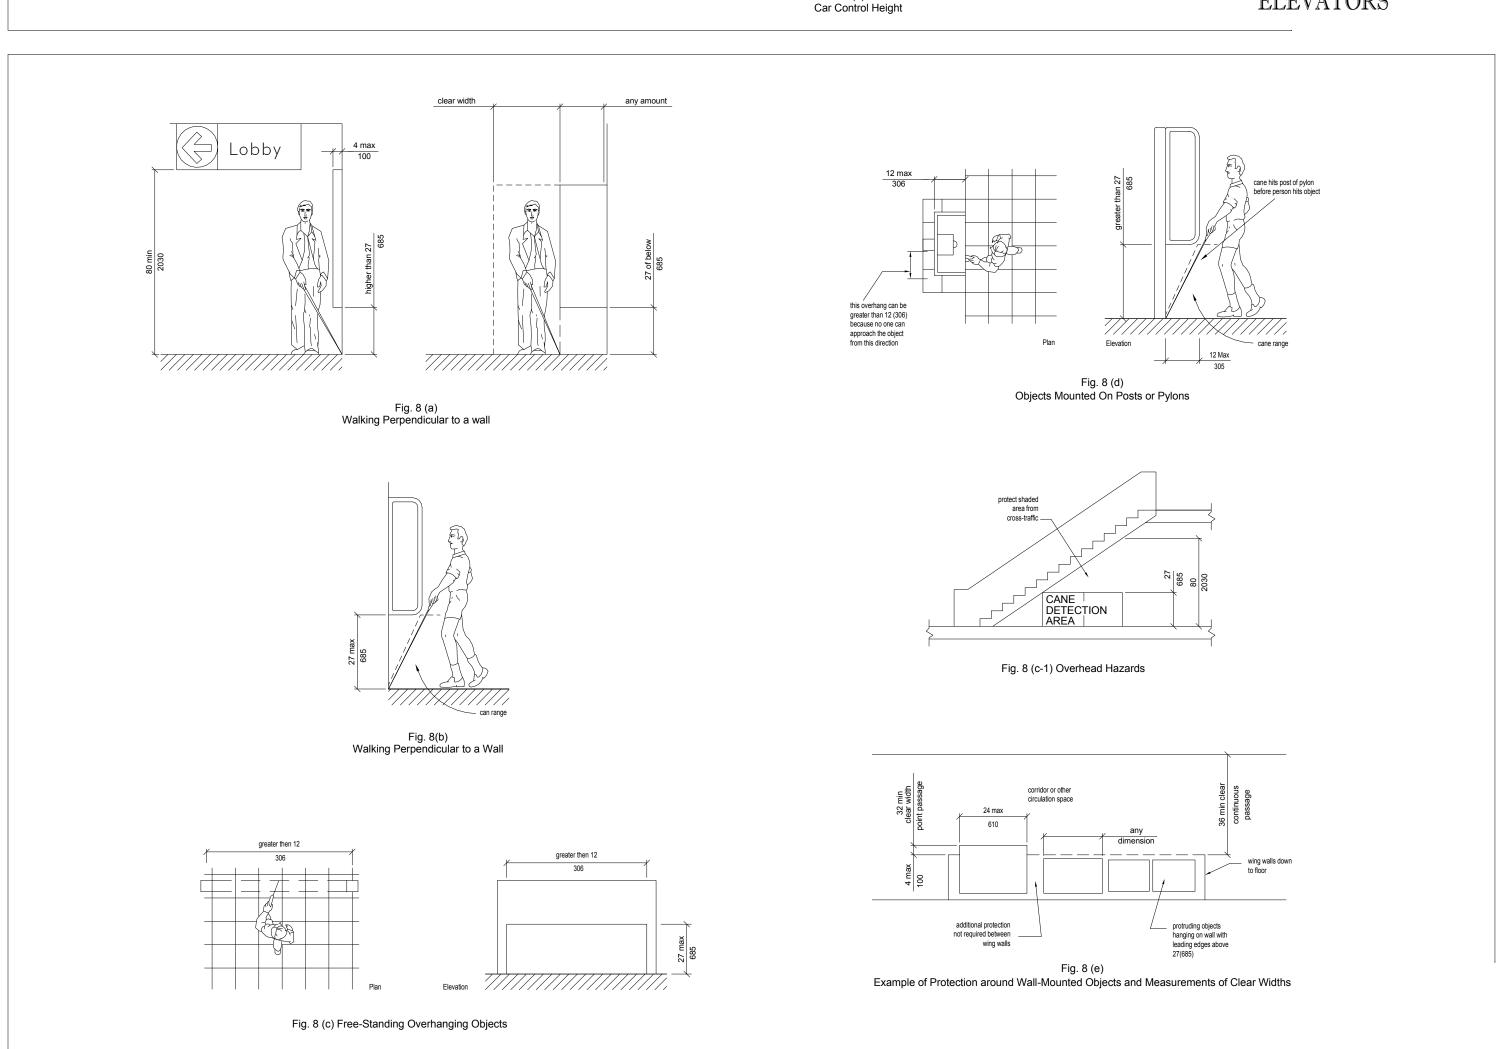


compartment door hardware shall conform to 4.27, Controls

and Operating Mechanisms. The emergency

communication.

intercommunication system shall not require voice

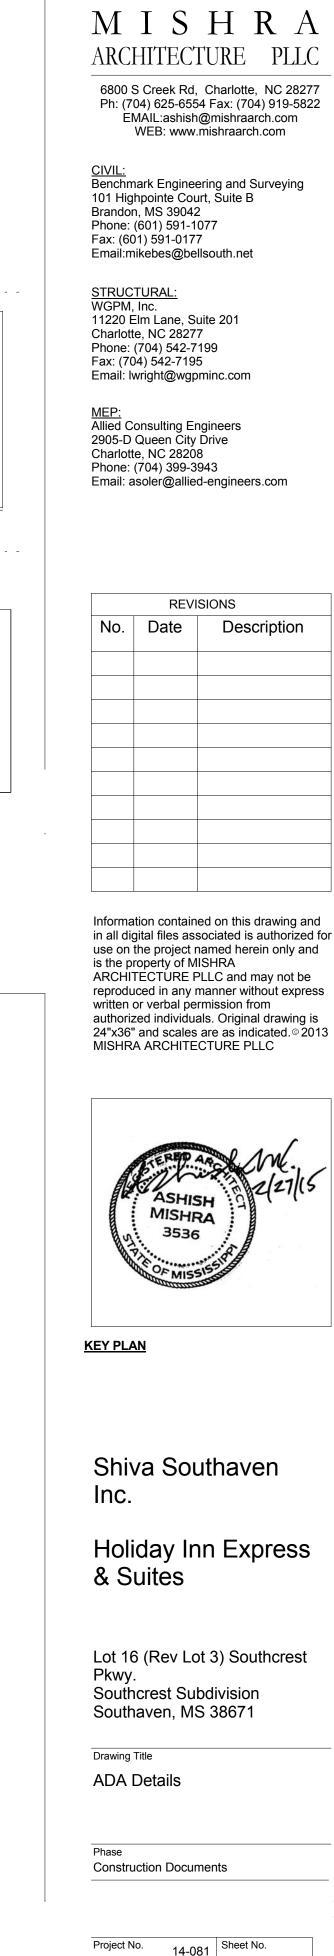


Author

Checker

Checked by

Review


Date Feb. 27, 2015

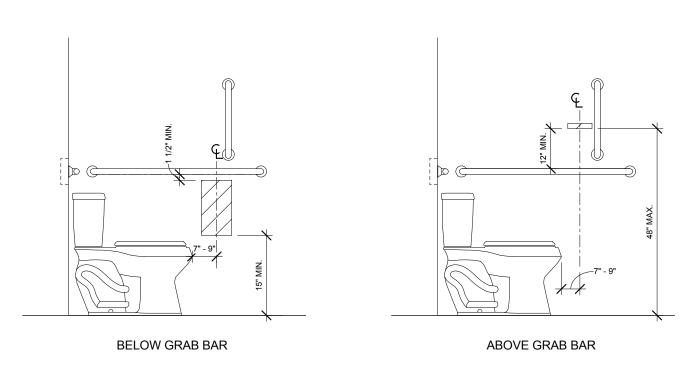

## ADA DISPENSERS

1/2" = 1'-0"


3 ADA Shower Layout 1/2" = 1'-0"

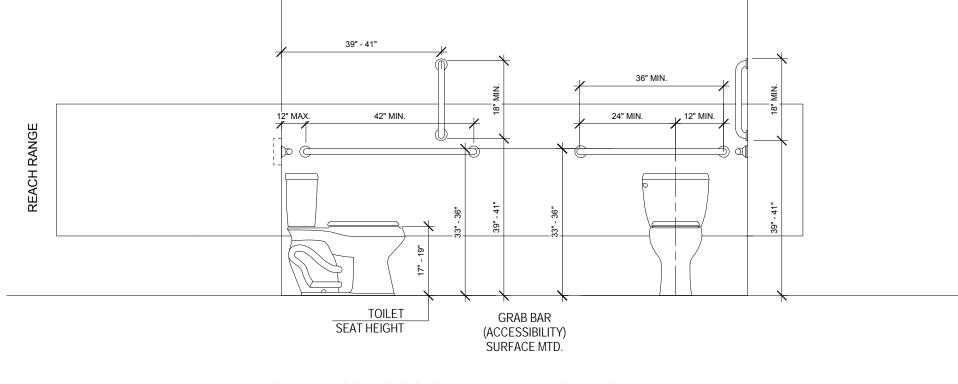



ALL EQUIPMENT CONTROLS SHOULD BE WITHIN REACH RANGE


4 ADA Tub Layout 1/2" = 1'-0"

2 ADA Grab Bars 1/2" = 1'-0"

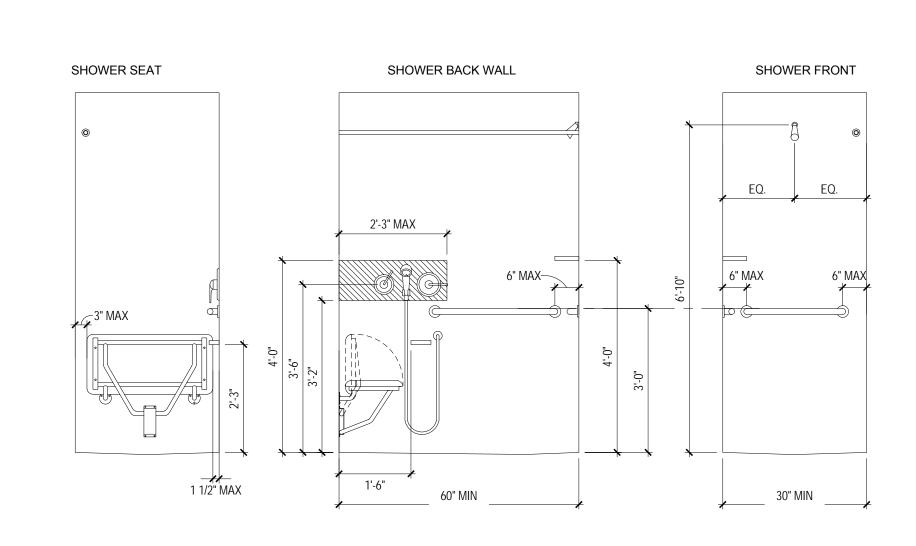

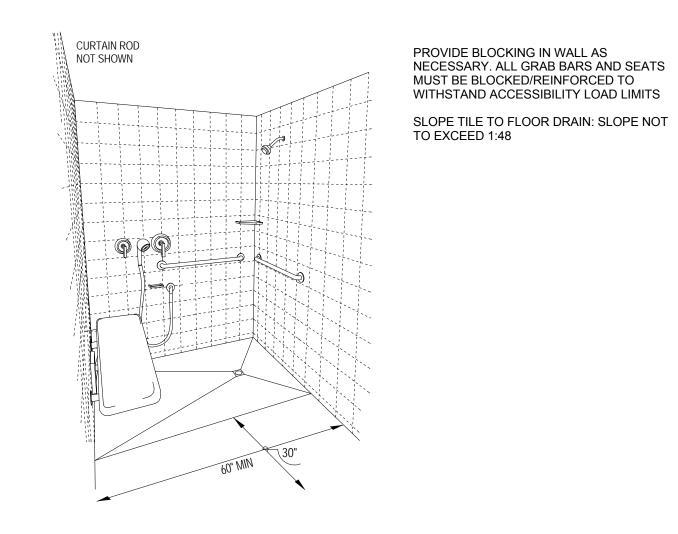

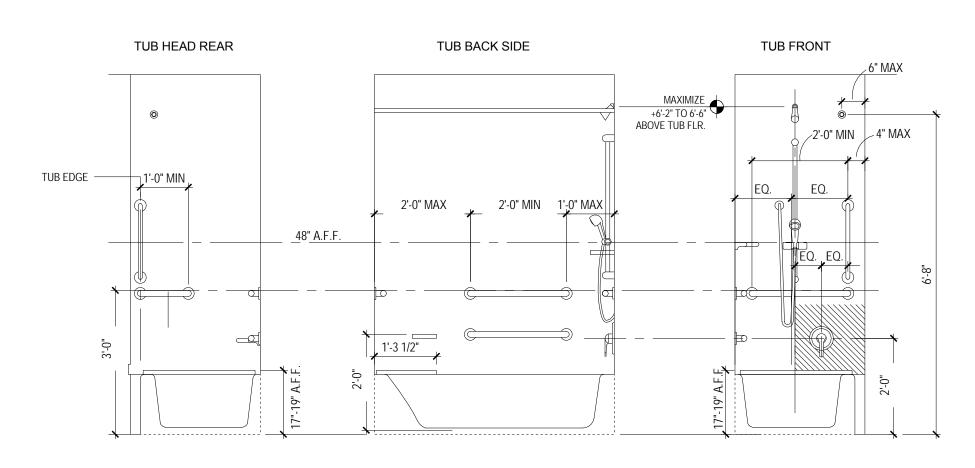

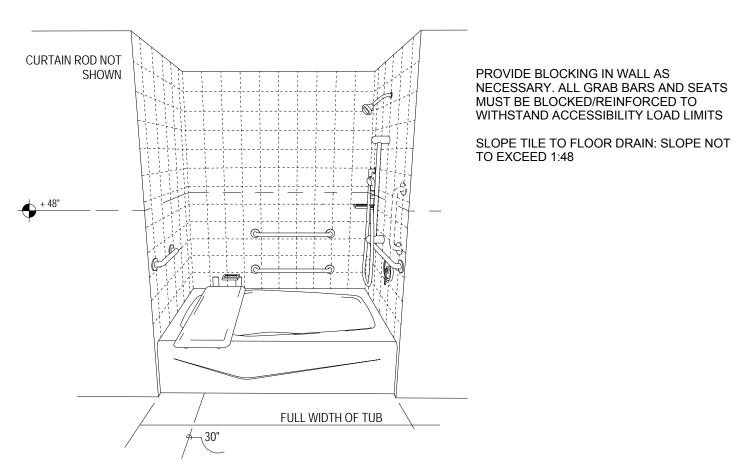

Holiday Inn Express & Suites

Lot 16 (Rev Lot 3) Southcrest Pkwy.

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KEY PLAN

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Shiva Southaven

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Southcrest Subdivision Southaven, MS 38671

**ADA Details** 

Construction Documents

Checked by Checker Date Feb. 27, 2015

### BUILDING AND BATHROOM ACCESSORY PRODUCT SELECTION SCHEDULE

#### CH-1; Bobrick B-6707 satin finished stainless steel finished single utility/coat hook.

CH-S; Bobrick B-232x24 satin finished stainless steel finished coat hook strip 24" long with 3 hooks.

CG-1; C-S Group VA-200N Acrovyn 4000 series 1-1/2" corner guard set 4" AFFL or too match room base. Color 933 Mission White.

CG-2: C-S Group VA-200N Acrovyn 4000 series 1-1/2" corner guard set 4" AFFL or too match room base. Color; Danube 233.

CG-3: C-S Group VA-200N Acrovyn 4000 series 1-1/2" corner guard set 4" AFFL or too match room base. Color; Russet #321

CG-4: C-S Group VA-200N Acrovyn 4000 series 1-1/2" corner guard set 4" AFFL or too match room base. Color; Celery #311

DCS; Bobrick KB110-SSWM horizontal surface mounted baby/diaper changing station with satin stainless steel veneer. Color SST/Grey.

FSB; Bobrick B-5181 reversible ADA compliant folding shower bench/seat.

PC; Personal Computer or Monitor wall mounting bracket provided by owner.

GB; Bobrick B-6806.99 series peened satin stainless steel finished grab bars for accessible toilet and shower stalls, size varies.

MIR FR SH, Bobrick B-292 1830 seried welded satin stainless steel finish framed mirror with 5" shelf, 18" x 30".

MOP-1, Bobrick B-239 satin stainless steel finished mop and broom holder with utility shelf.

PTC; Bobrick B-262 classic series satin stainless steel finished surface mounted paper towel cabinet for folded paper.

SDISP, Bobrick B-2111 classic series surface mounted soap dispensers with satin stainless steel finish.

SND, Bobrick B-270 contura series surface mounted satin stainless steel finish sanitary napkin dispenser.

TPH; Bobrick B-6867 classic series surface mounted satin stainless steel finish two roll toilet paper

FIRE PROTECTION PRODUCTS. US-1; Bobrick B-298 satin stainless steel finished utility shelf 8" x 24".

FIRE EXTINGUISHER CABINET (FEC)
JL INDUSTRIES AMBASSADOR SERIES SEMI RECESSED CABINET.
STEEL CONSTRUCTION, COLOR WHITE.
TUBE SIZE 10 1/2" X 24" X 5 1/2" WITH 1 1/2" SQUARE EDGE TRIM.
VERTICAL DUO STYLE DOOR WITH SAFETY GLASS AND VERTICAL DOOR PULL.

1 HOUR FIRE RATED WHERE LOCATED IN 1 HOUR RATED WALLS. PROVIDE FIRE EXTINGUISHER AS SPECIFIED.


ETCHED VERTICAL LETTERING ON GLASS PANEL.


TYPICAL MOUNTING HEIGHT GENERAL NOTES

1. PROVIDE EQUIPMENT, FIXTURE AND FITTING SUPPORT WOOD OR SHEET METAL BLOCKING IN ACCORDANCE WITH MANUFACTURERS INSTRUCTIONS AND RECOMMENDATIONS, TYP. UNO. SEE ALSO TYPICAL

2. REFER TO PLANS AND SPECIFIC ELEVATION FOR EQUIPMENT, FIXTURE AND FITTING LOCATIONS.

PARTITION BLOCKING DETAILS A900.

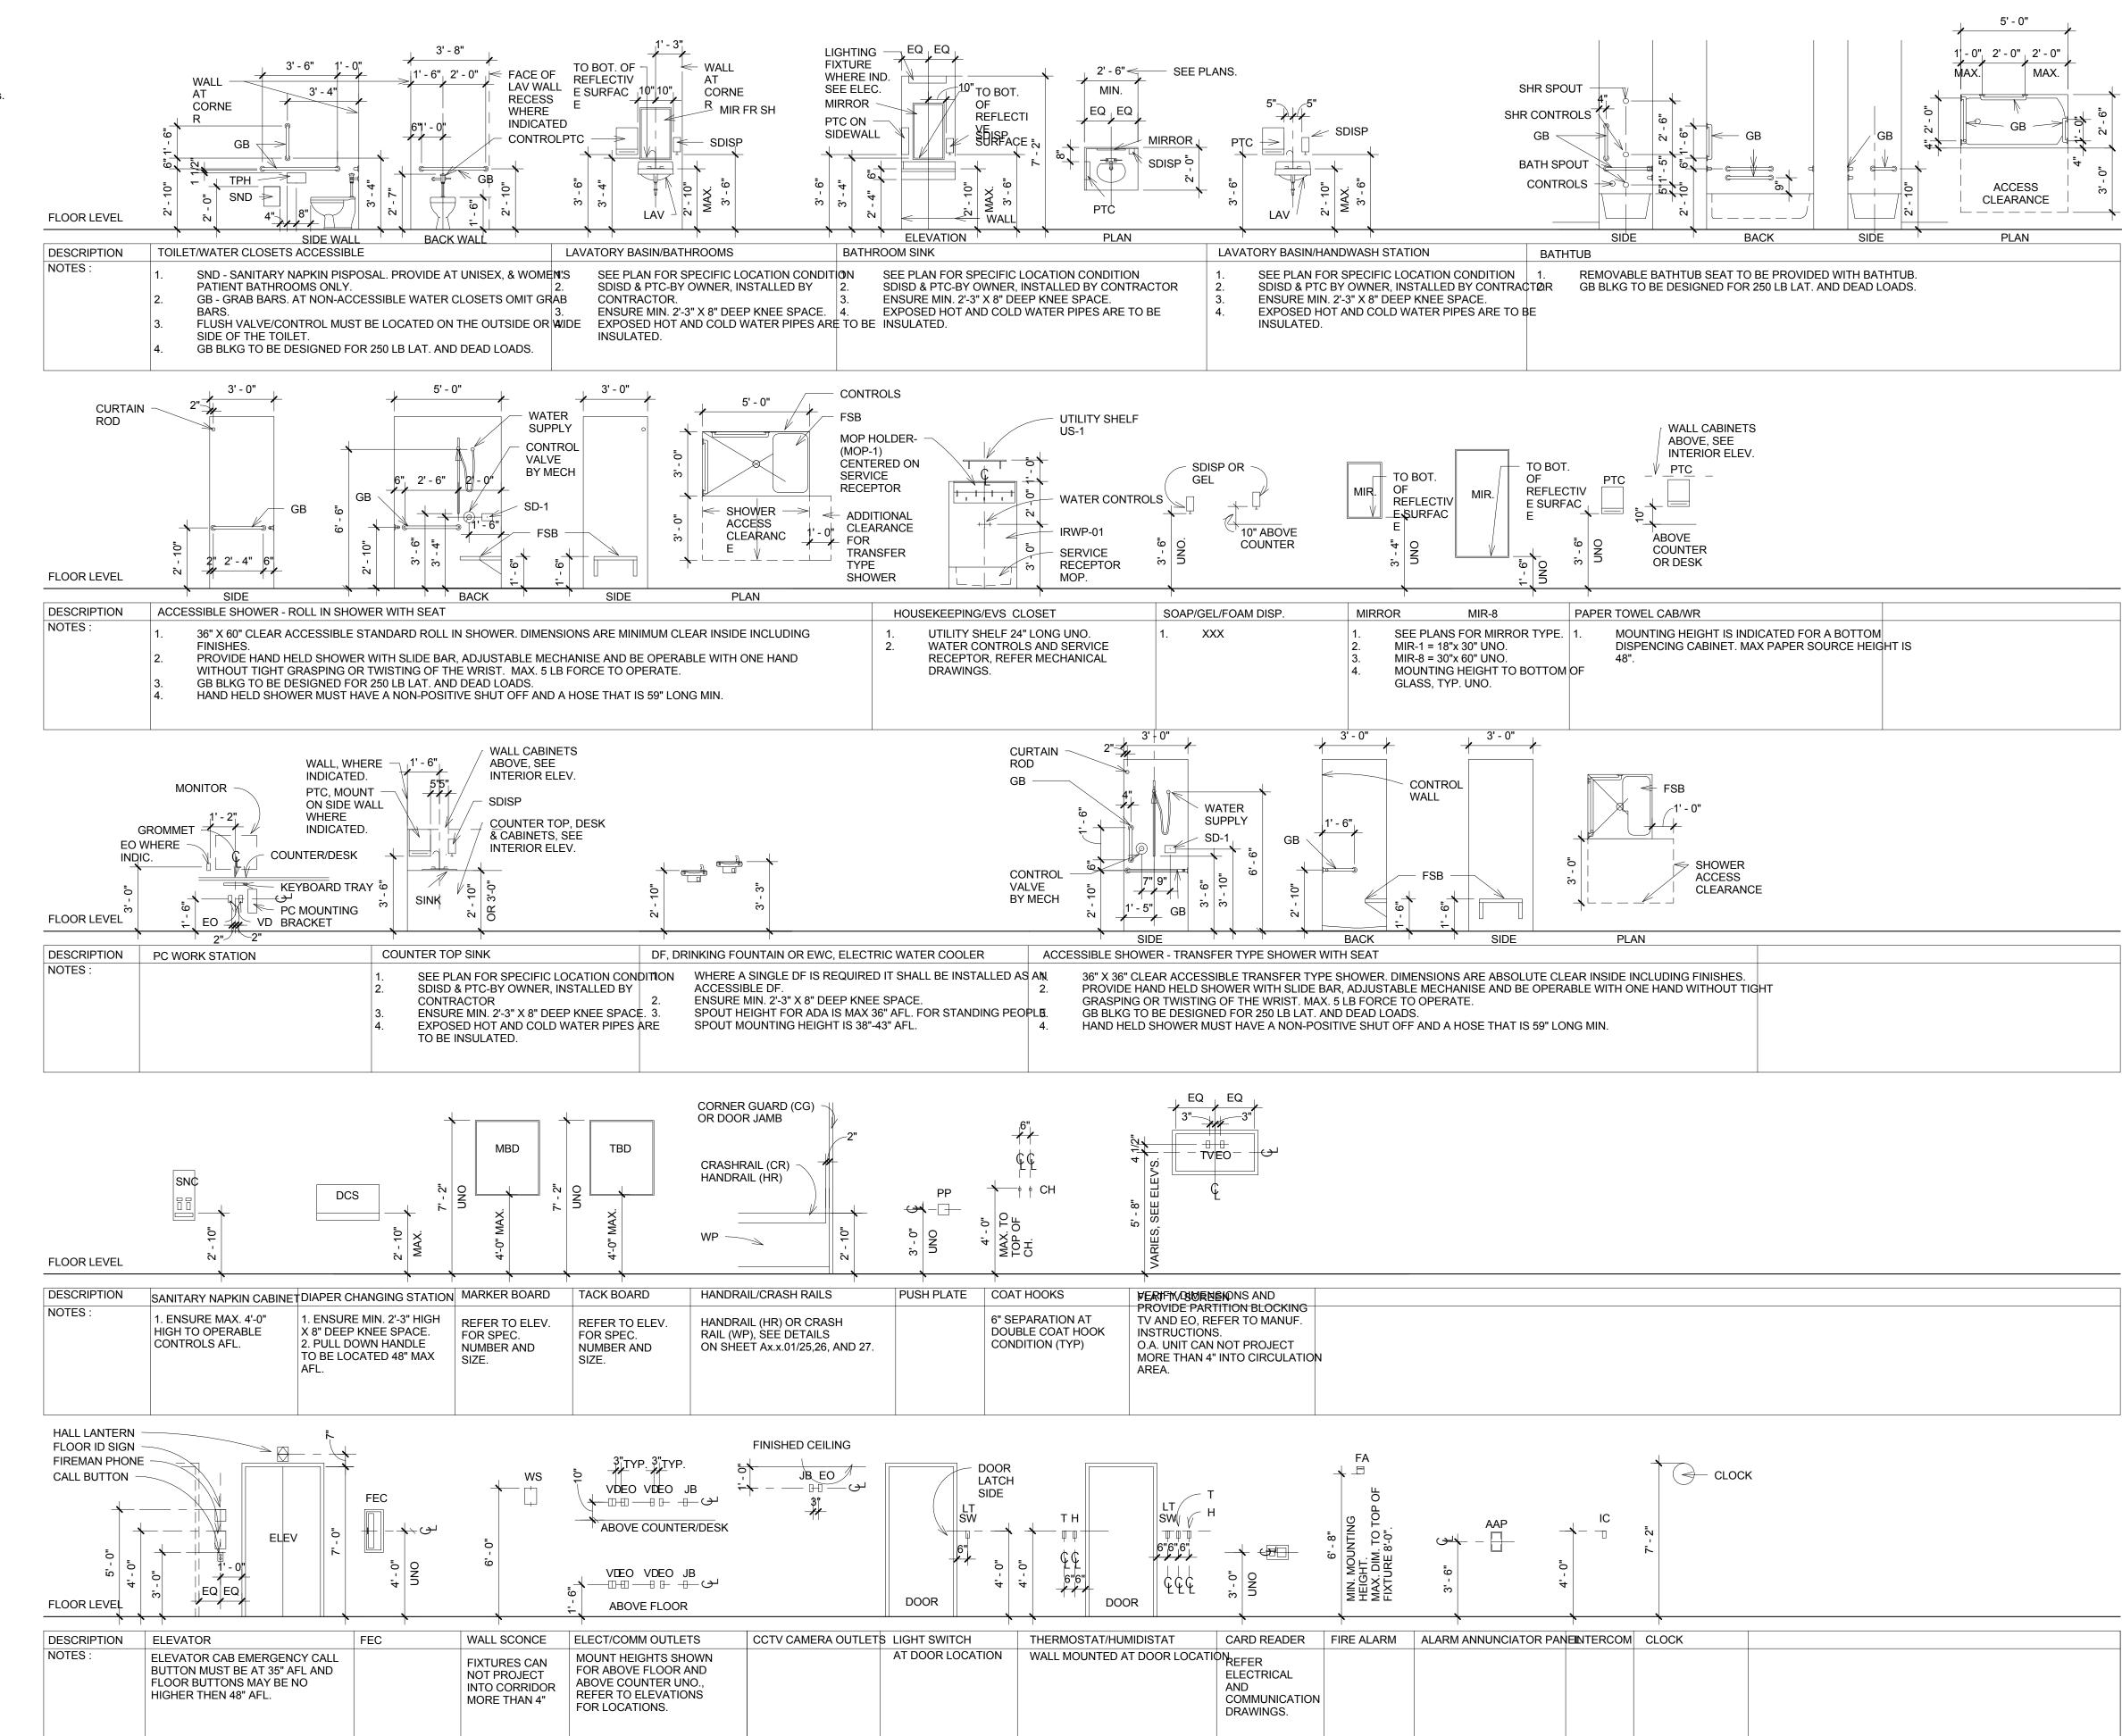

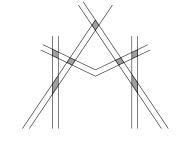

# MISHRARCHITECTURE PLL

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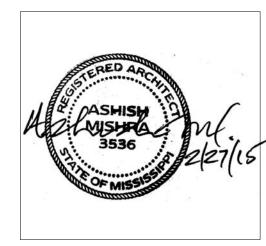
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KEY PLAN

Shiva Southaven

Holiday Inn Express & Suites

Lot 16 (Rev Lot 3) Southcrest Pkwy. Southcrest Subdivision Southaven, MS 38671

Drawing Title


Mounting Heights


Construction Documents

Project No. 14-081
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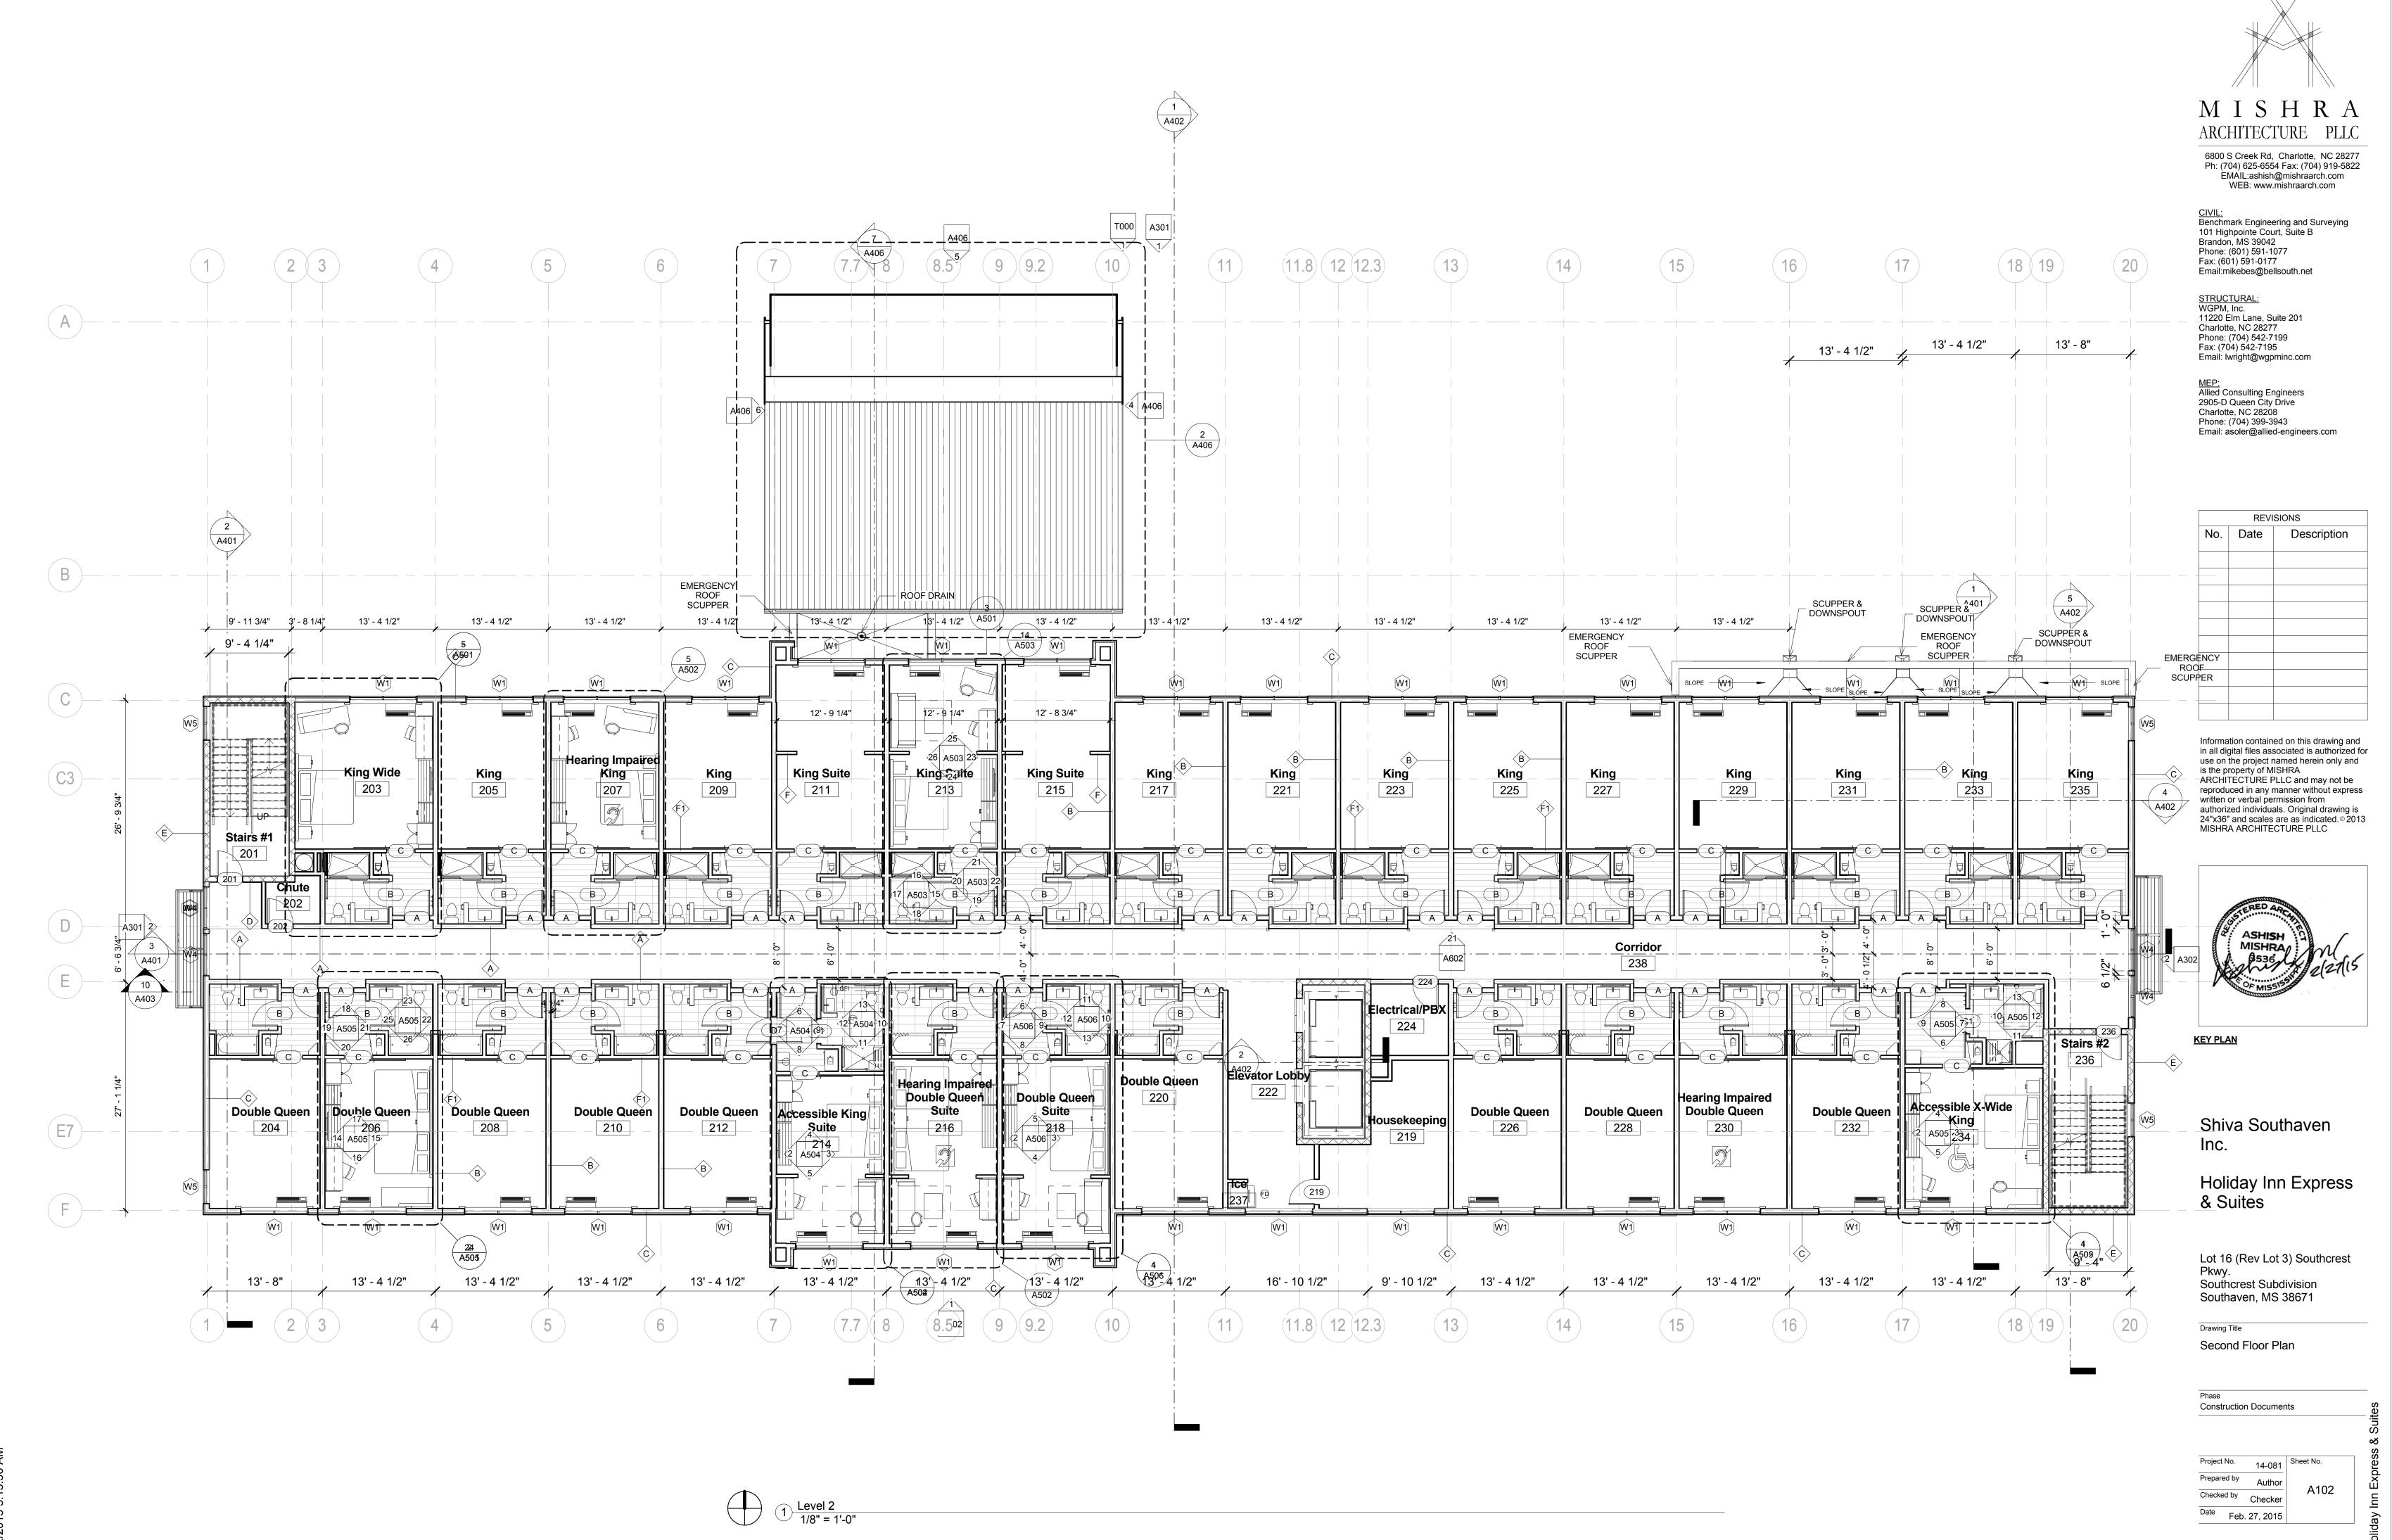
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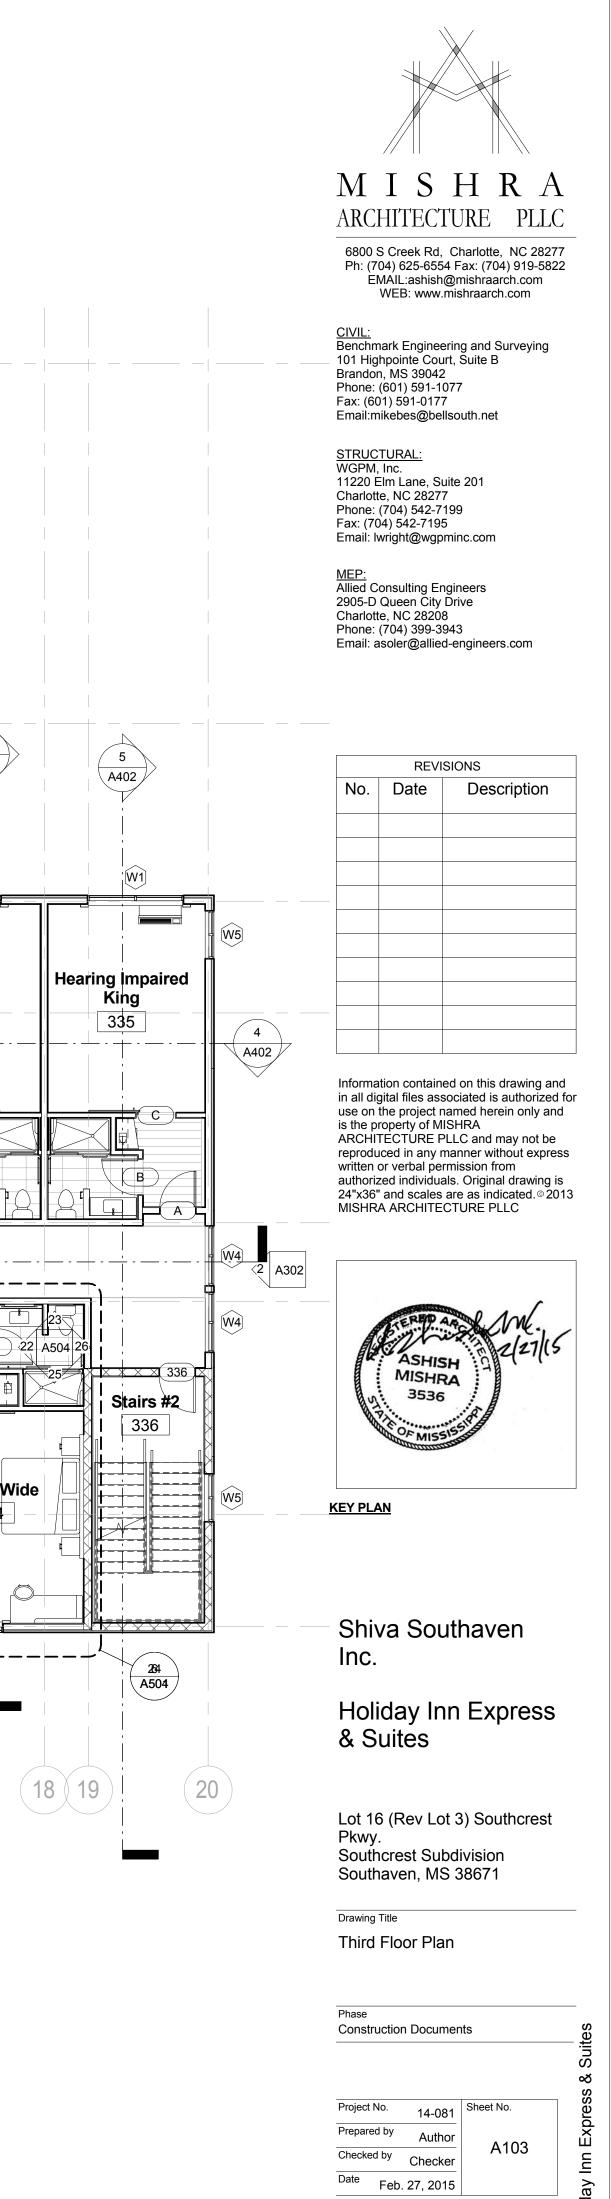





Checked by Checker Date Feb. 27, 2015

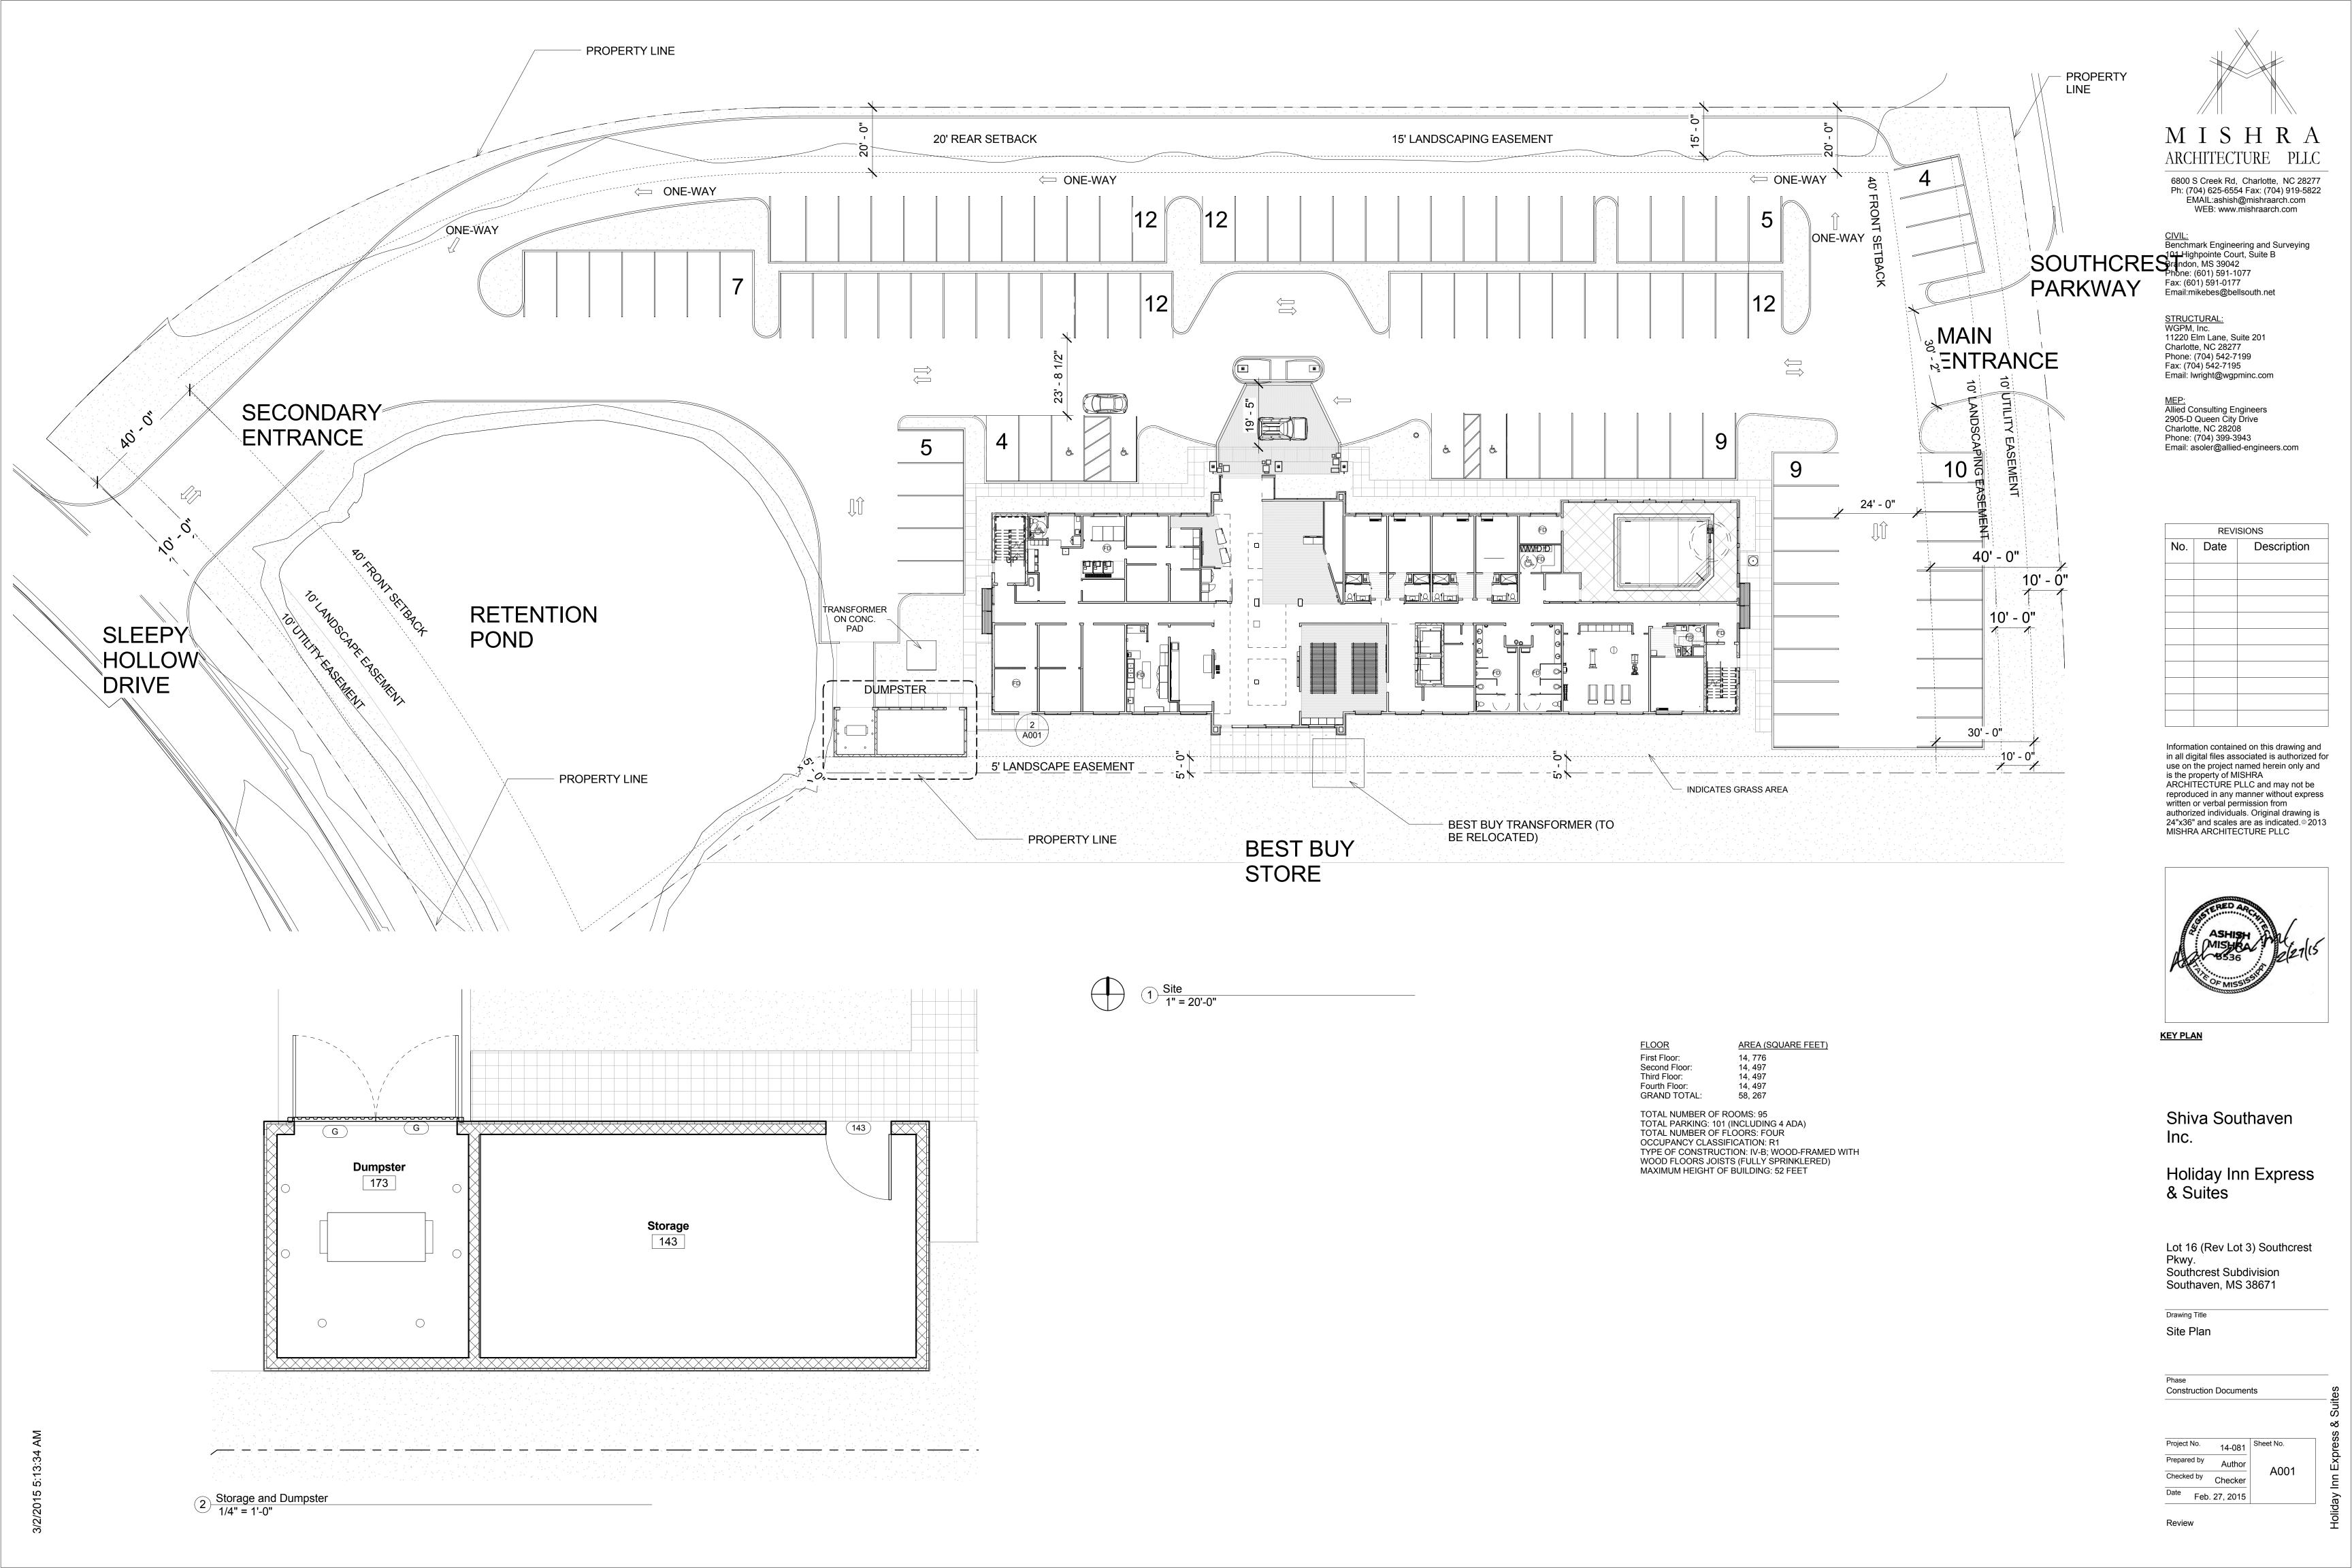
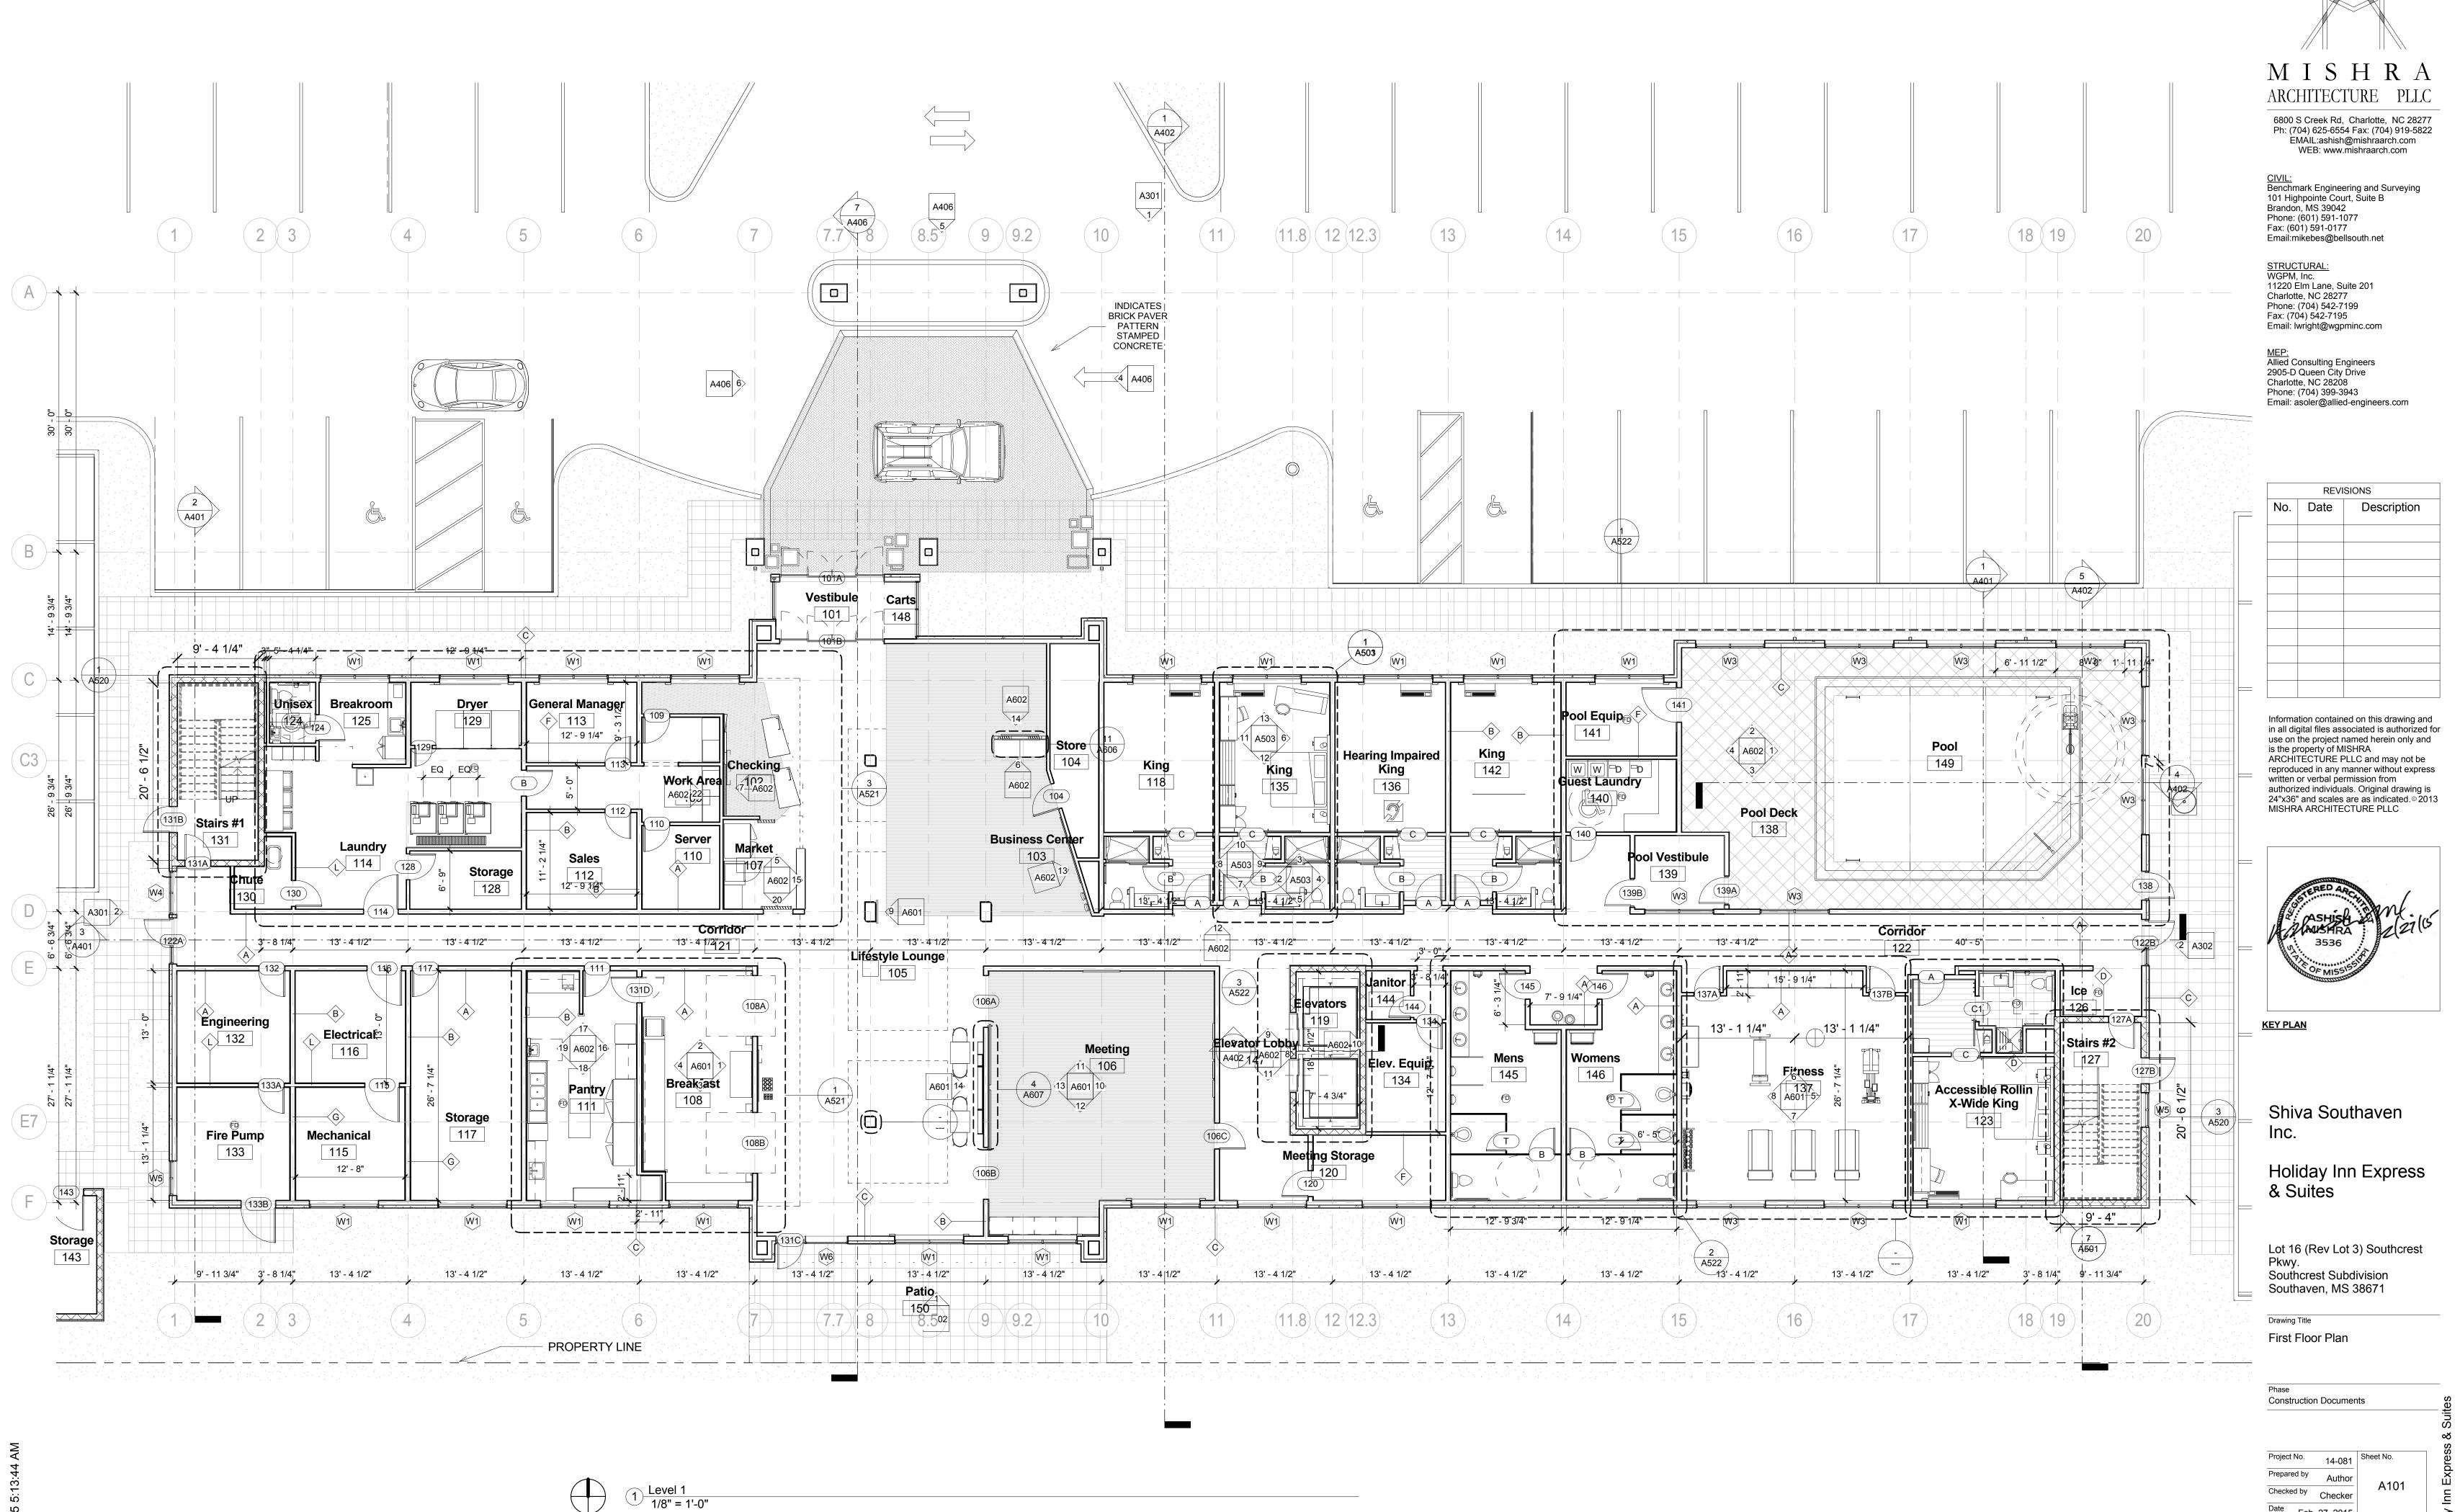
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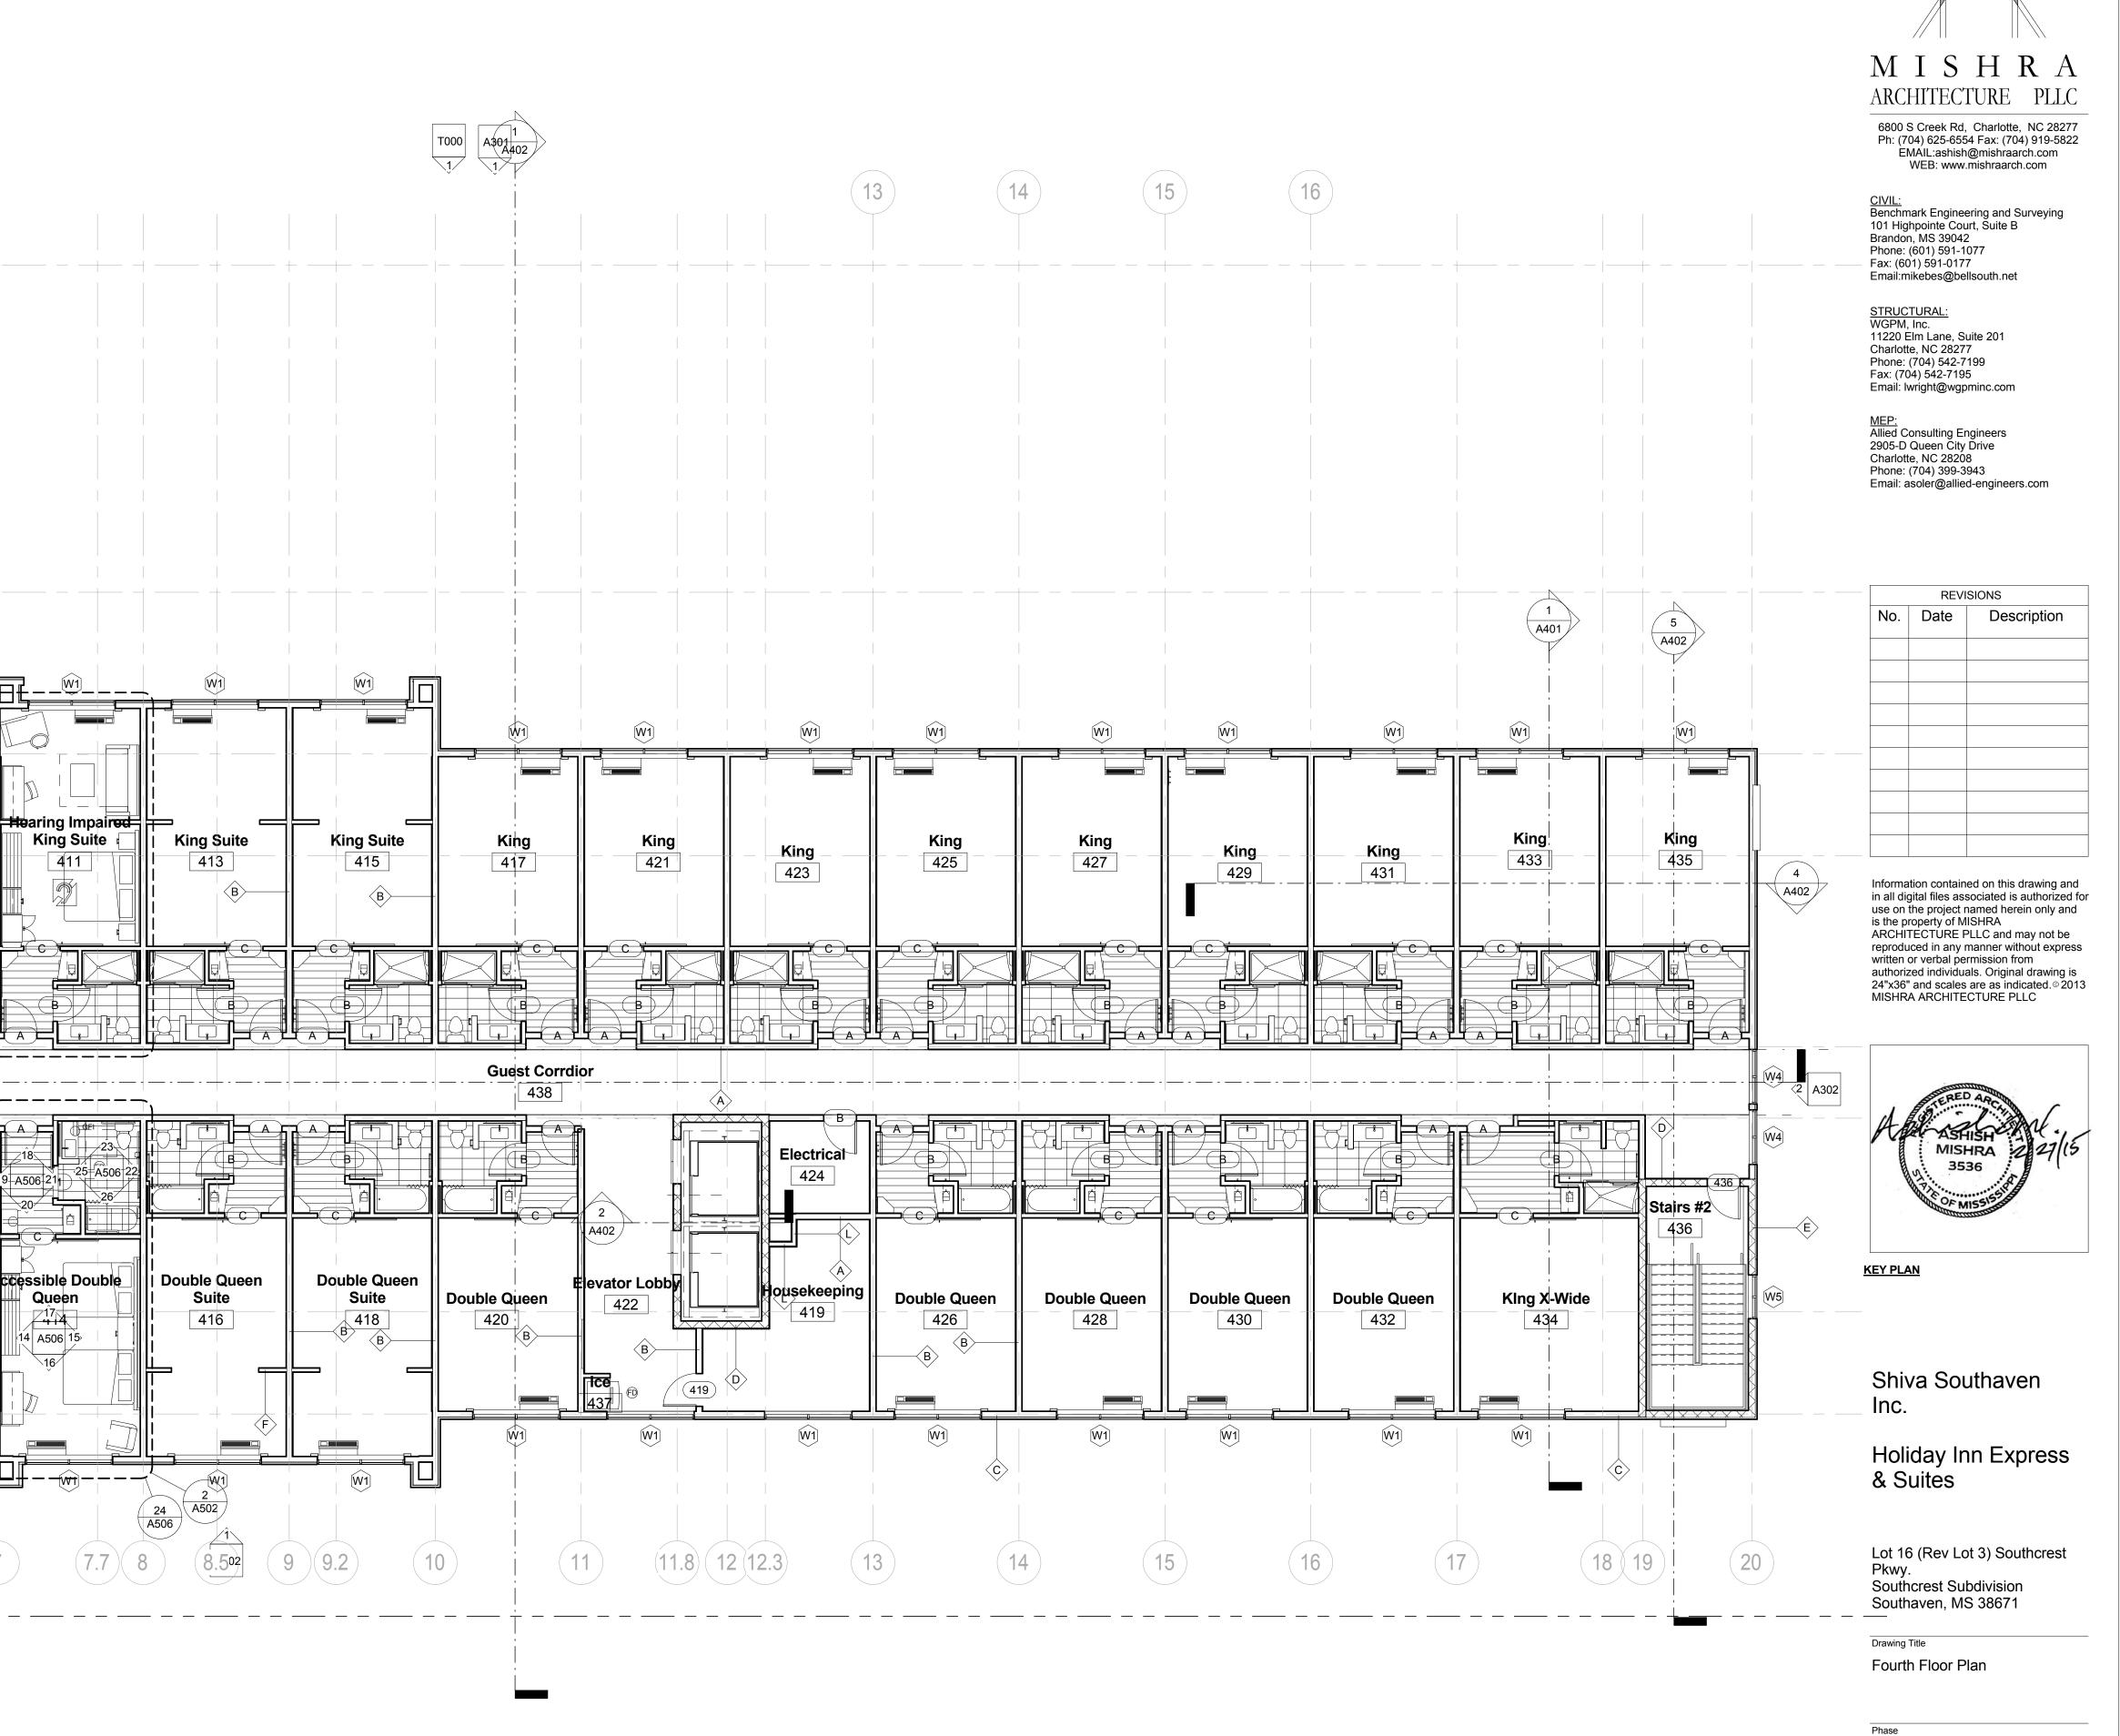
**C**3

D

E

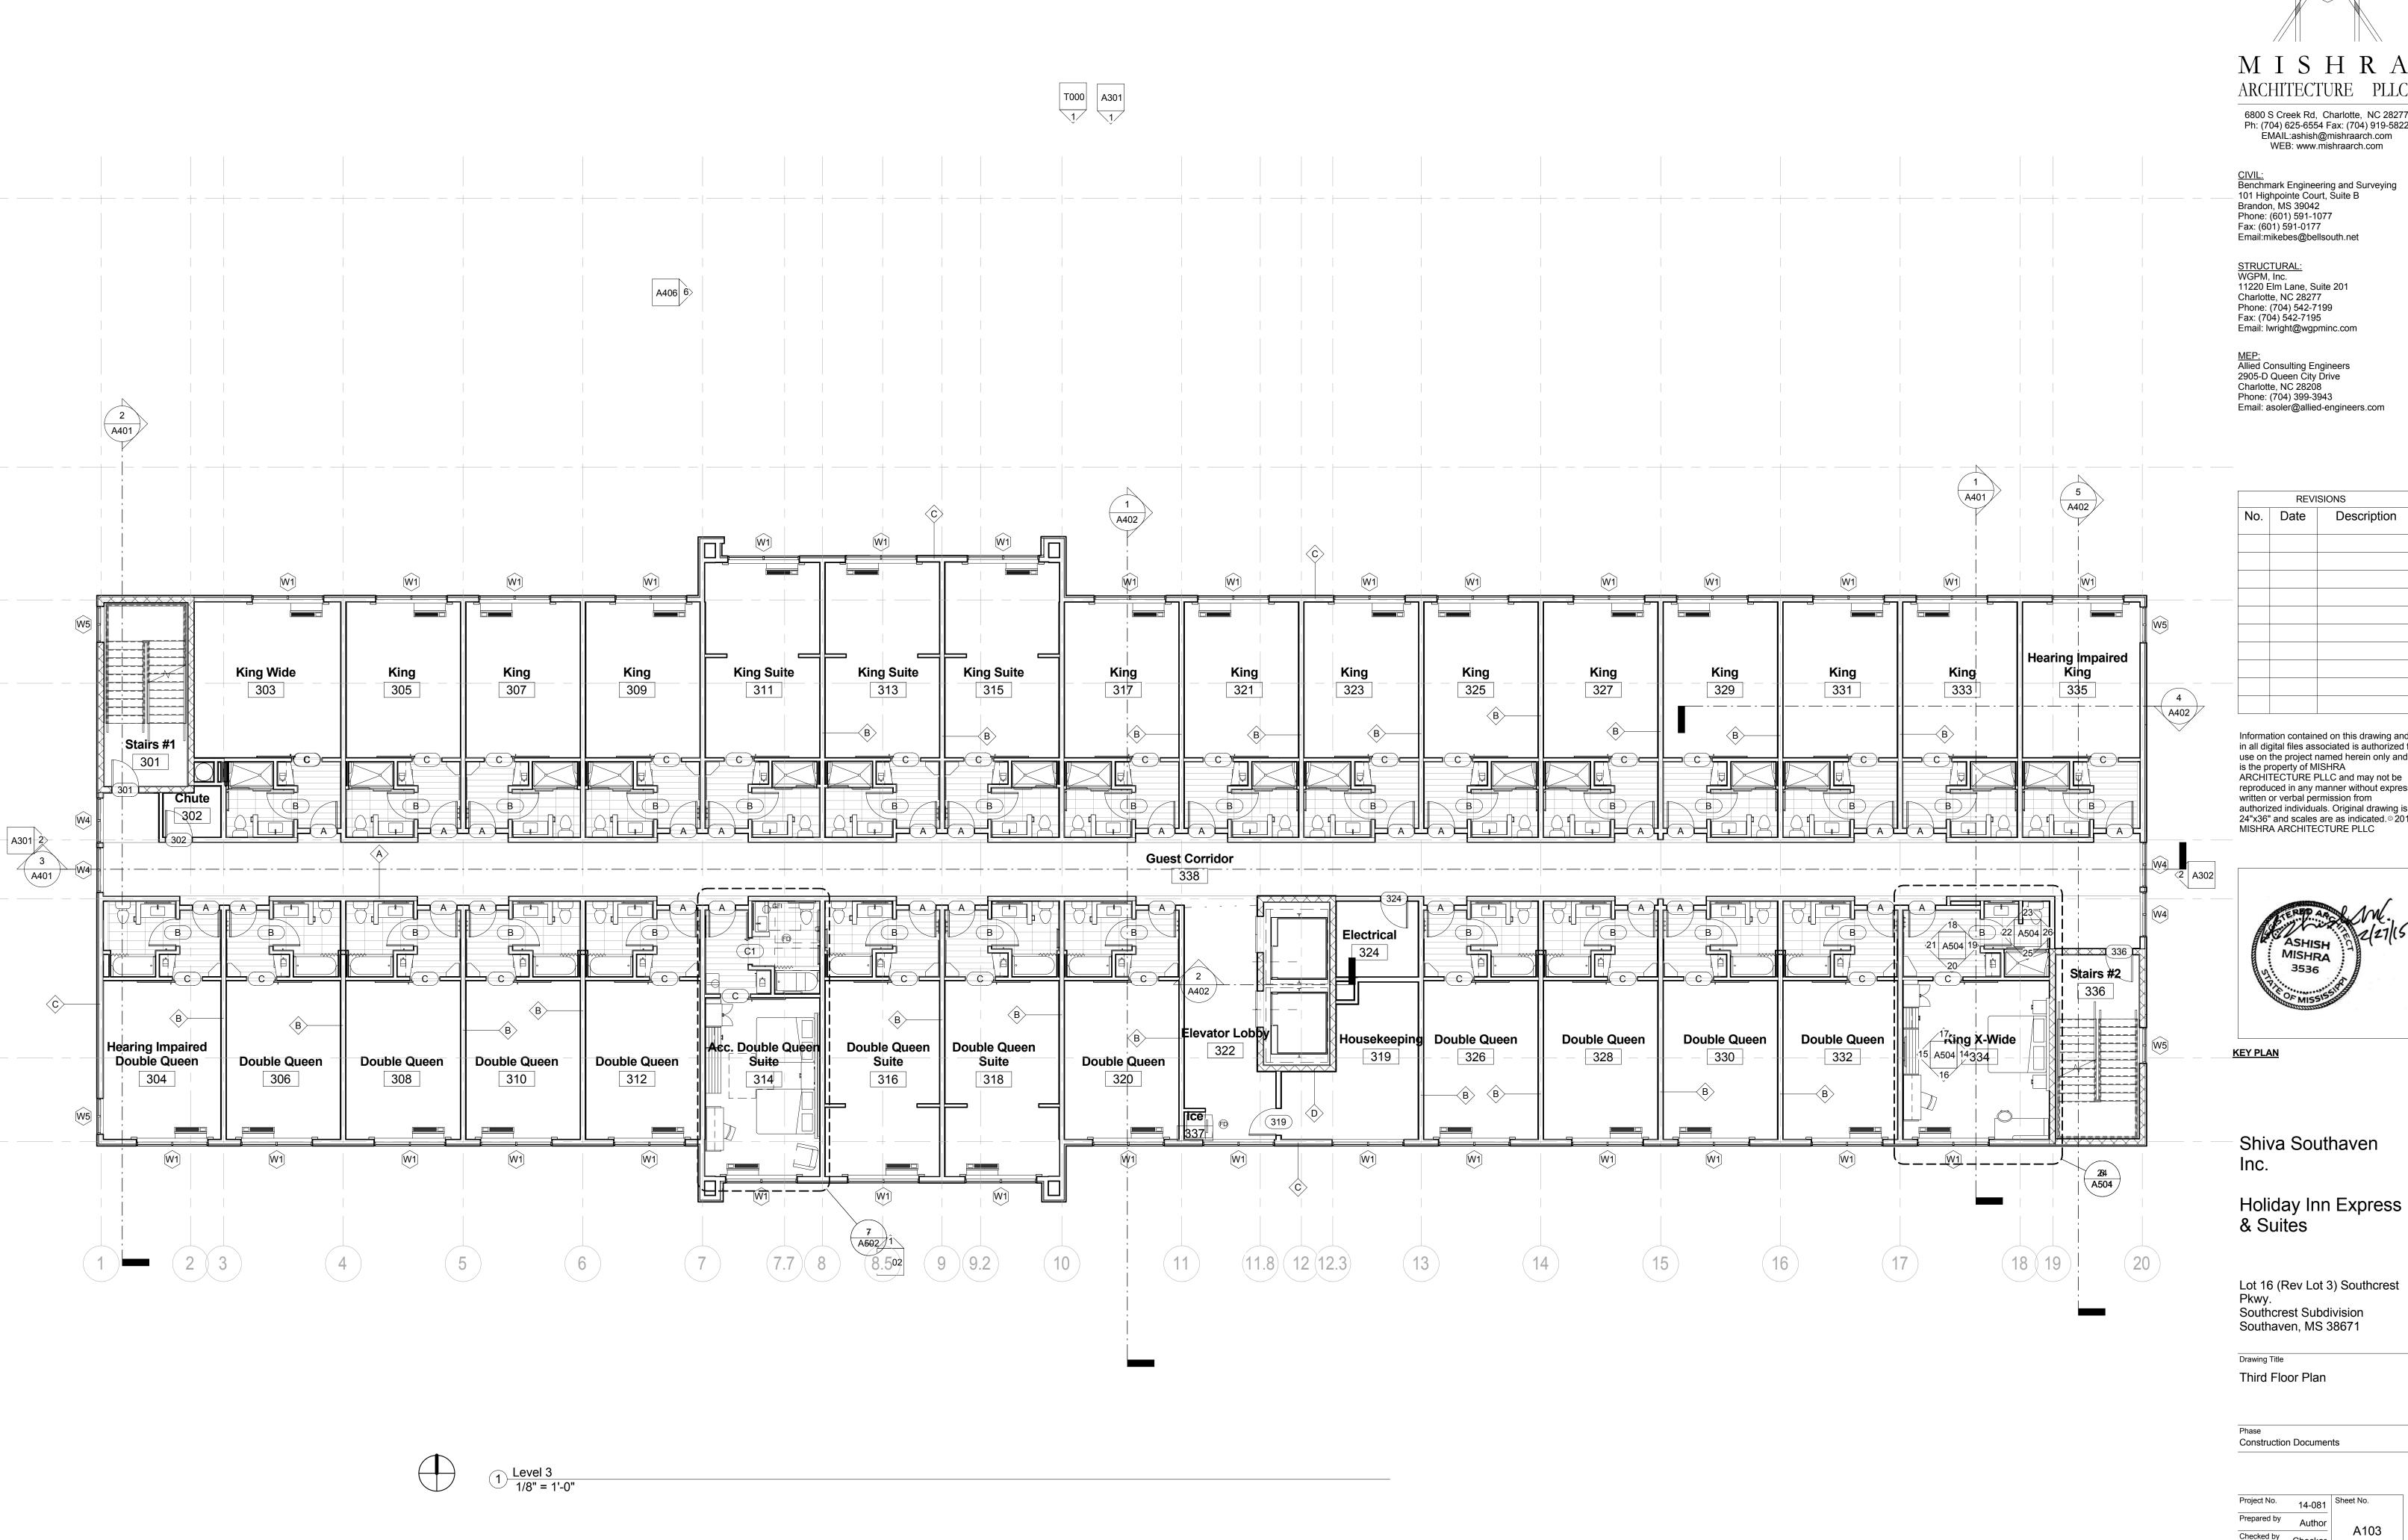**E7** 





2 A401

Stairs #1

401

Double Queen

404

W1

King Wide

403

Double Queen

406

8 A502

409

**Double Queen** 

412

King Suite

Accessible Double

Queen

14 A506 15

Hearing Impaired

407

Hearing Impaired

Double Queen

405

Double Queen

408

Construction Documents


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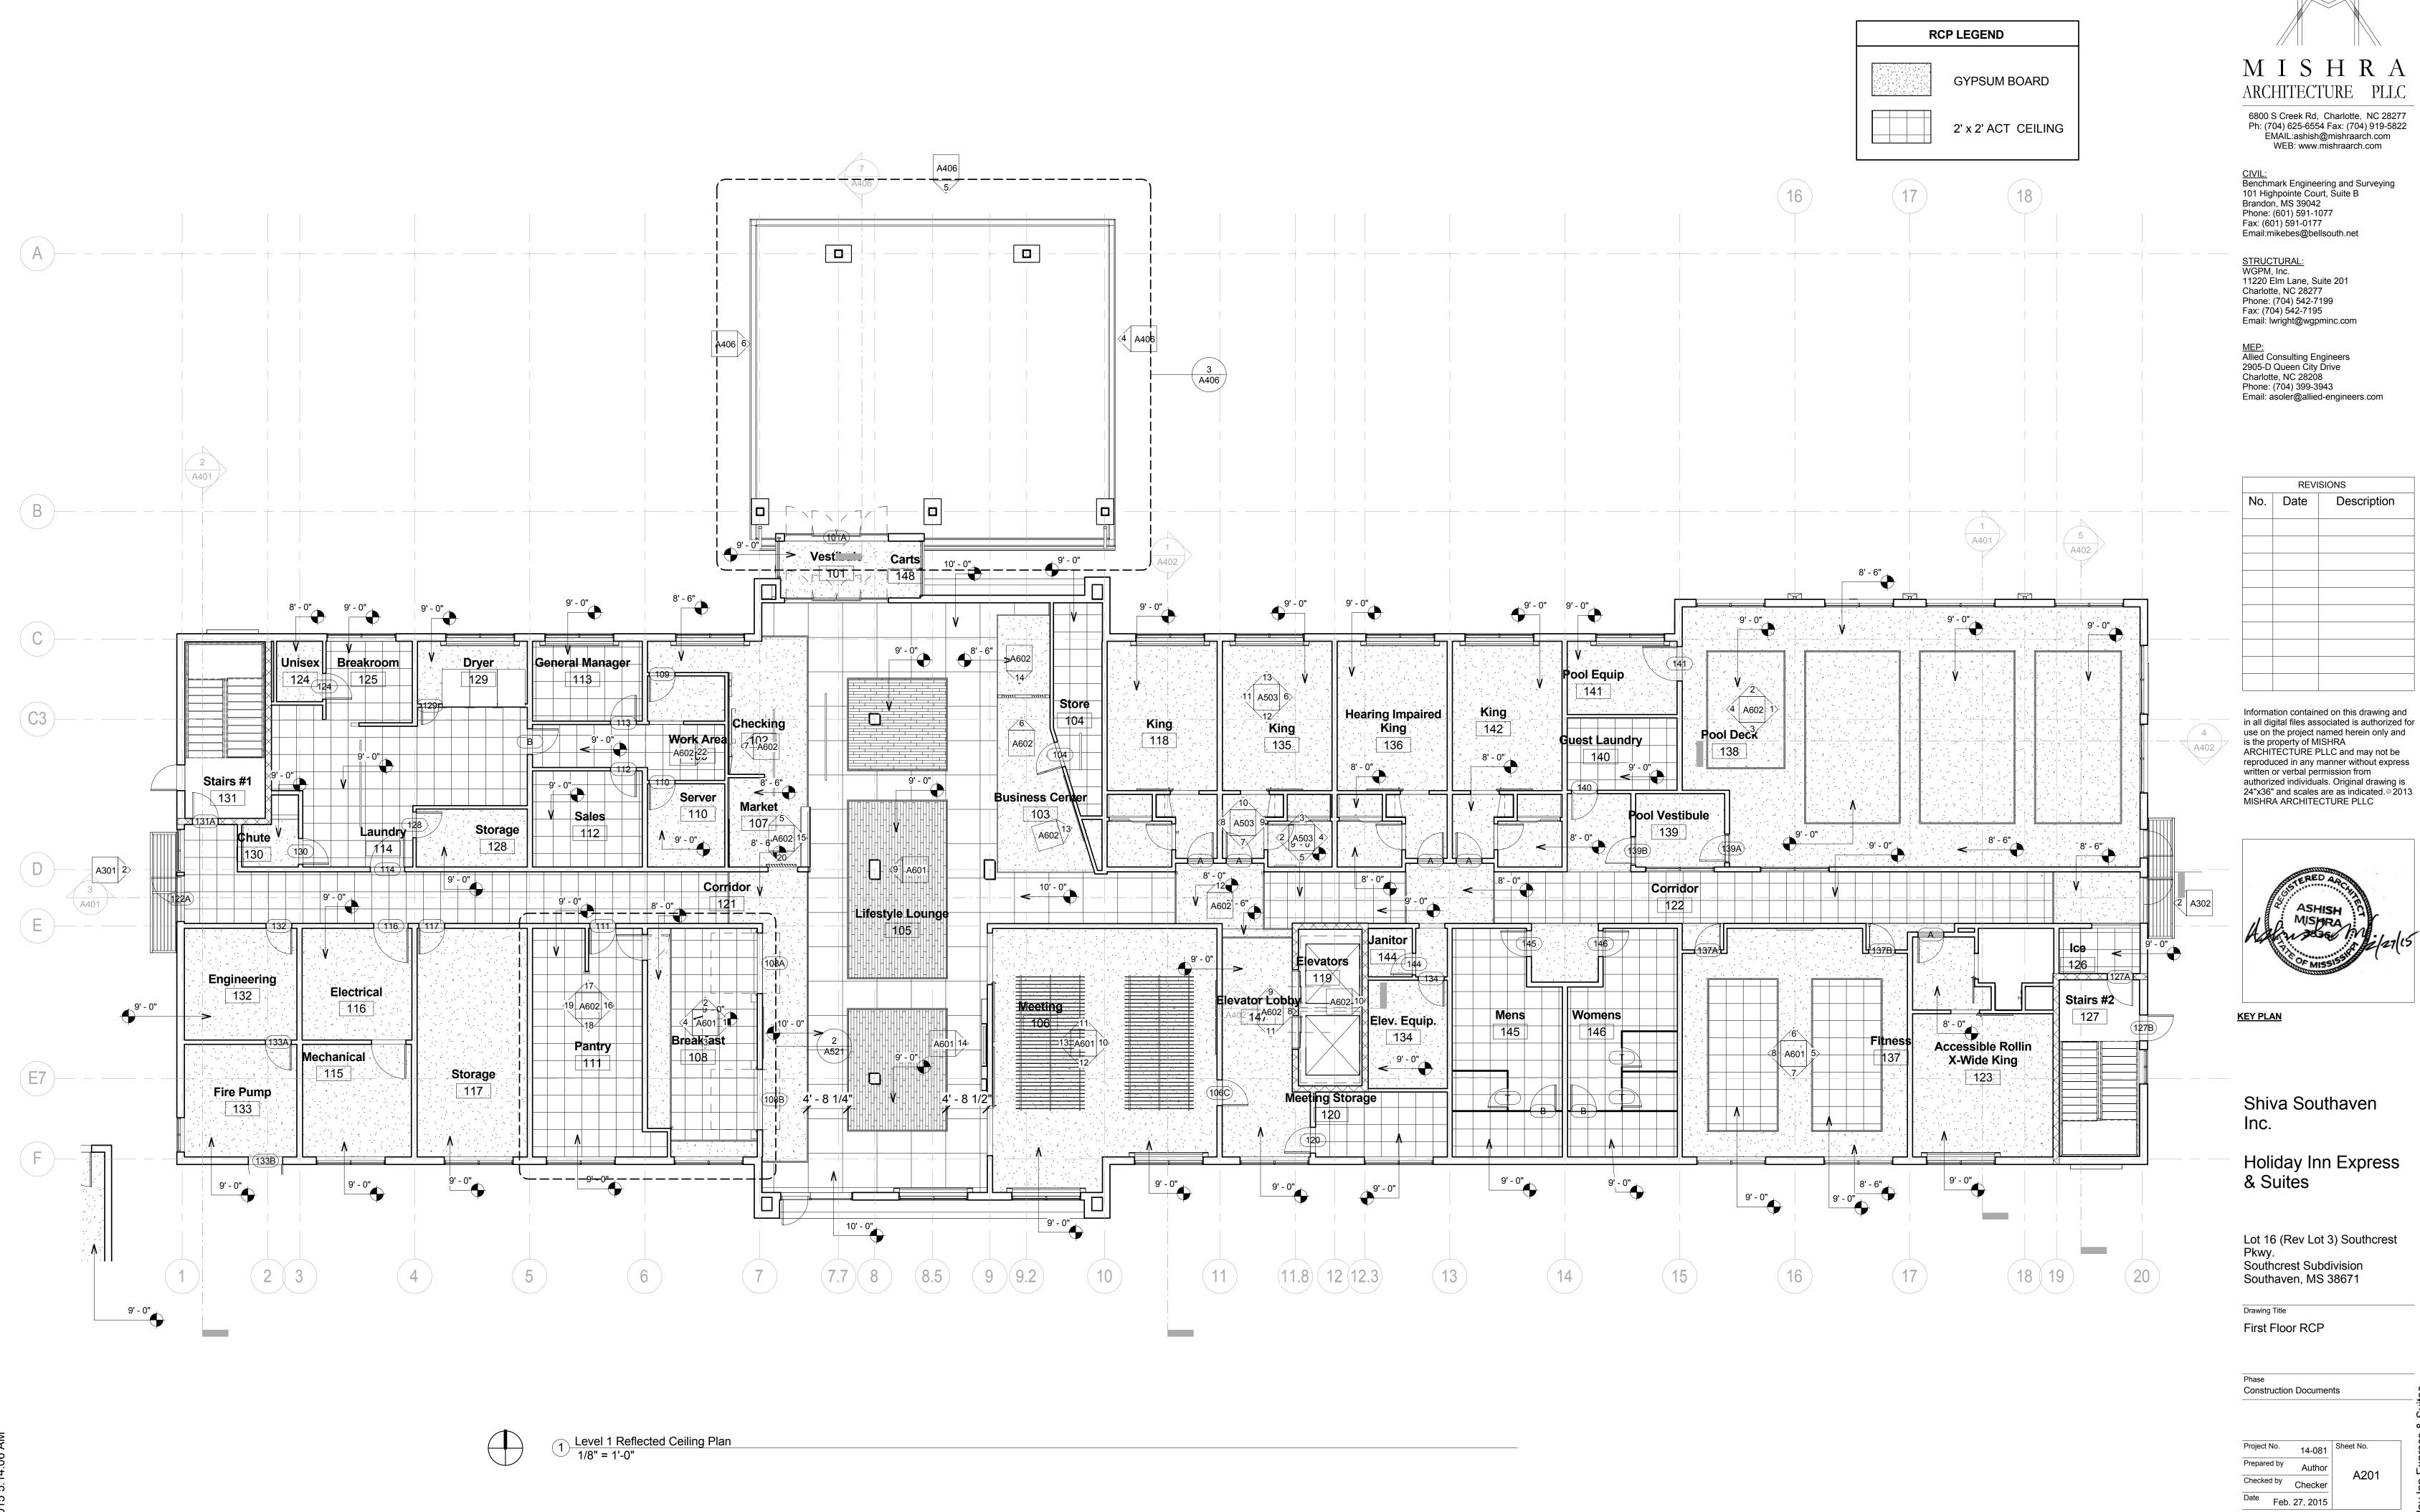
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**E7** 


A301 2>


3 A401



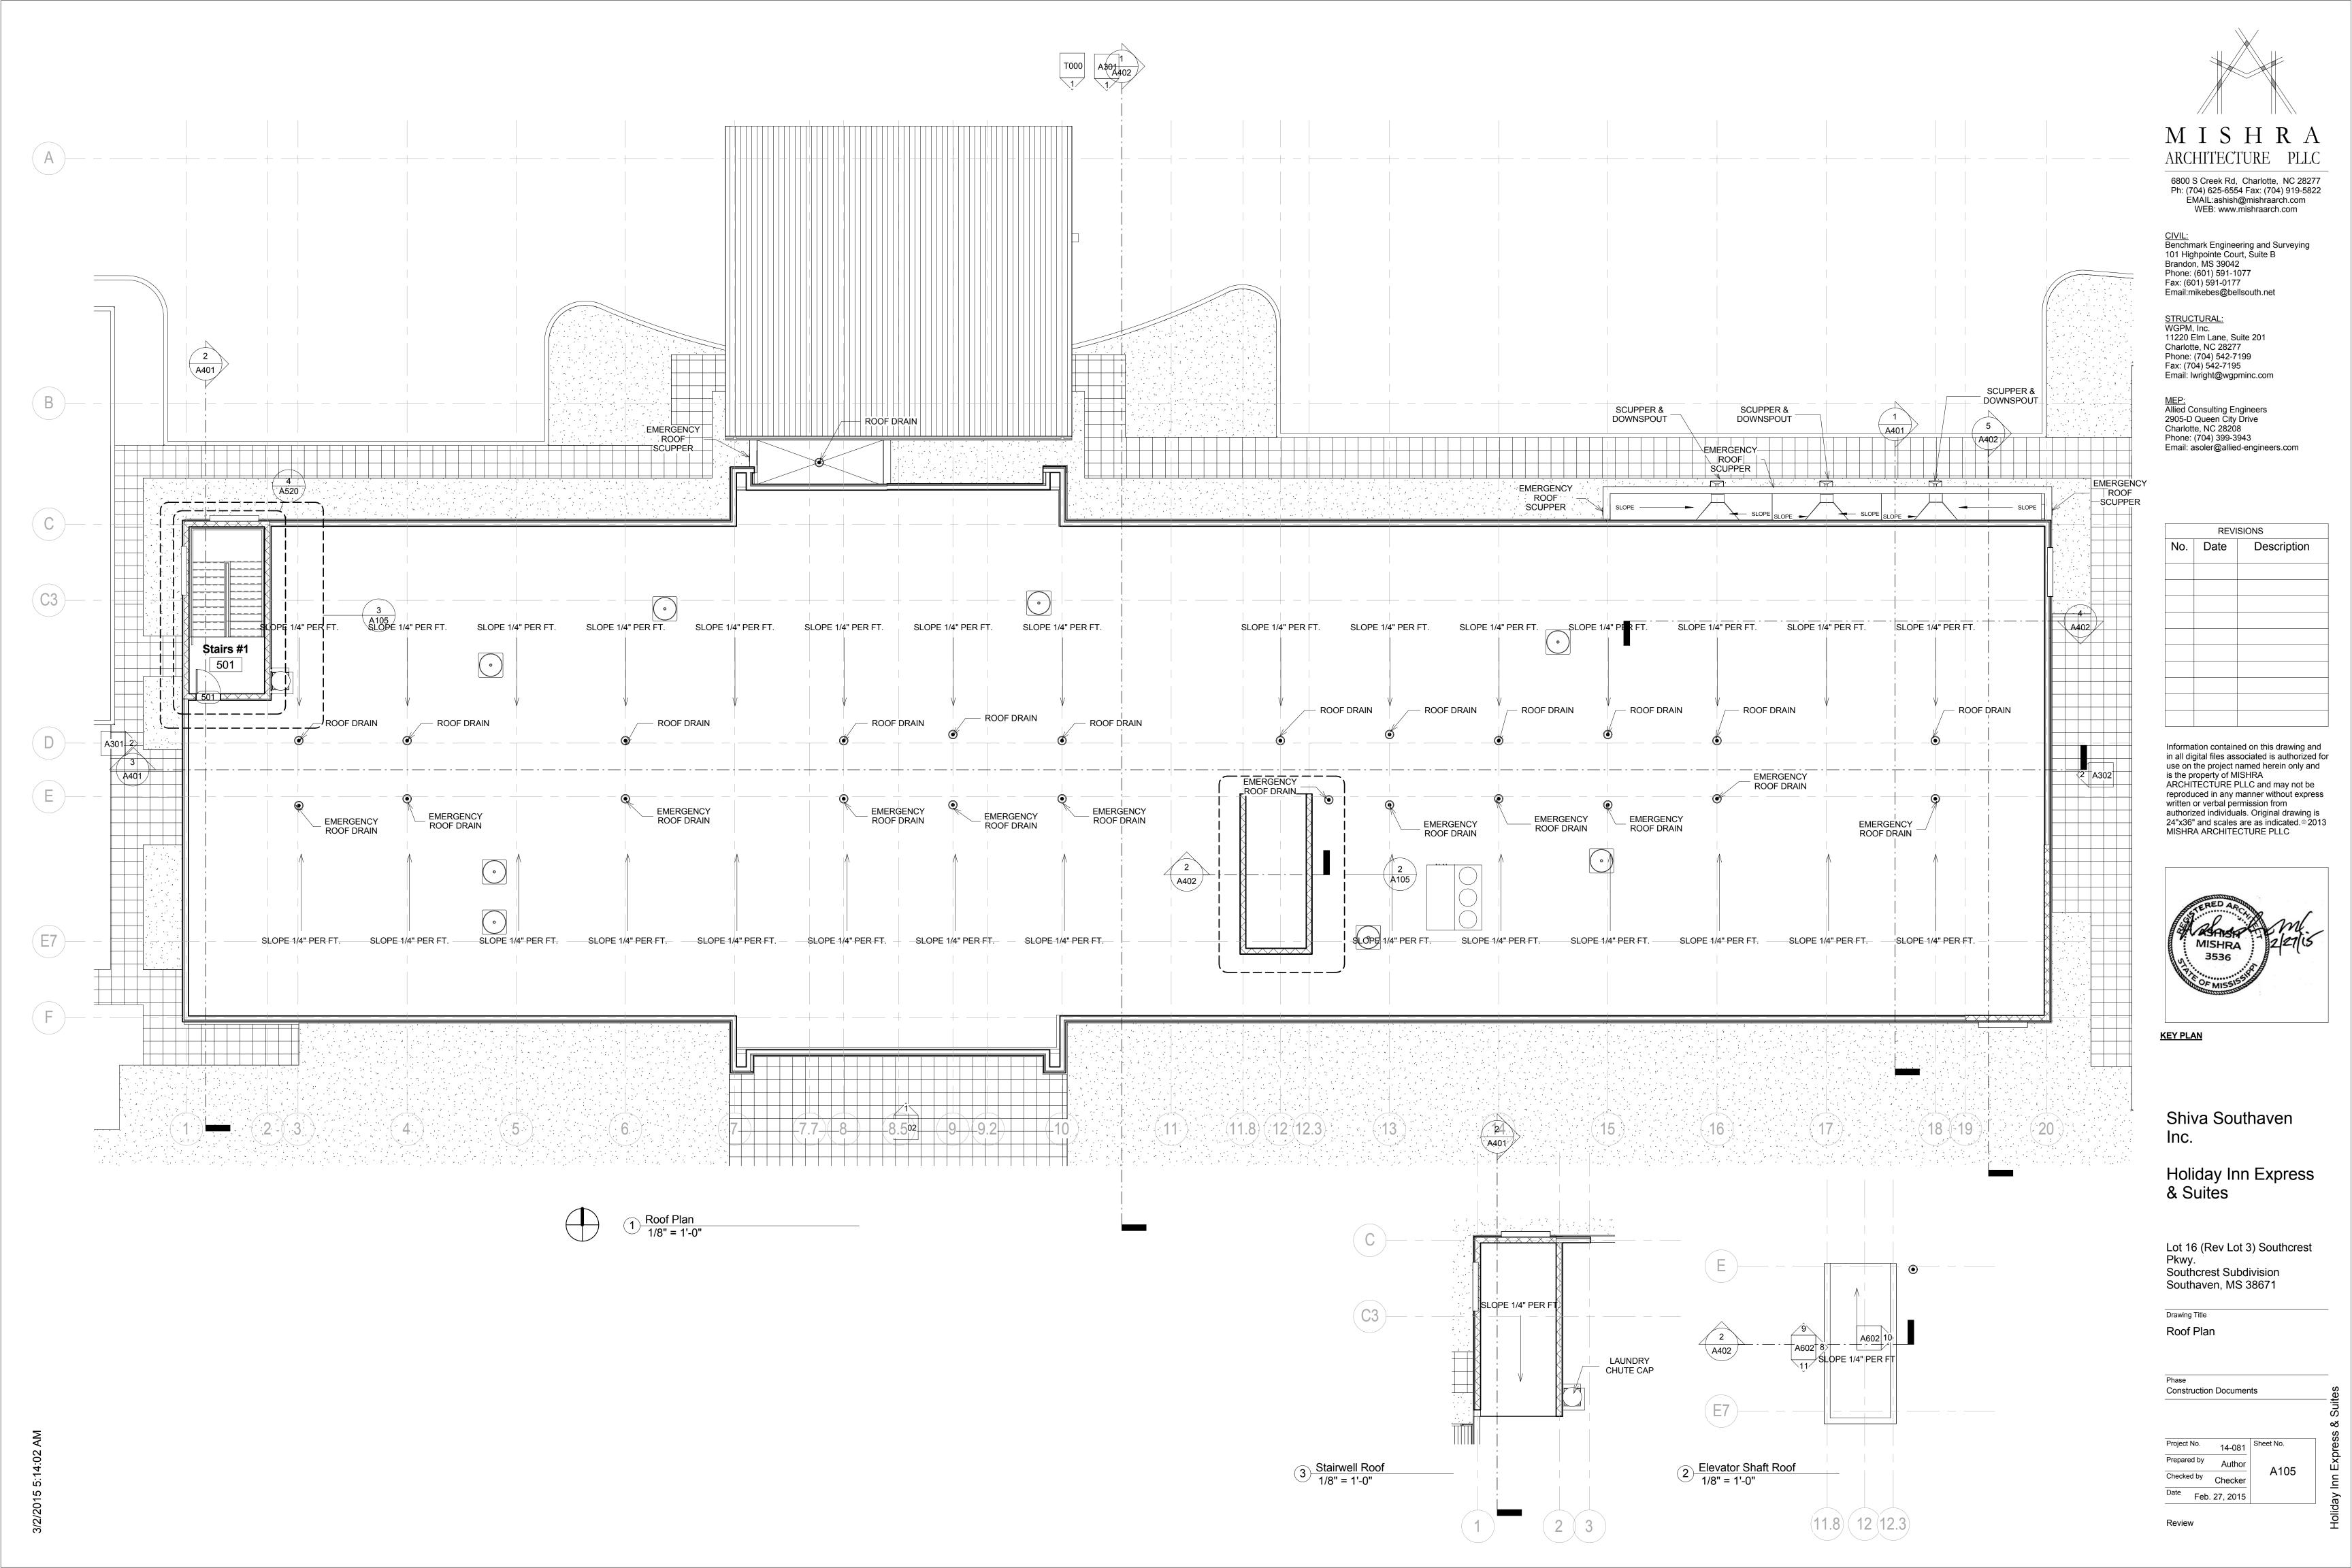


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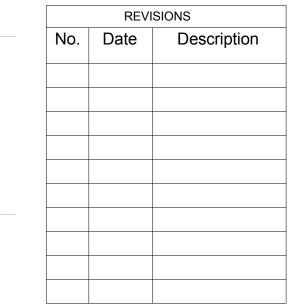

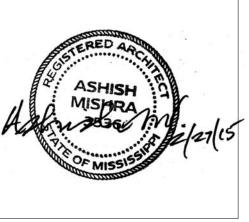
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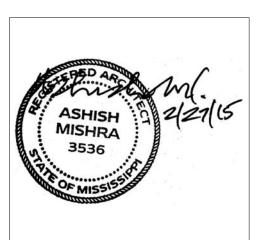
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KEY PLAN

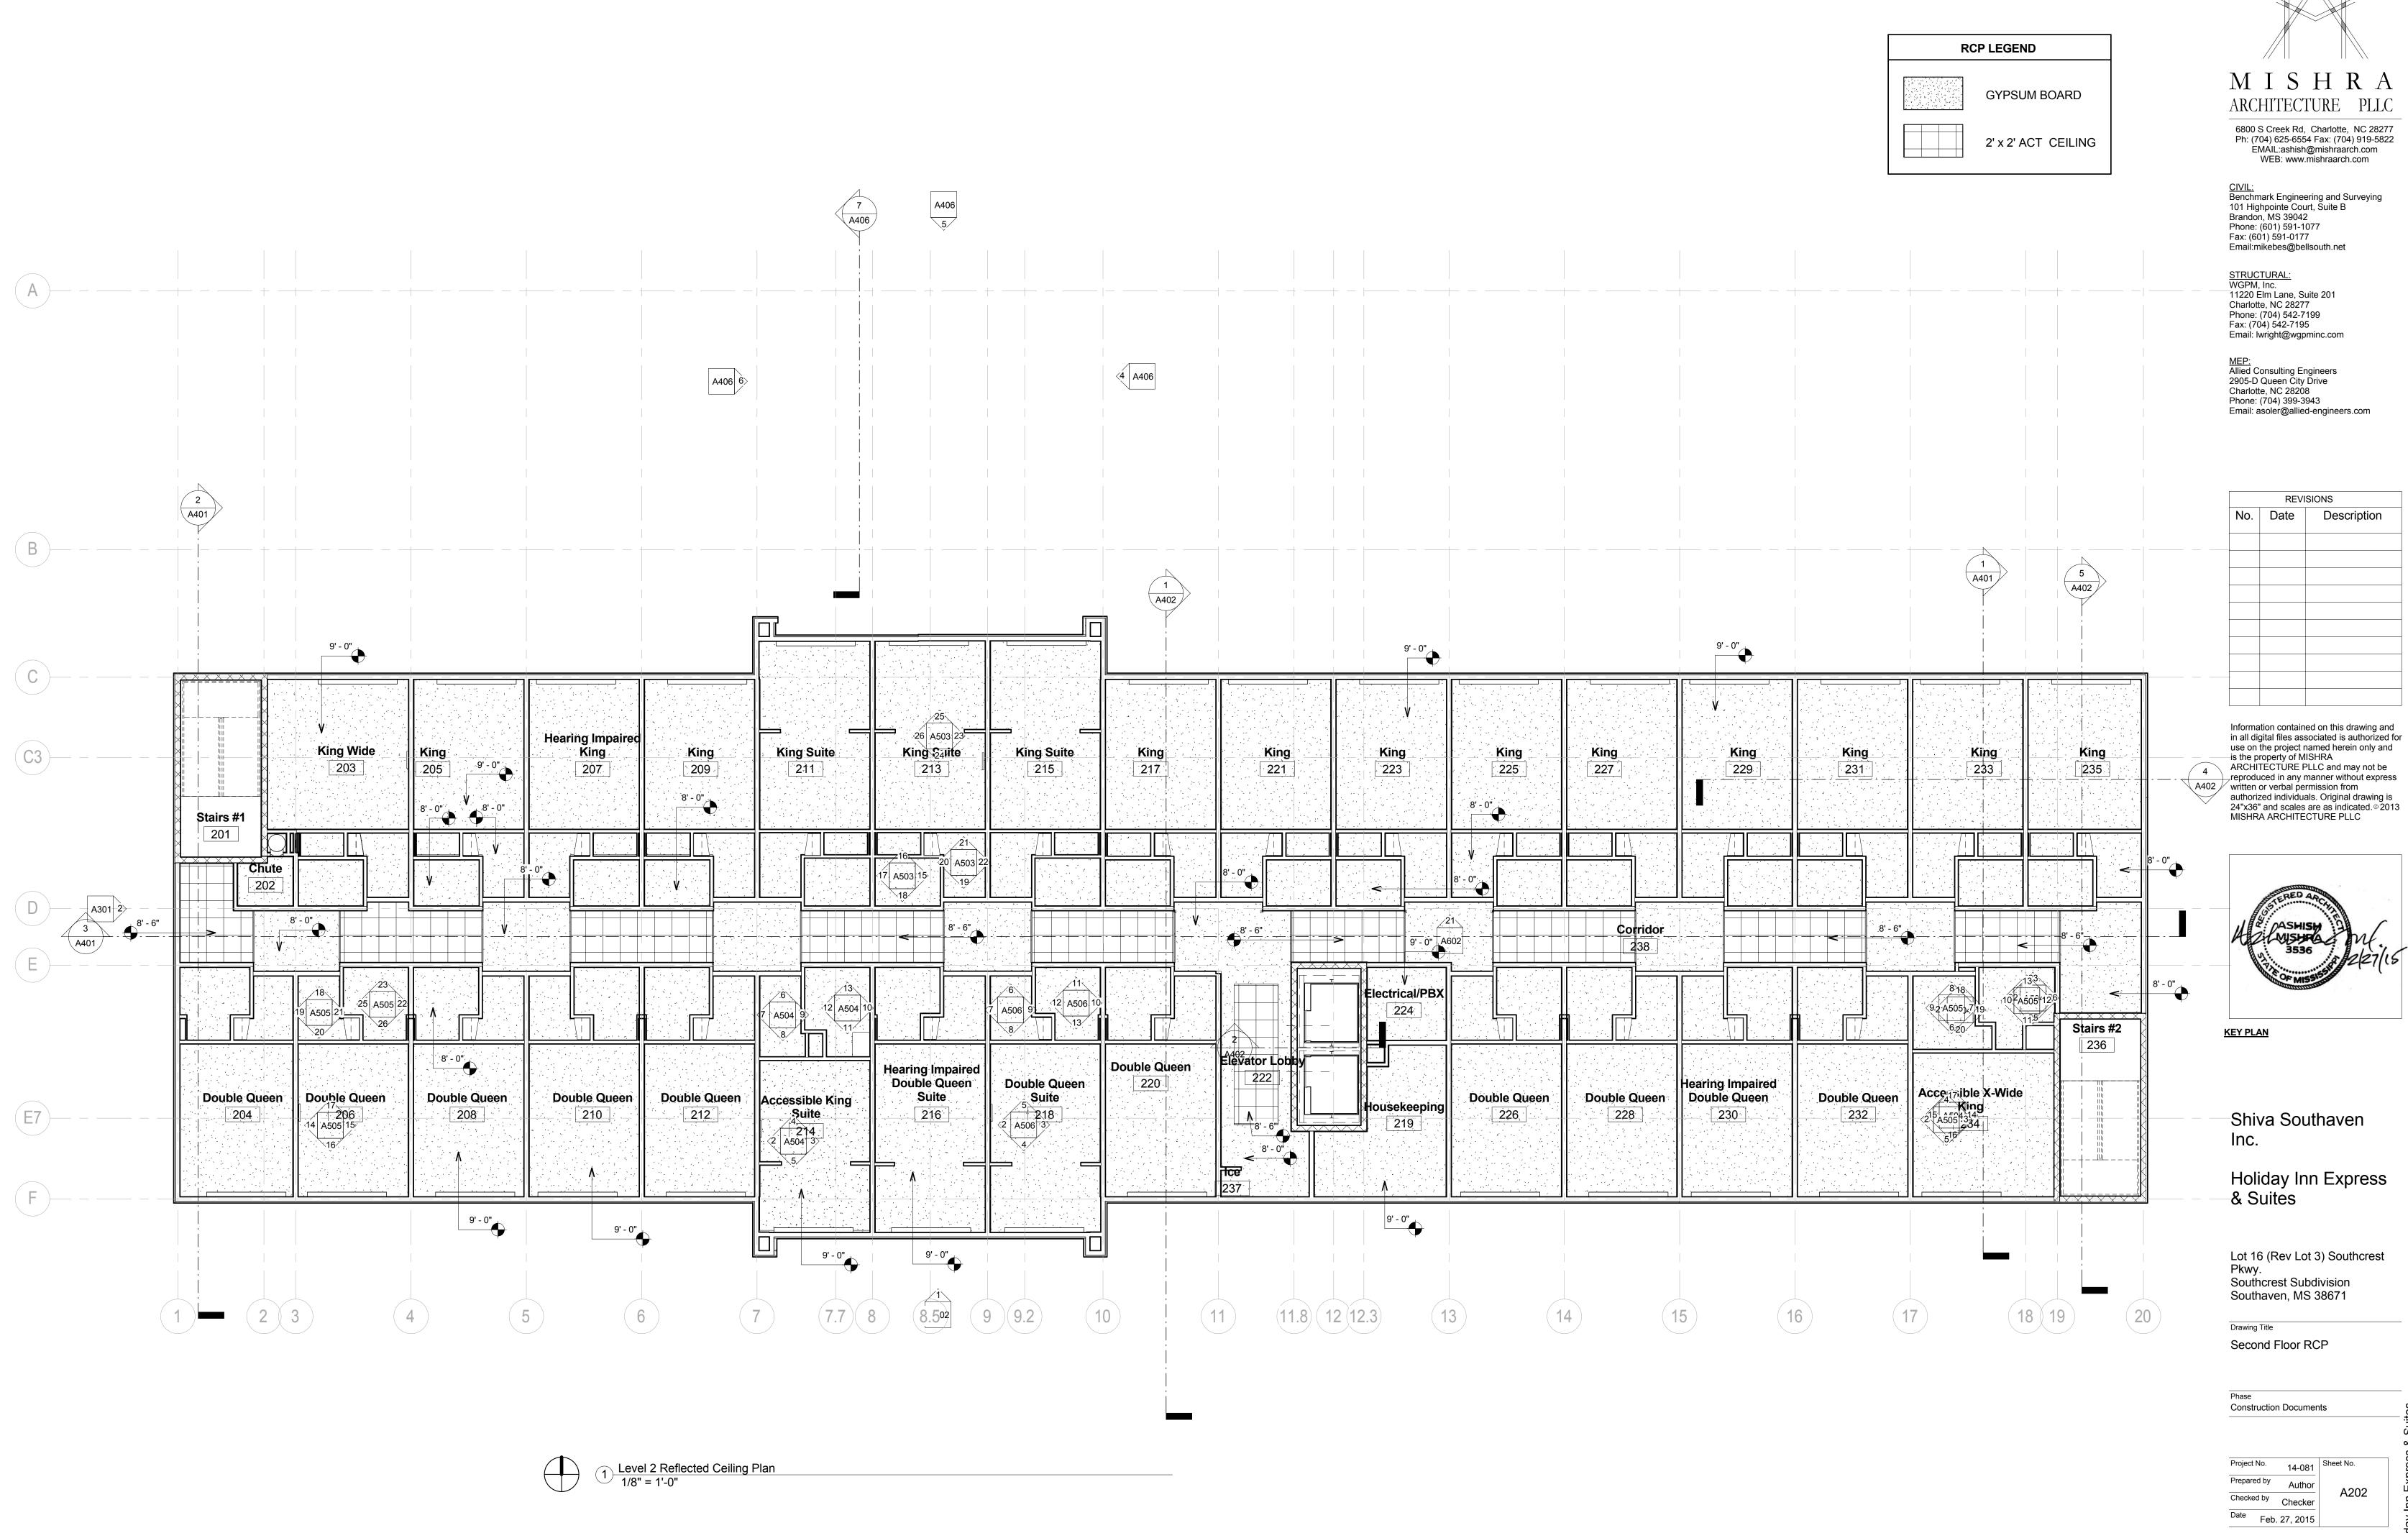Shiva Southaven

Holiday Inn Express & Suites

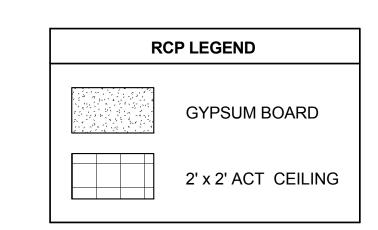Lot 16 (Rev Lot 3) Southcrest Pkwy. Southcrest Subdivision Southaven, MS 38671

Drawing Title
Third Floor RCP


Phase Construction Documents

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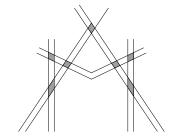
A203

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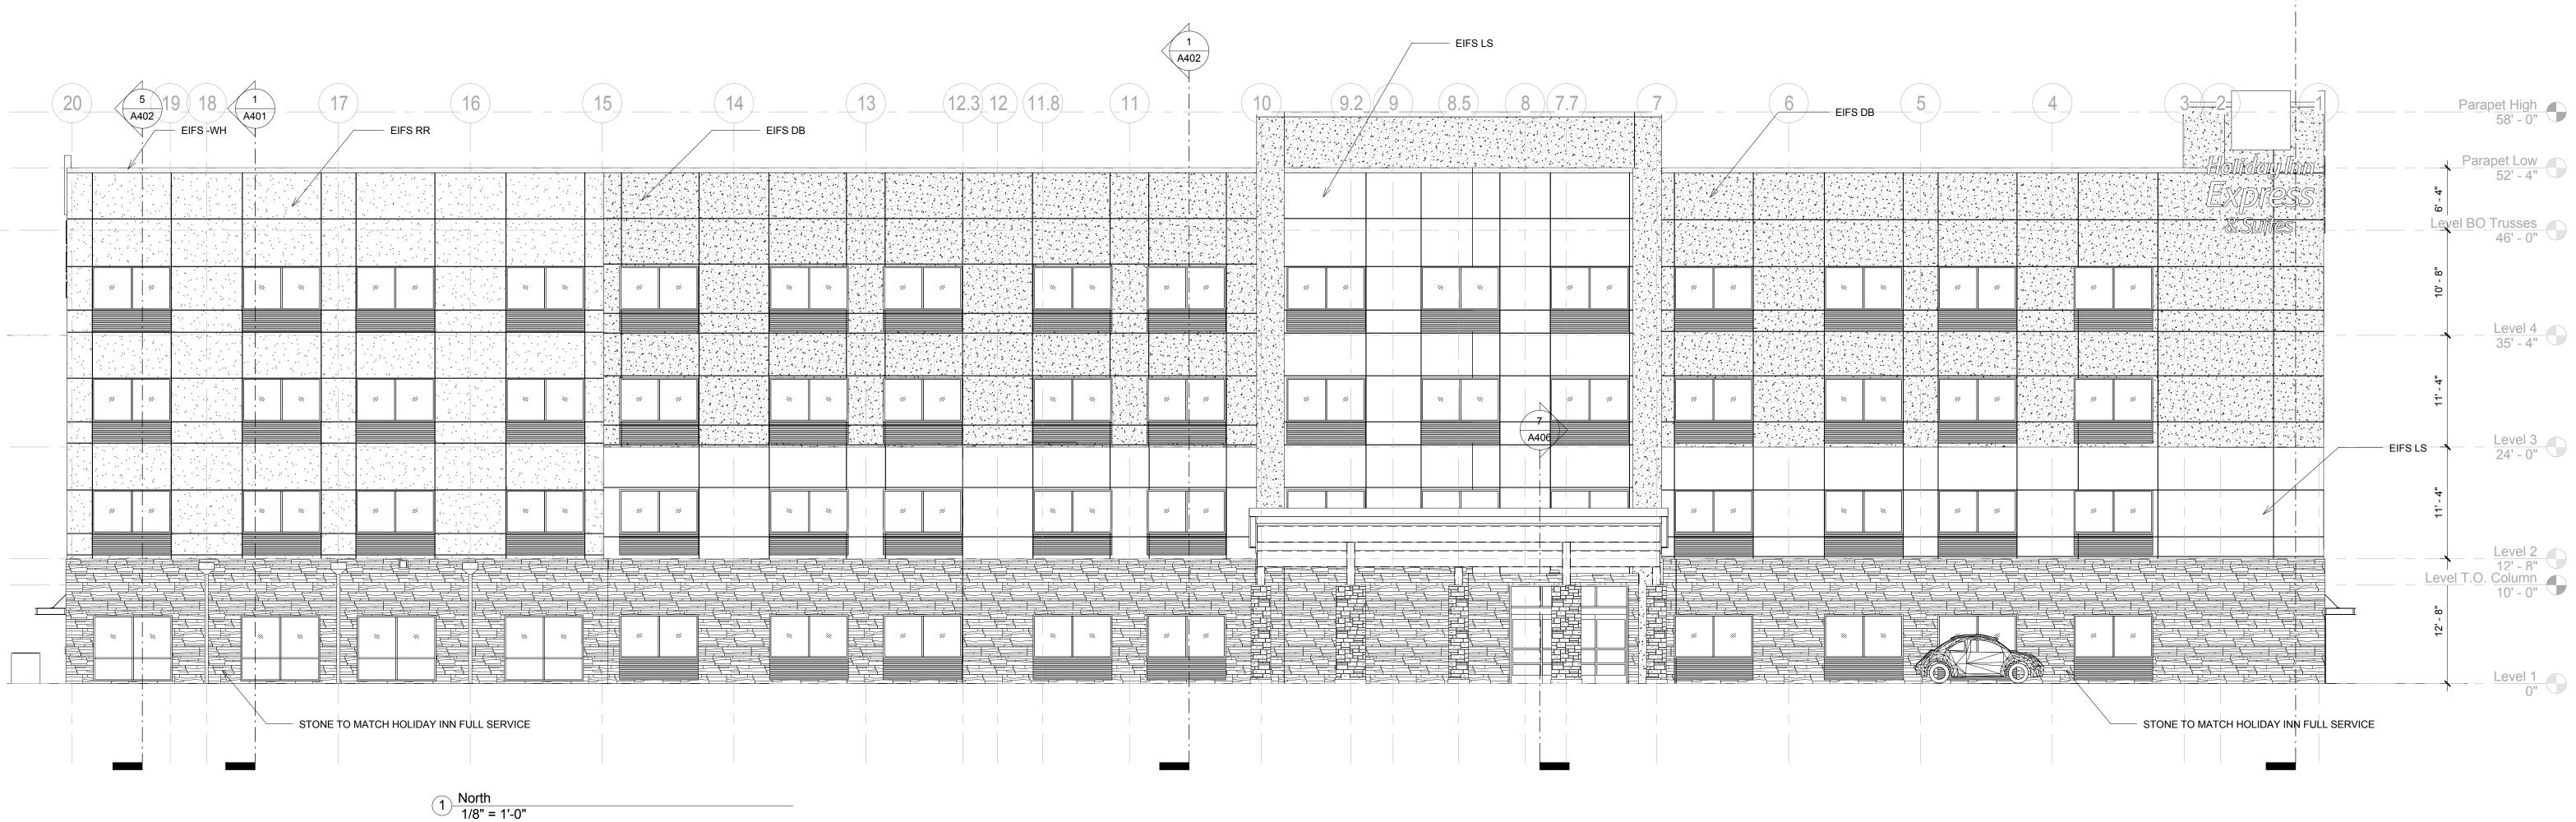
Level 3 Reflected Ceiling Plan
1/8" = 1'-0"





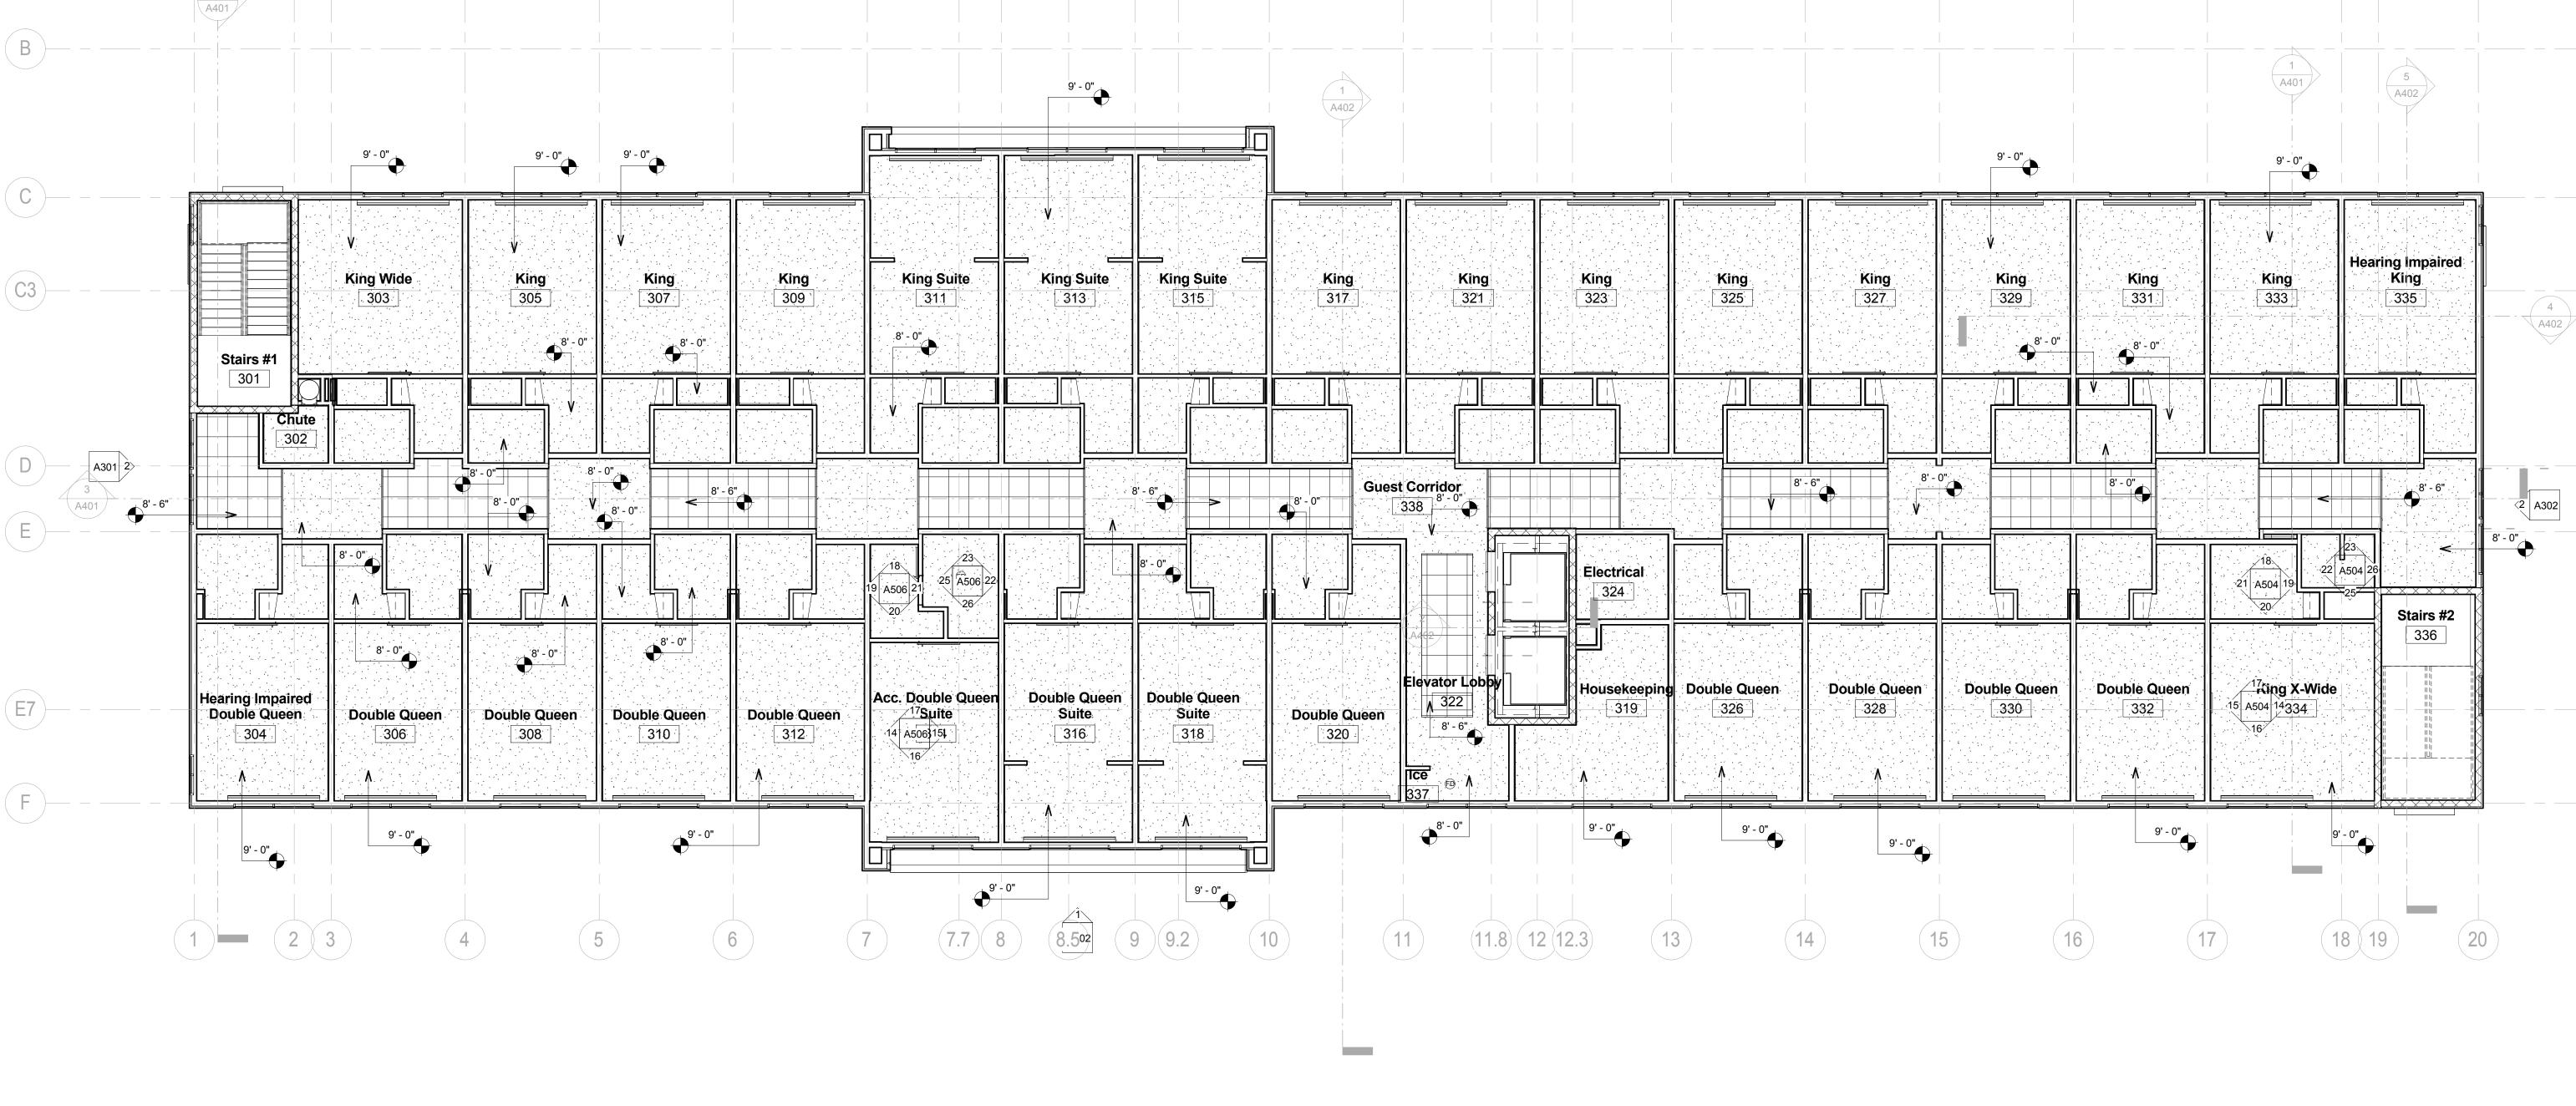

Author Checked by Checker Date Feb. 27, 2015



# EXTERIOR MATERIALS LEGEND.


### CONTEMPORARY EXTERIOR SCHEME


EIFS-LS, LIMESTONE/SANDSTONE.
PAREX TEXTURED, MULTI-TEXTURE SURFACE WITH PDR ACRYLIC FINISH.
EIFS-LSS, LIMESTONE/SANDSTONE.
PAREX SMOOTH, SAND SMOOTH SURFACE WITH PDR ACRYLIC FINISH.
COLOR: PAREX MOONDANCE 3027L.

EIFS-DB, DARK BRONZE.
PAREX MEDIUM, SAND FINE SURFACE WITH PDR ACRYLIC FINISH.
COLOR: PAREX TWIG 3021L.

EIFS-RR, RUSTIC RED.
PAREX SMOOTH, SAND SMOOTH SURFACE WITH PDR ACRYLIC FINISH.
COLOR: PAREX SUN DRIED 3011L.

EIFS-WH, WHITE.
PAREX SMOOTH, SAND SMOOTH SURFACE WITH PDR ACRYLIC FINISH.
COLOR: PAREX SNOWBALL 10400L.

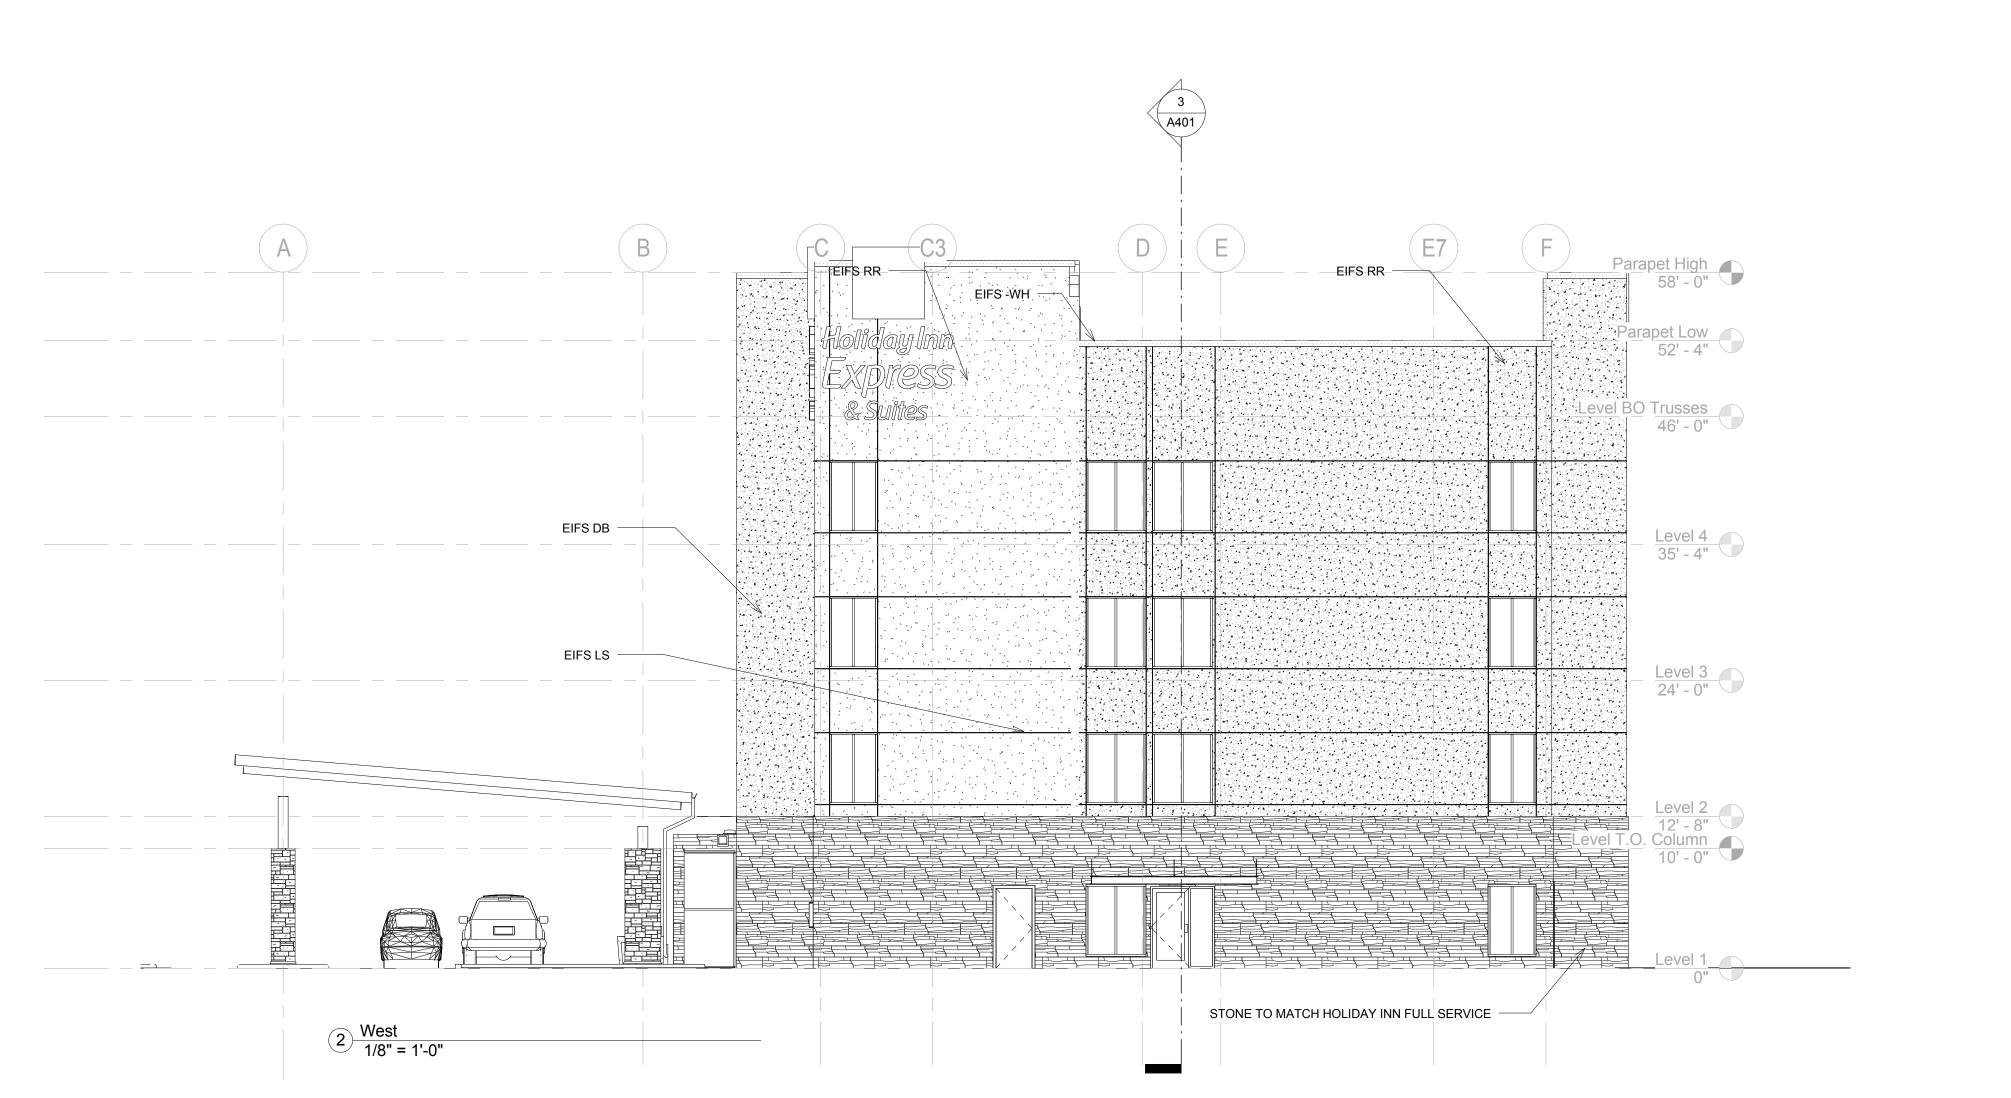

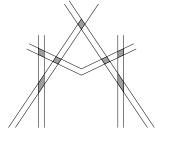

(A401)

## MISHRA Architecture plic

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Holiday Inn Express & Suites

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Drawing Title
Elevations

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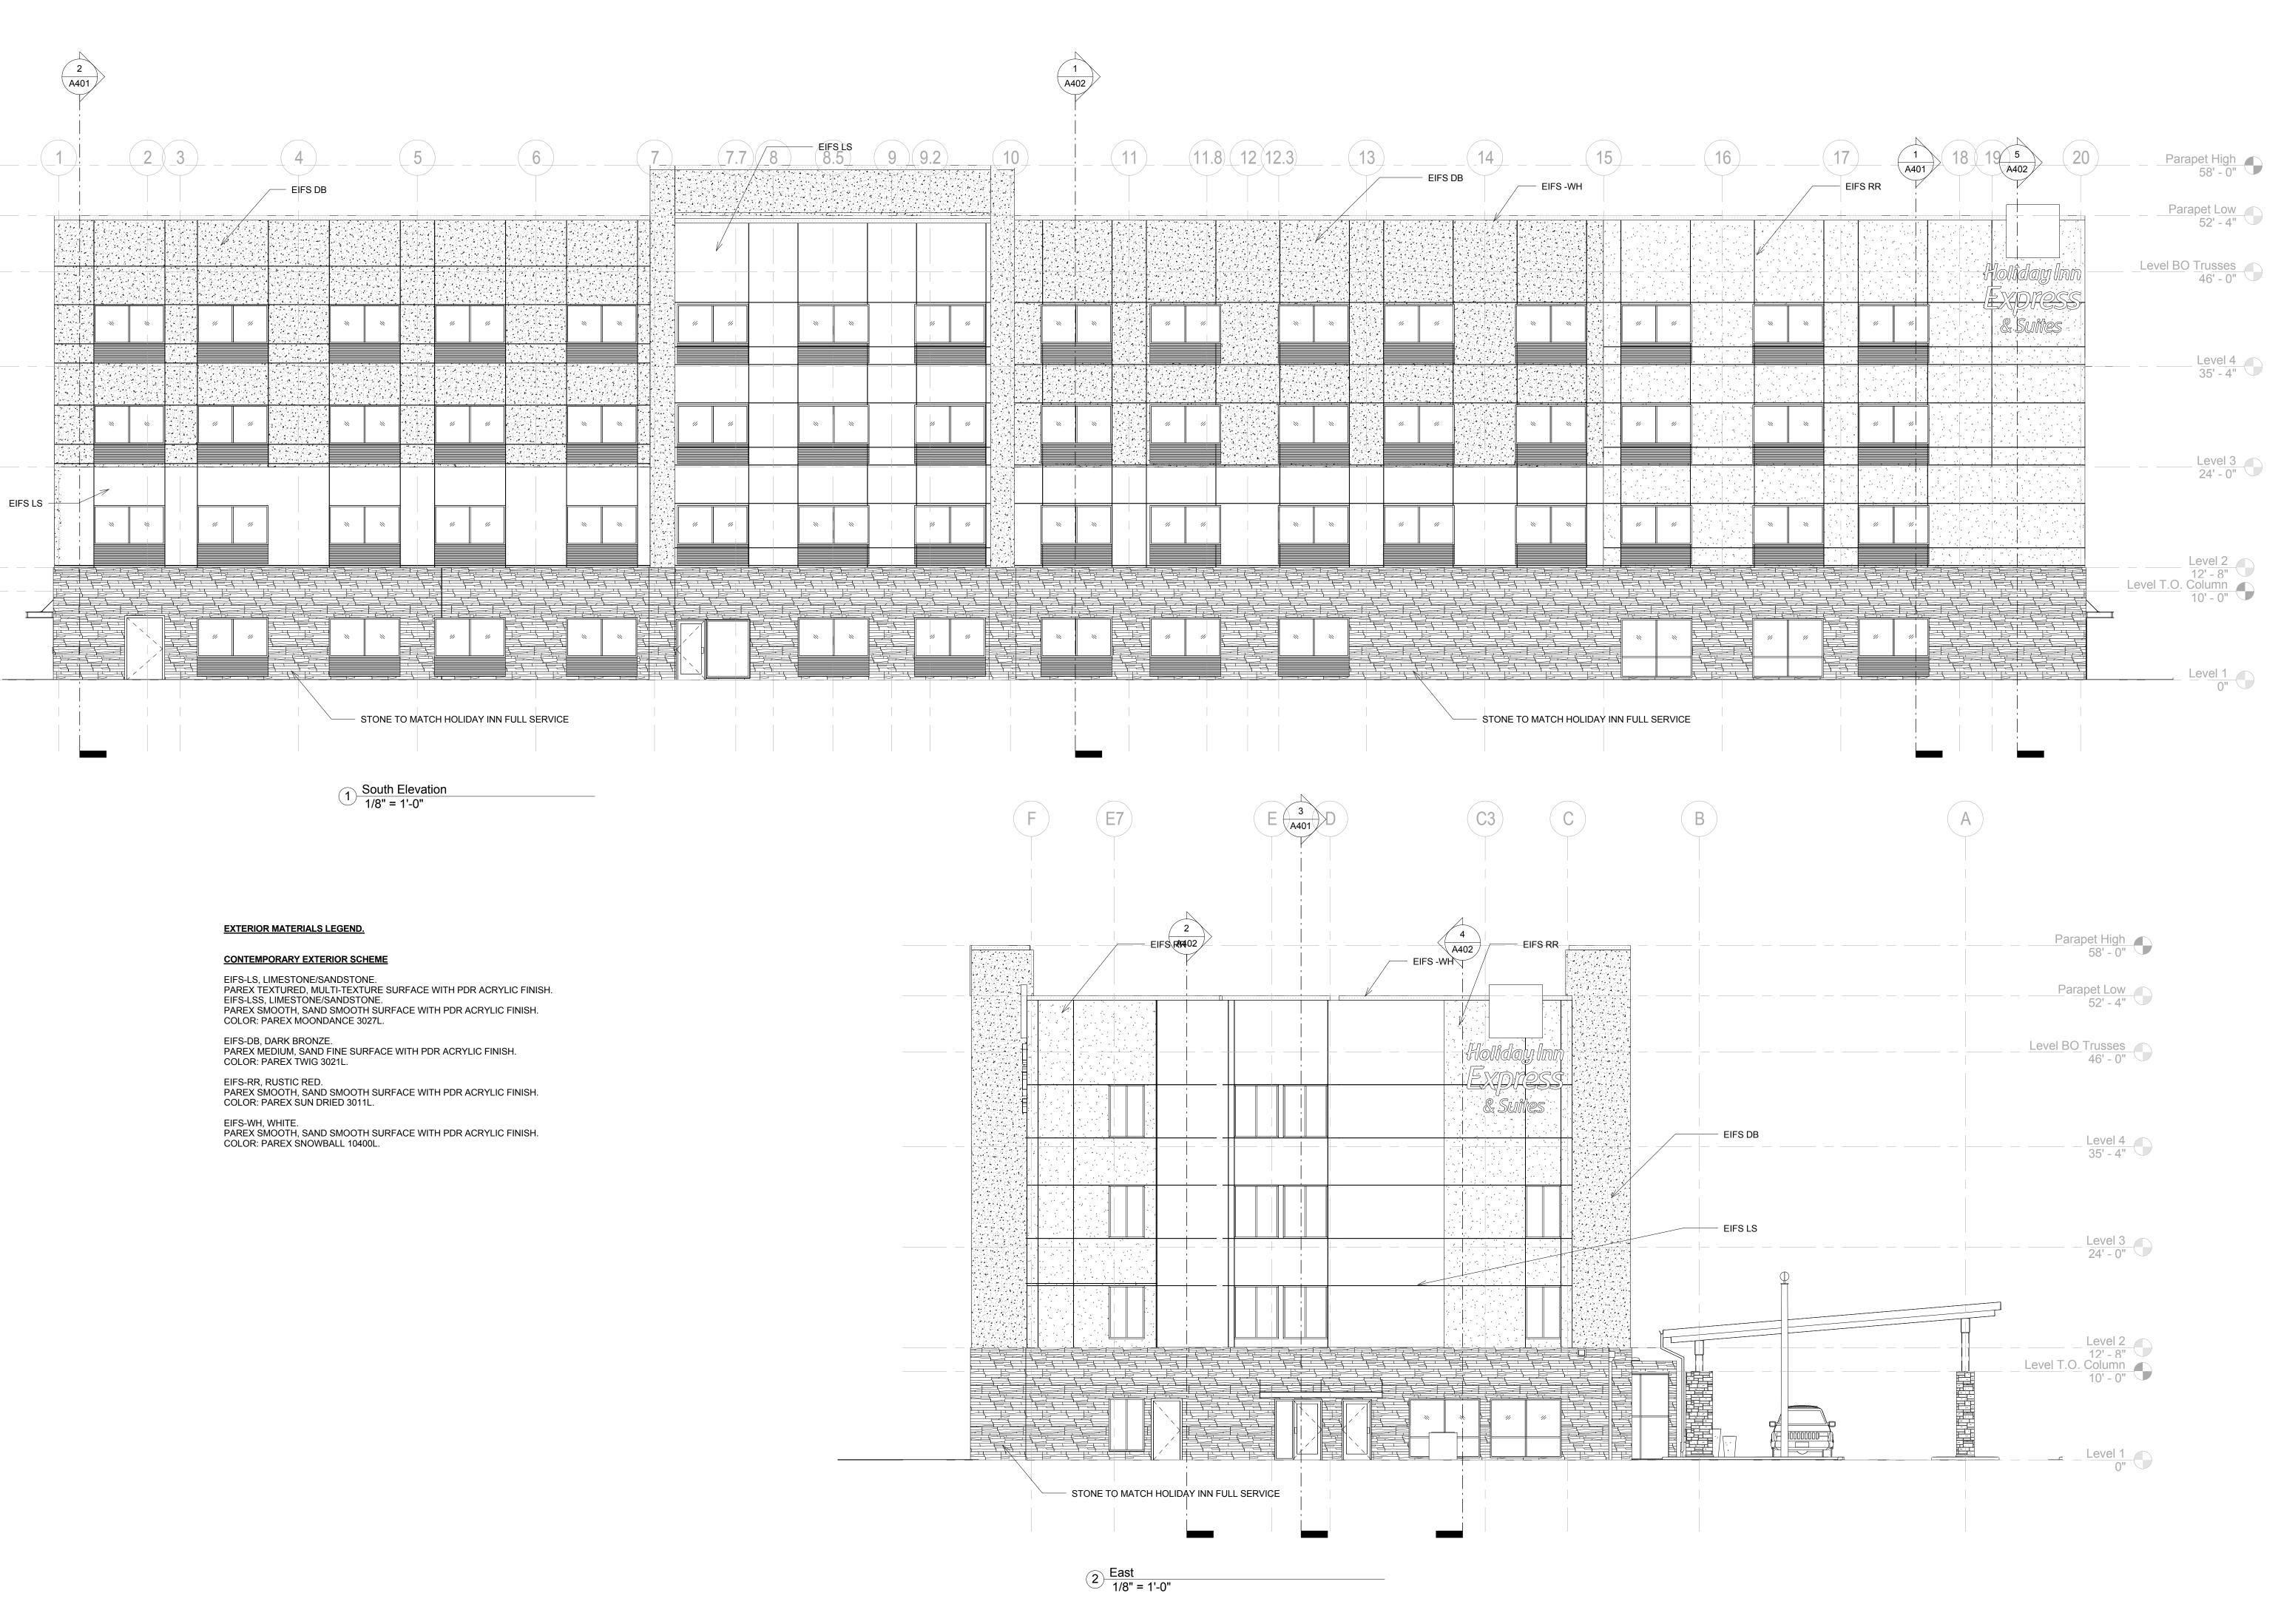
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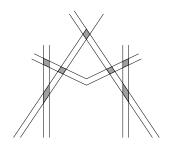
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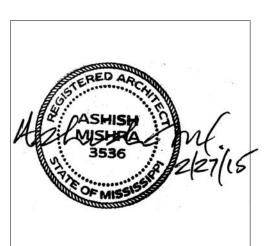
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Lot 16 (Rev Lot 3) Southcrest Pkwy. Southcrest Subdivision Southaven, MS 38671

Drawing Title

Elevations

Phase
Construction Documents


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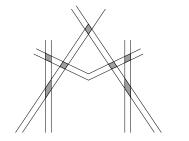
Sheet No.

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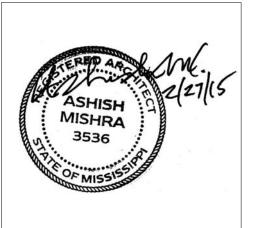
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KEY PLAN

Shiva Southaven

Holiday Inn Express & Suites

Lot 16 (Rev Lot 3) Southcrest Pkwy. Southcrest Subdivision Southaven, MS 38671

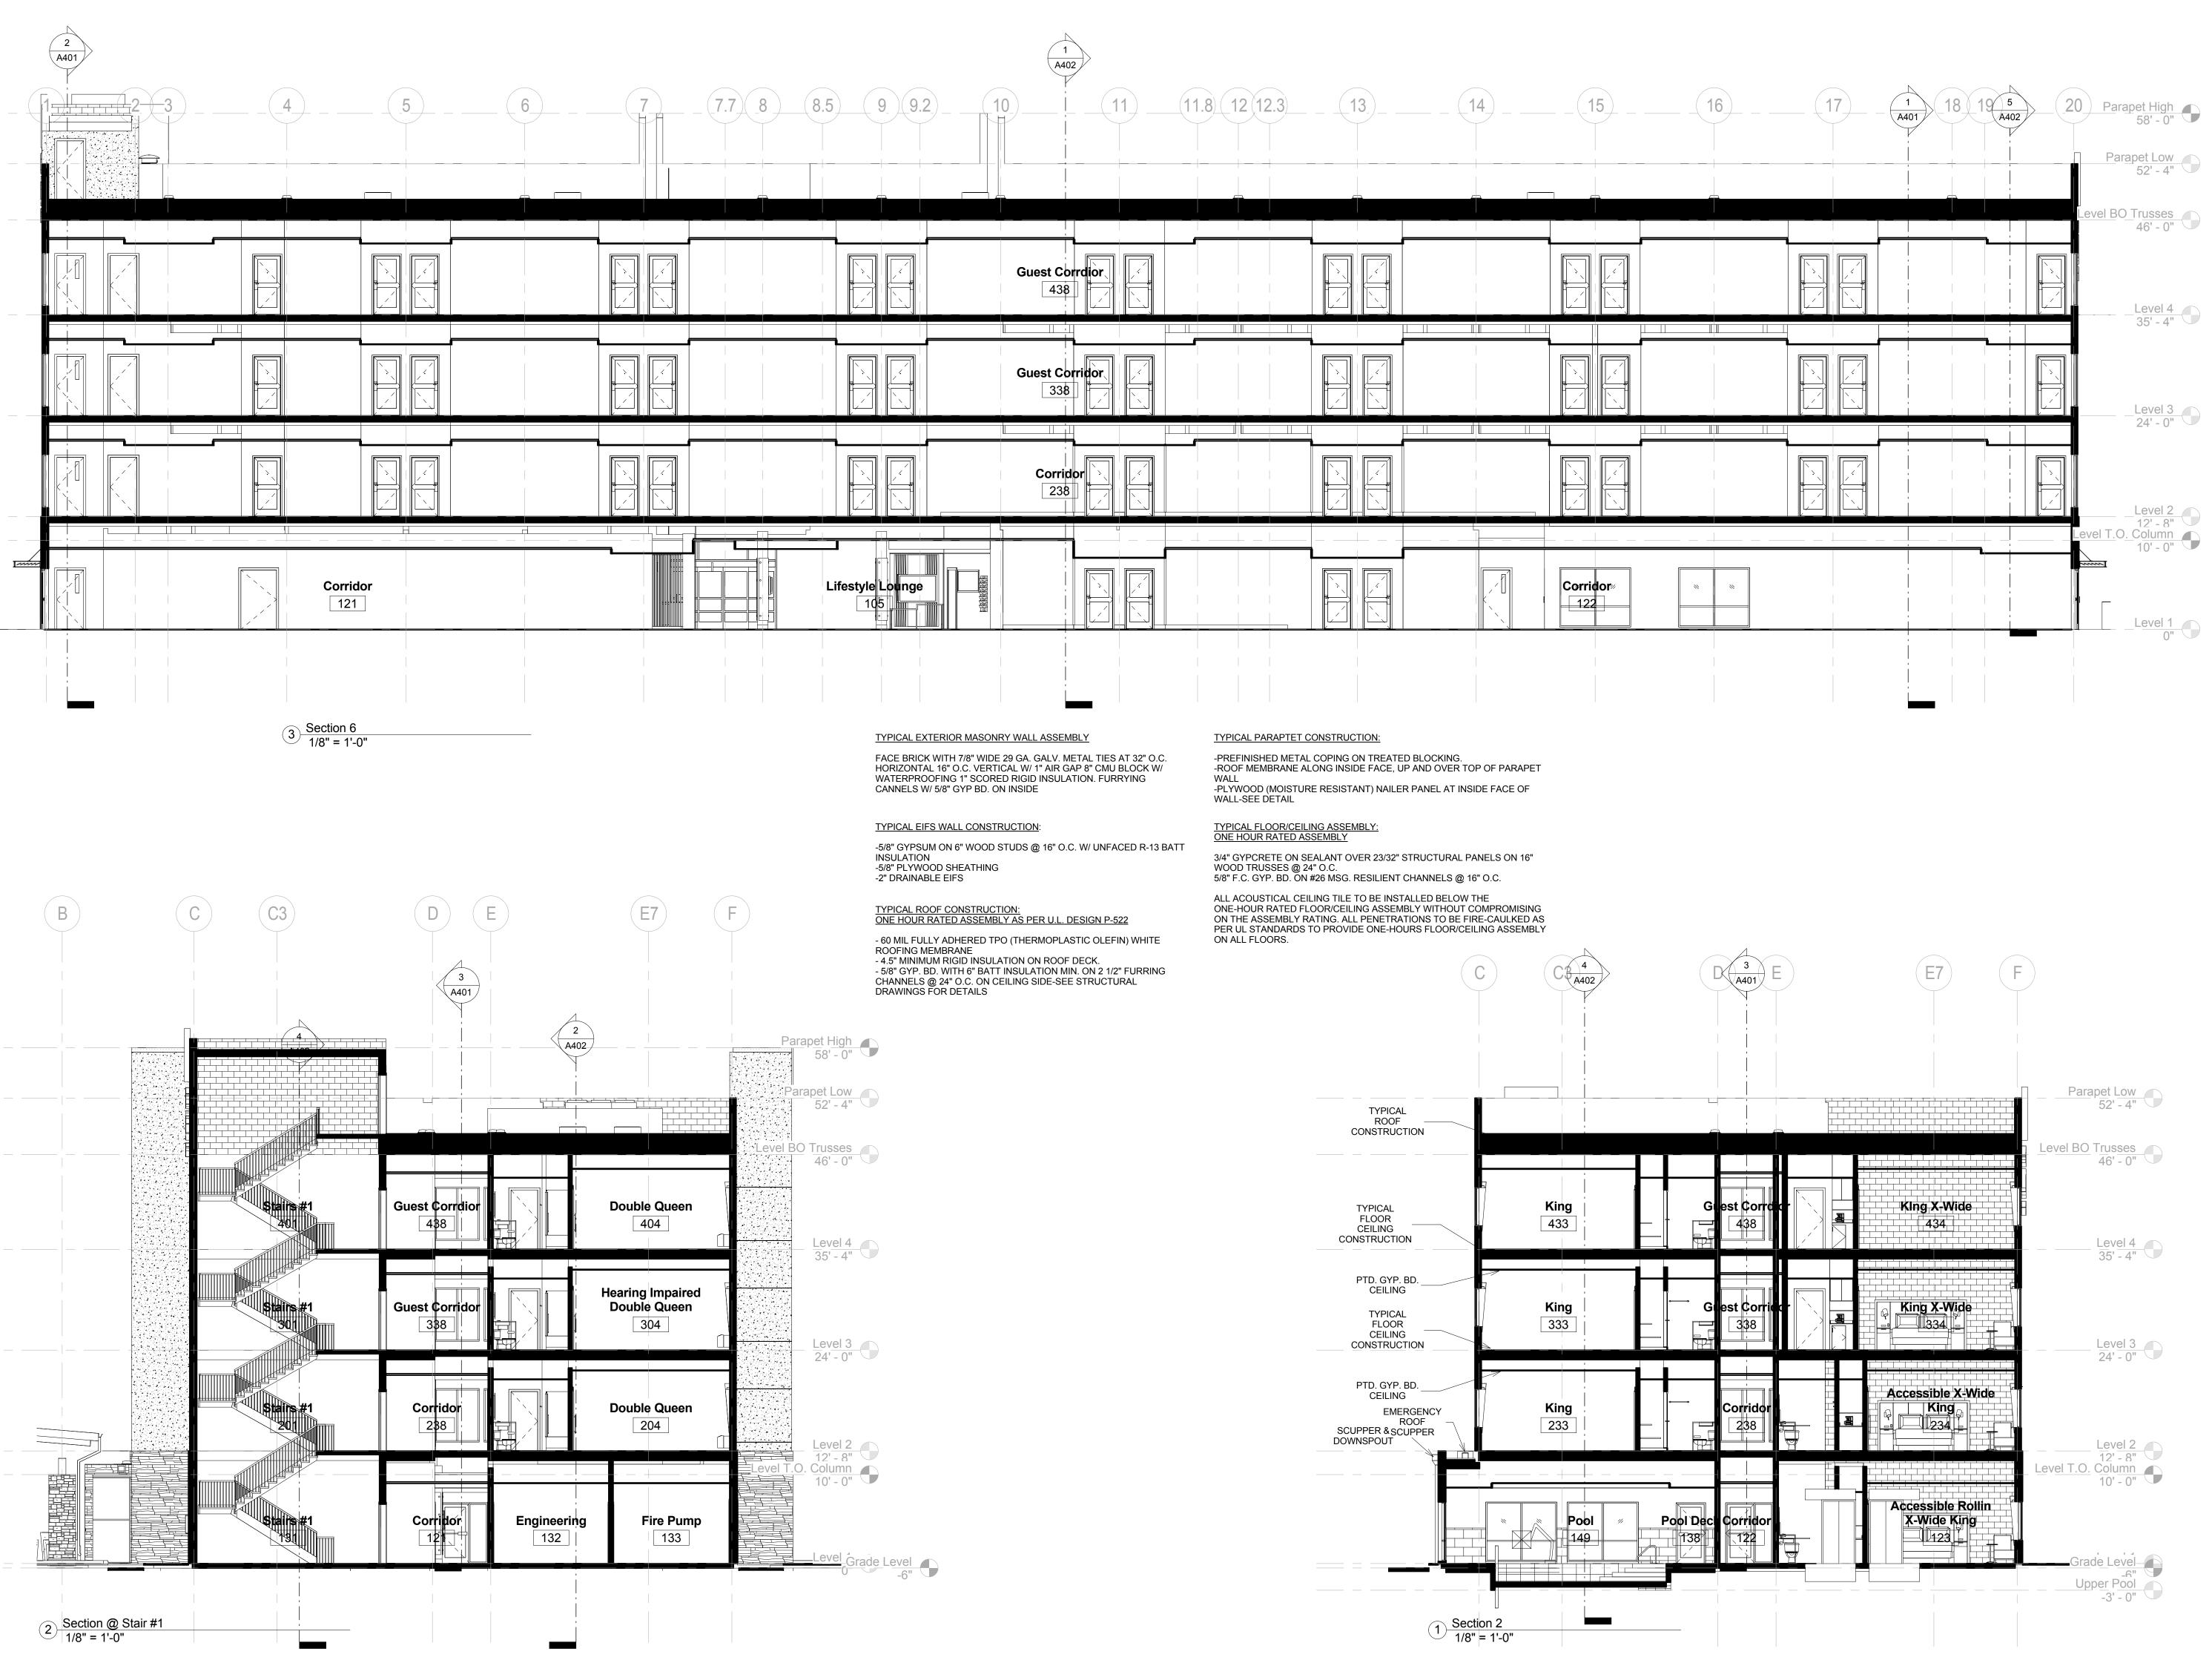Drawing Title
Sections

Phase Construction Documents


Project No. 14-081
Prepared by Author
Checked by Checker
Date Feb. 27, 2015

Sheet No.


A401

Review

2/2/2016 E:1E:0E AM

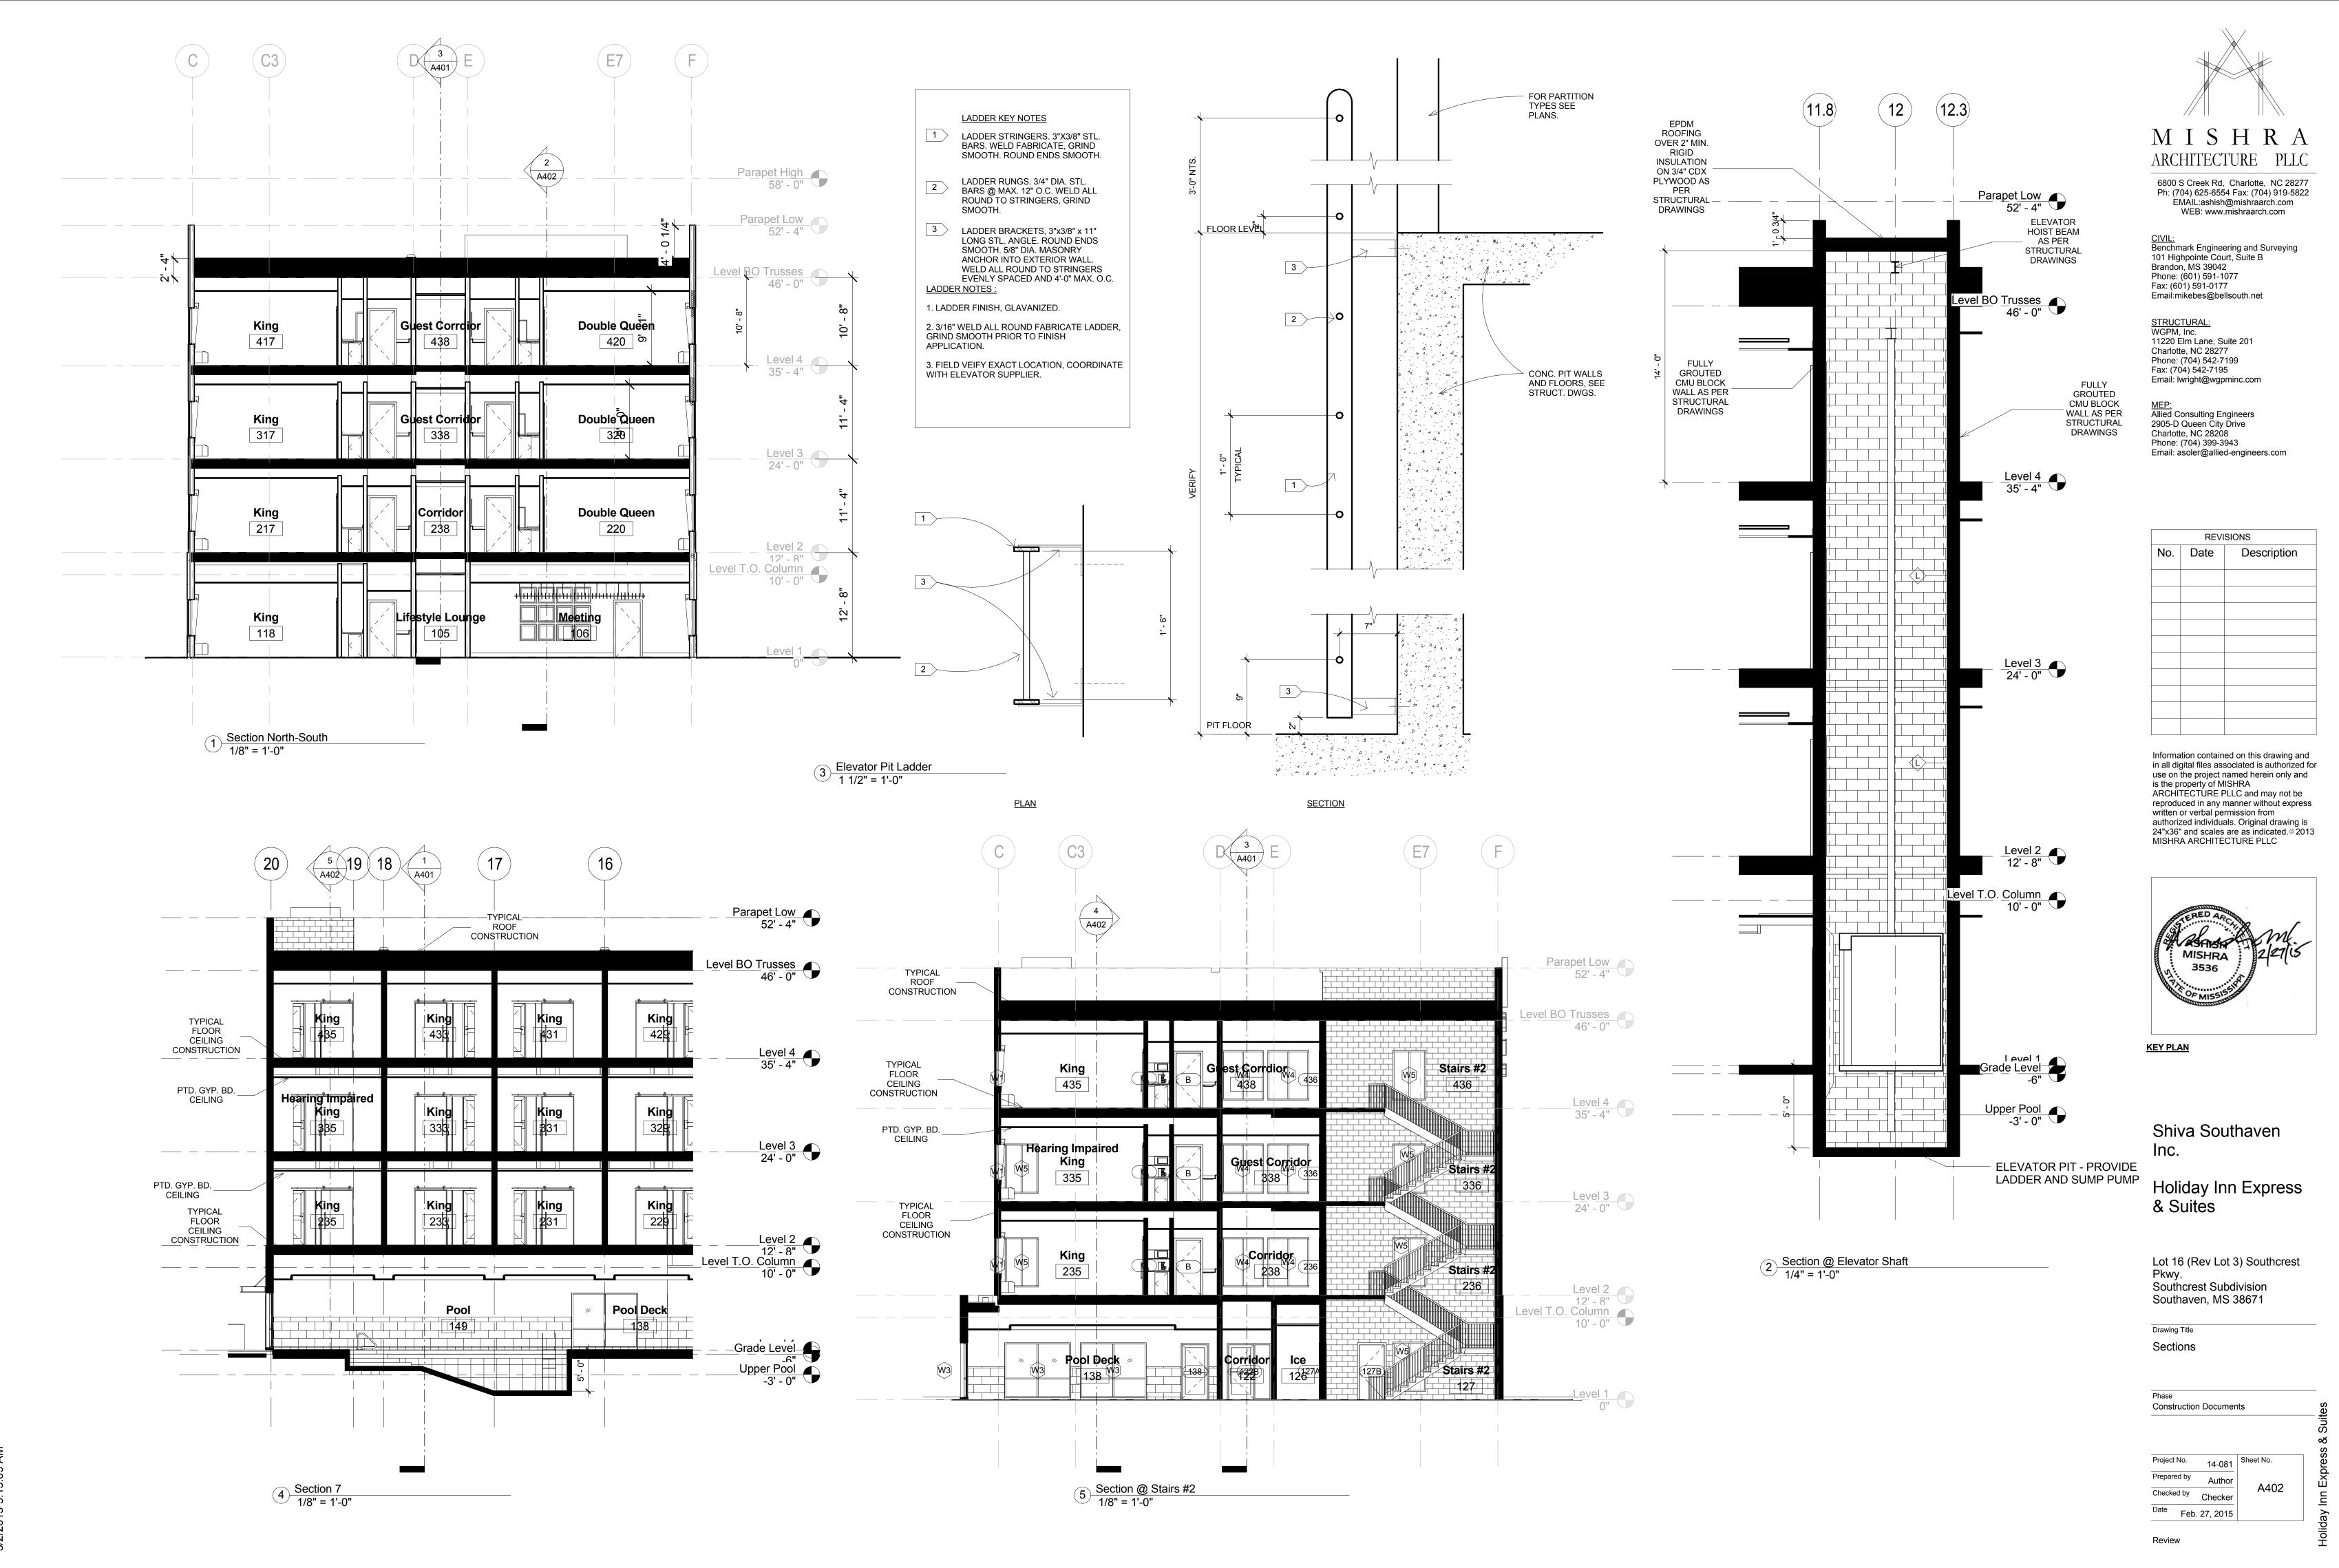

72015 5.15.09 AM

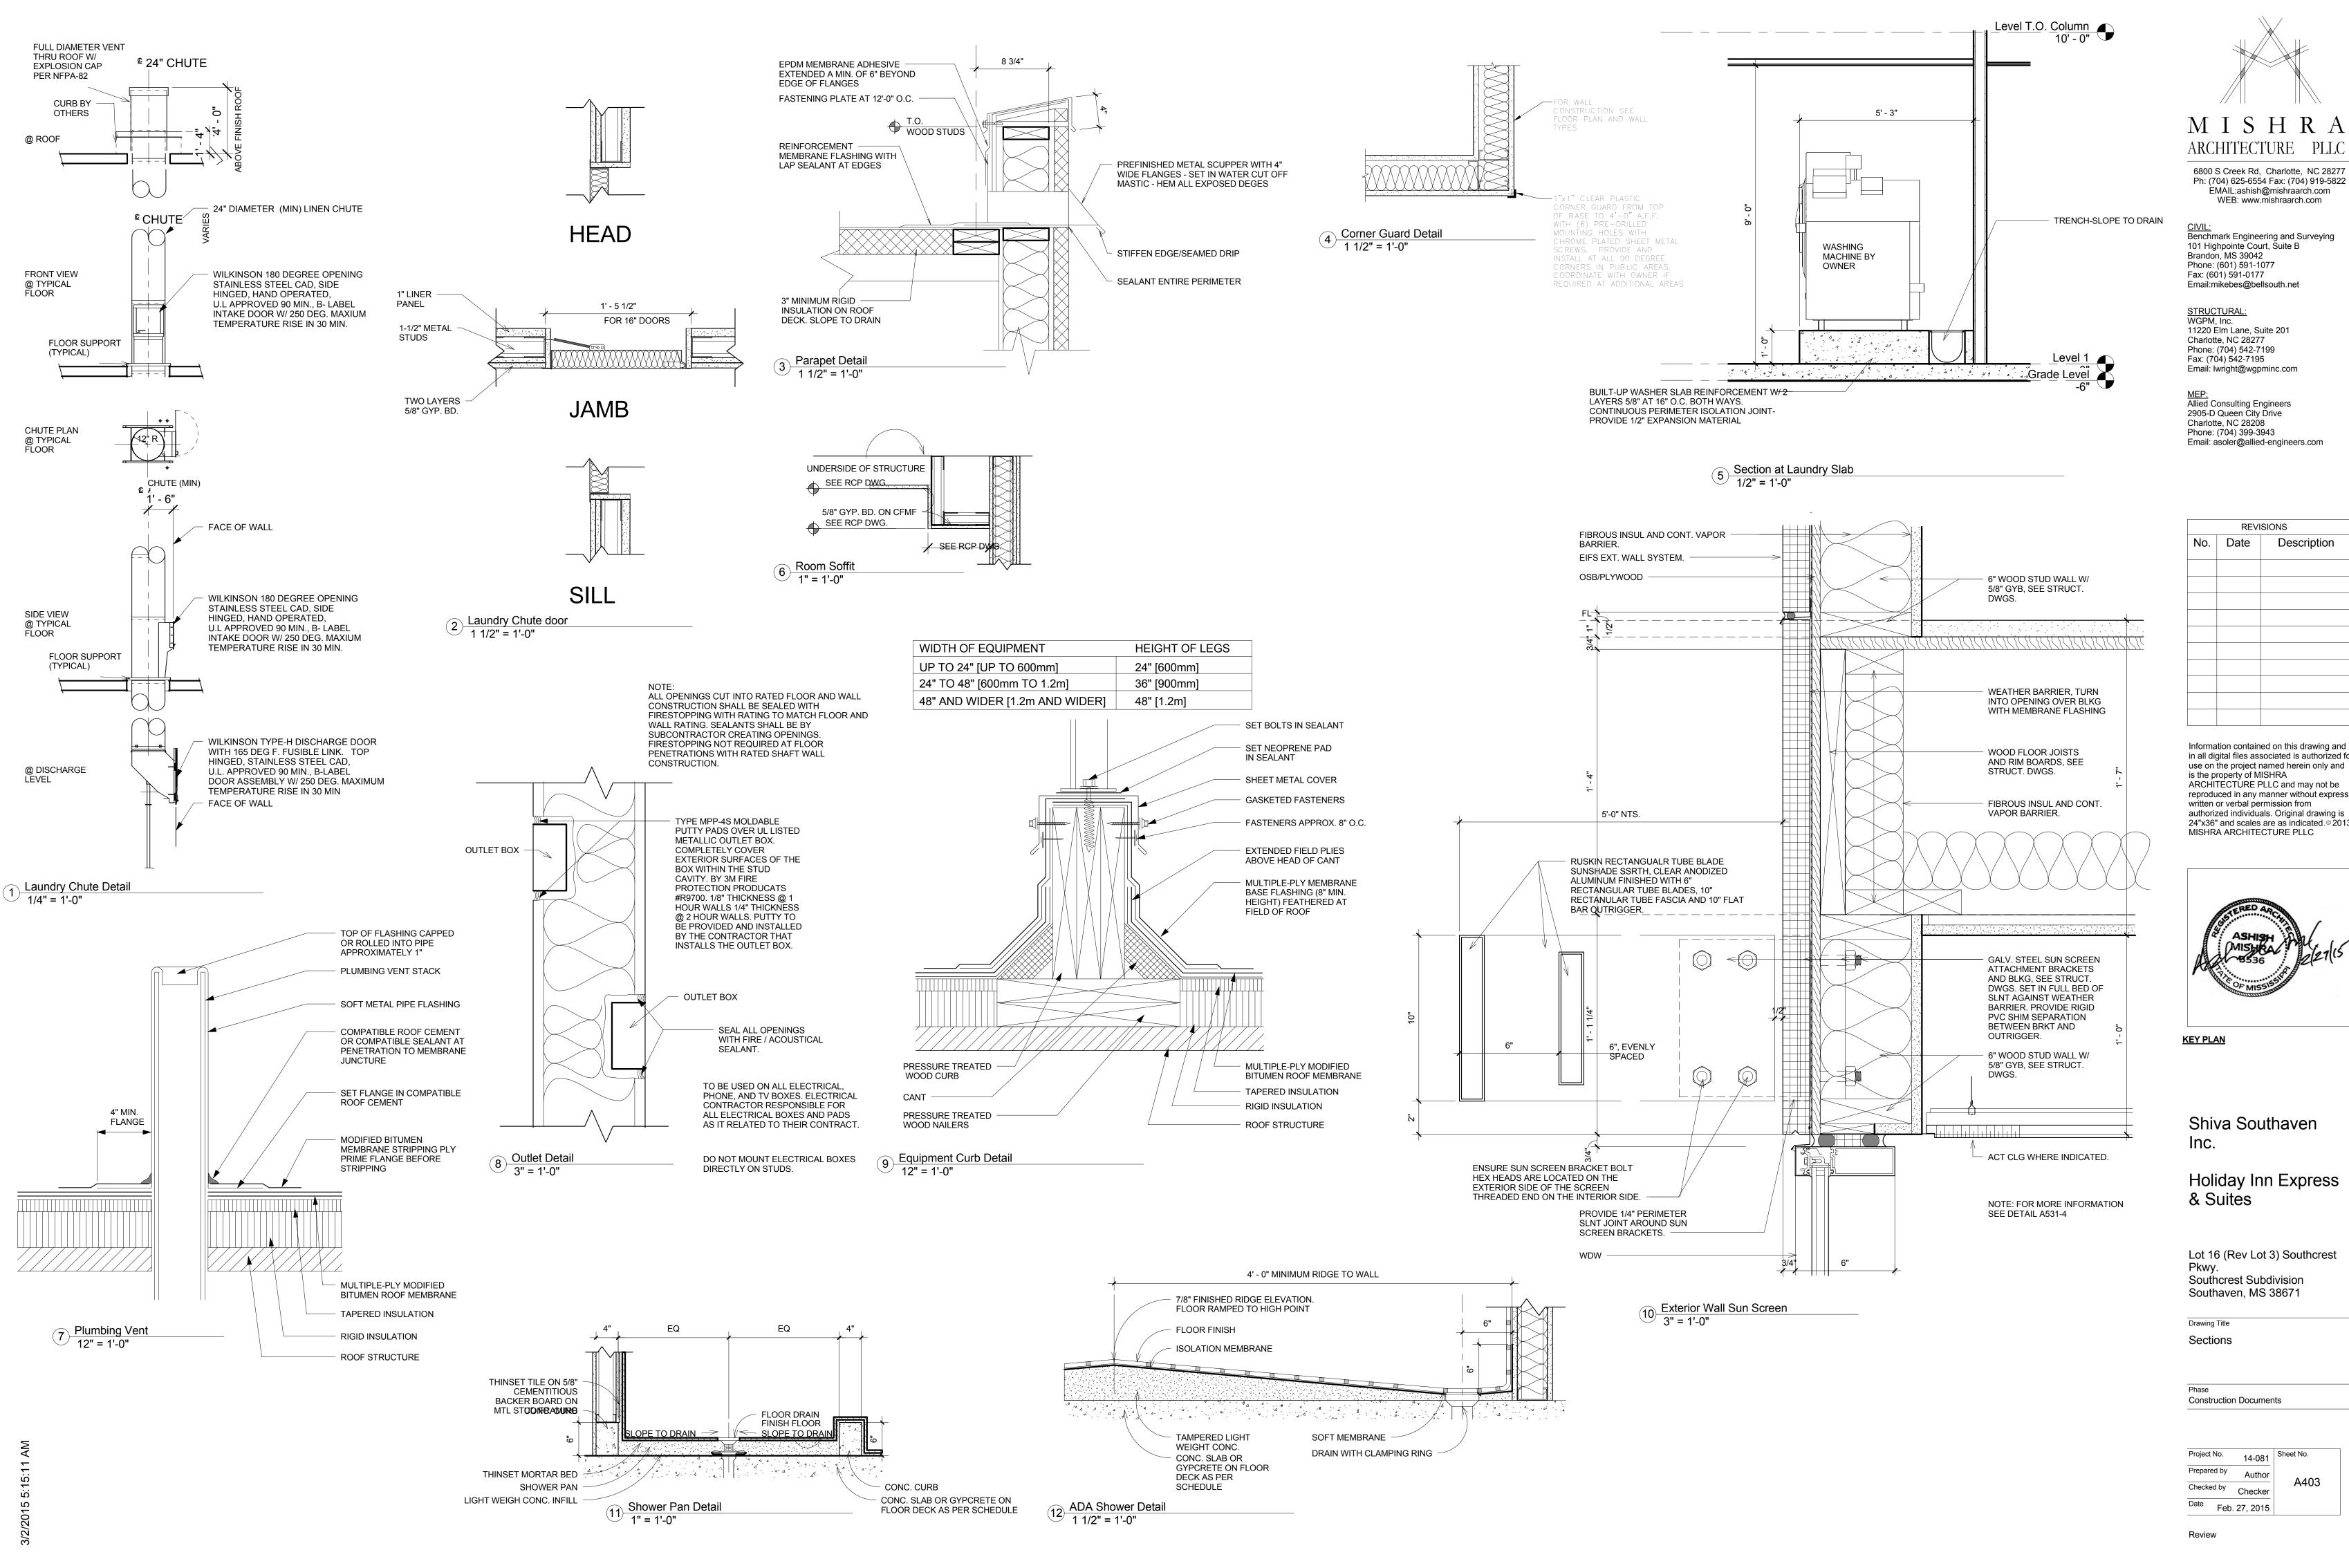

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Shiva Southaven

Holiday Inn Express

Lot 16 (Rev Lot 3) Southcrest Southcrest Subdivision

Construction Documents

14-081 Sheet No. Author Checker Date Feb. 27, 2015



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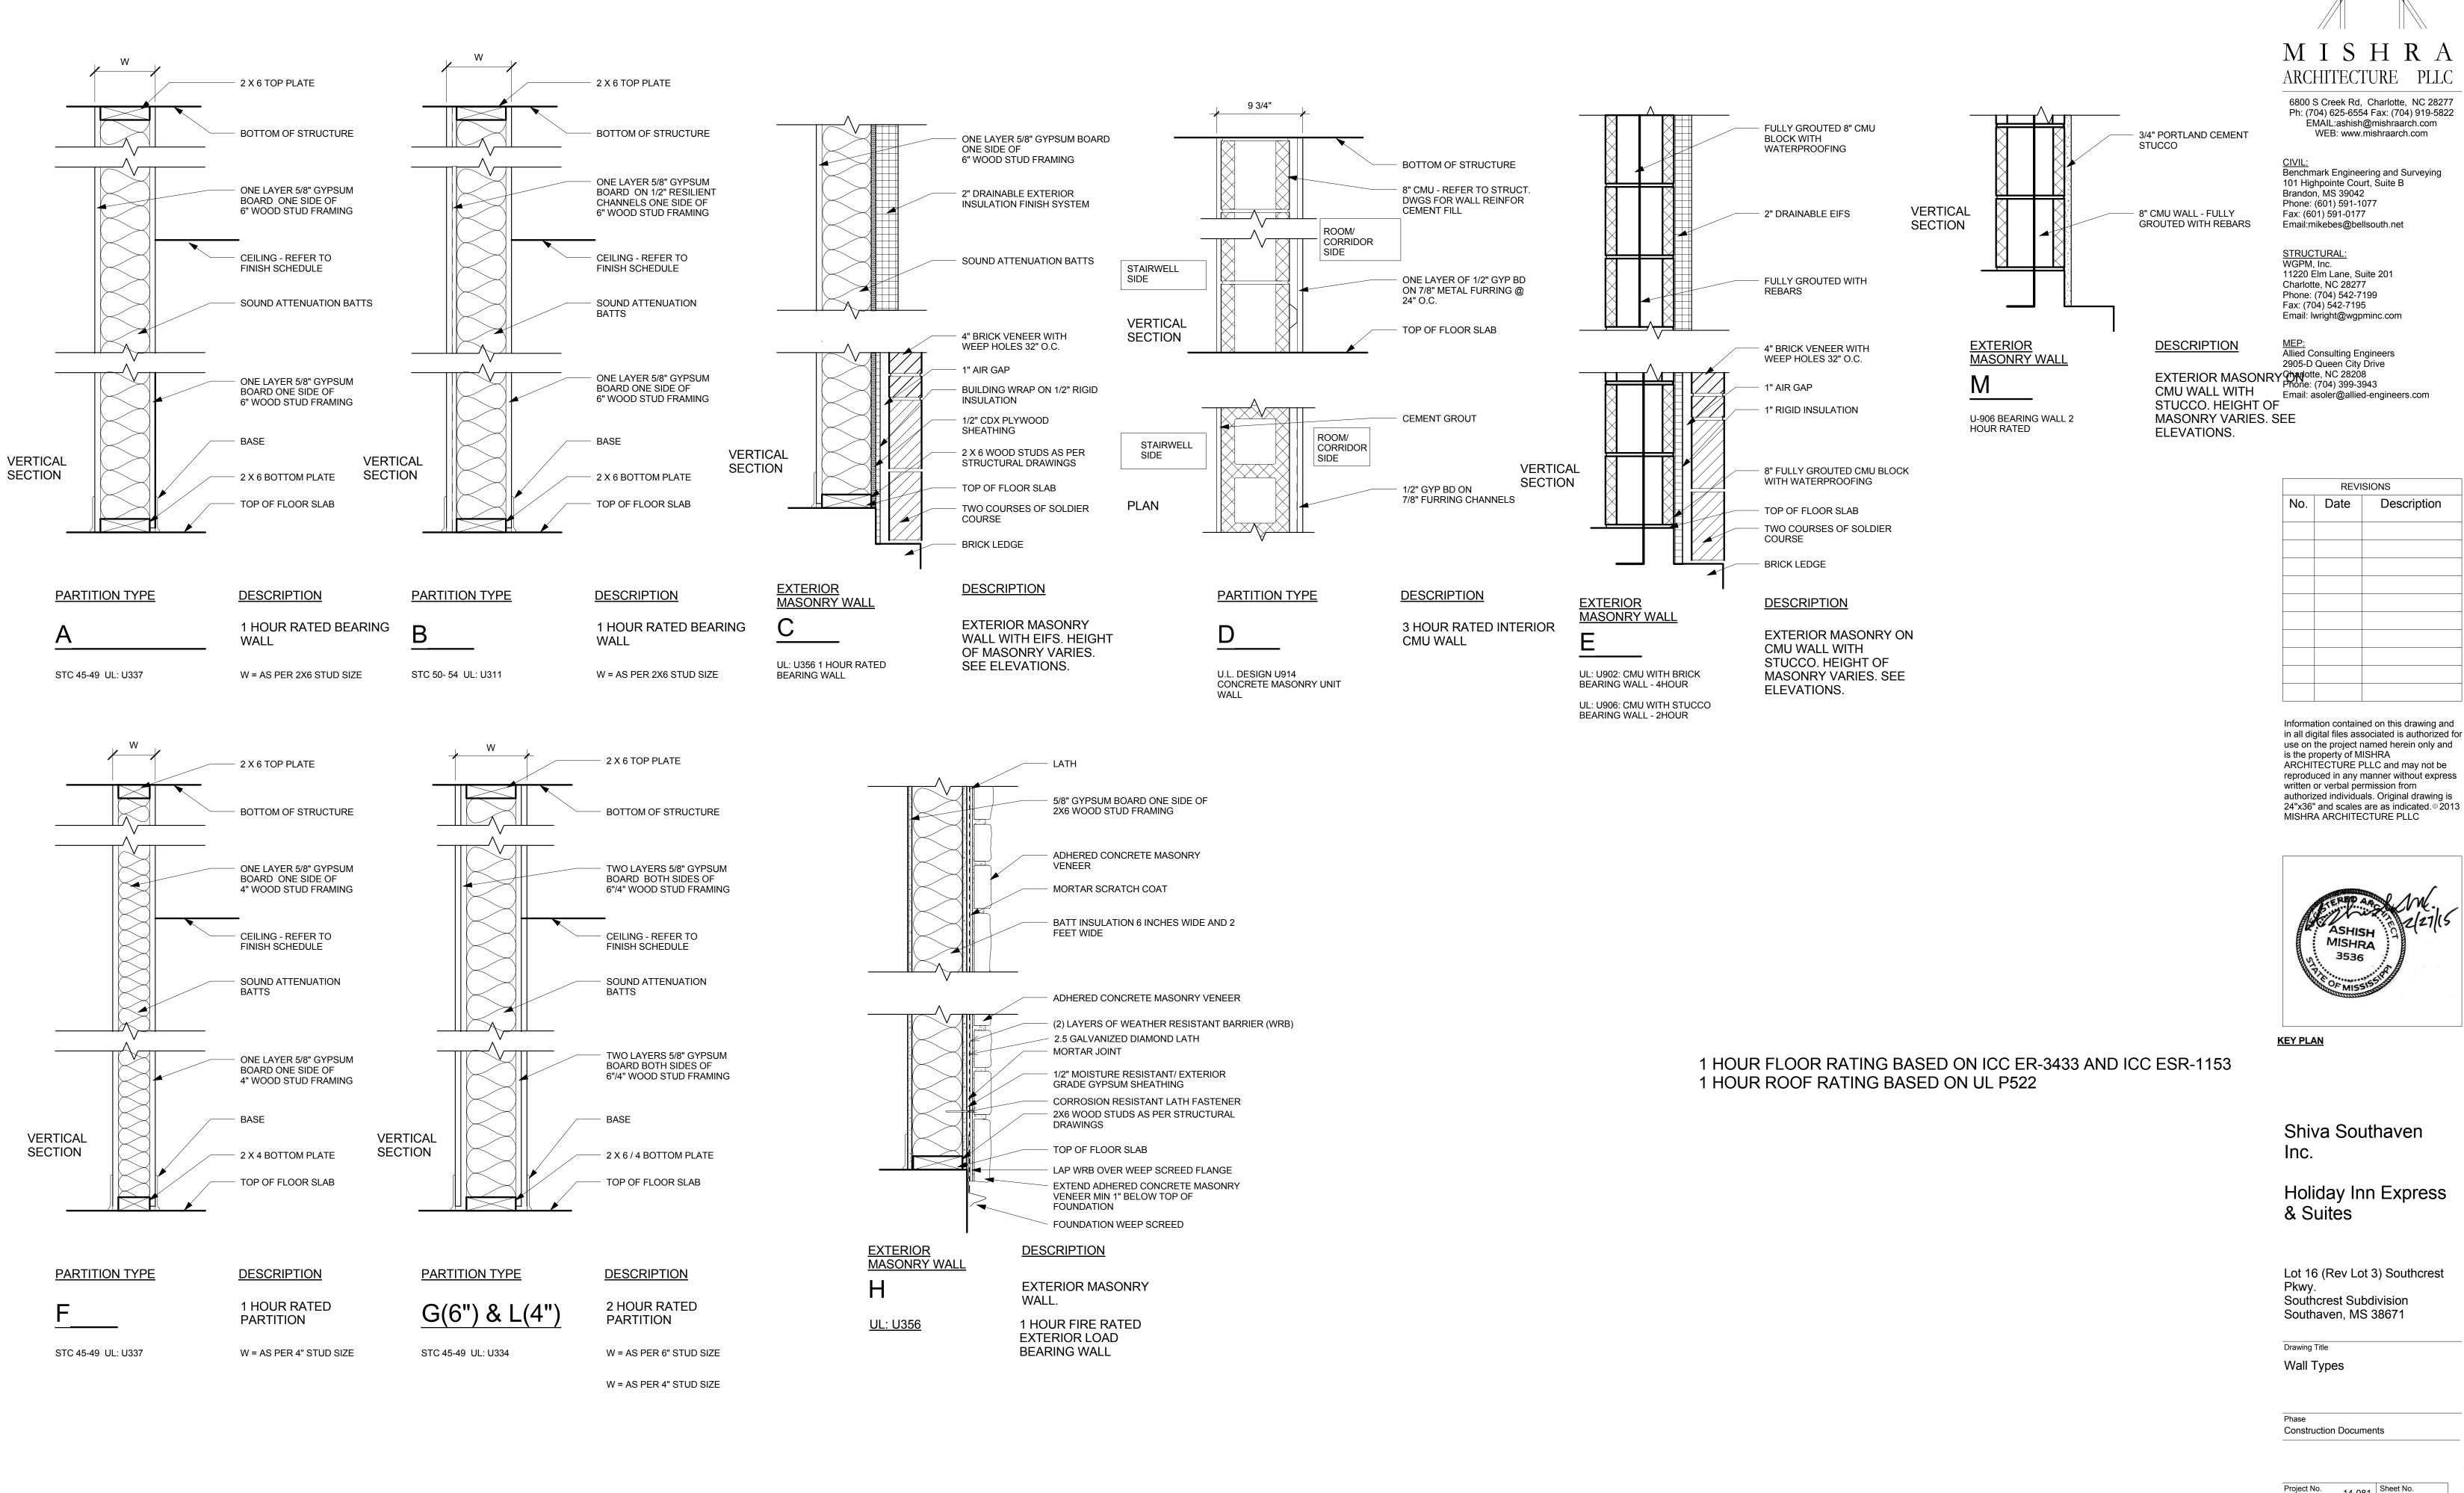
REVISIONS

MISHRA

3536

Description

No. Date



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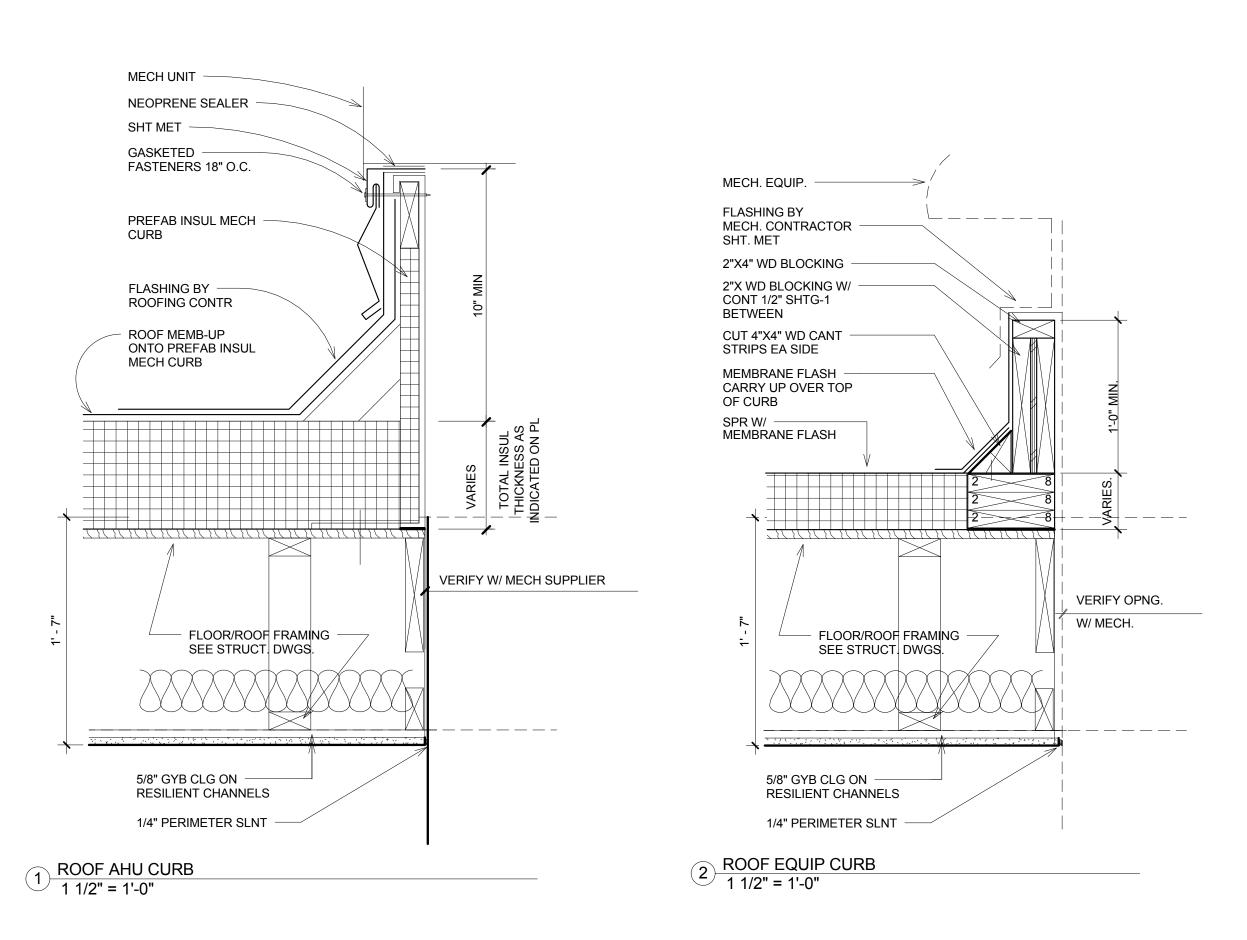
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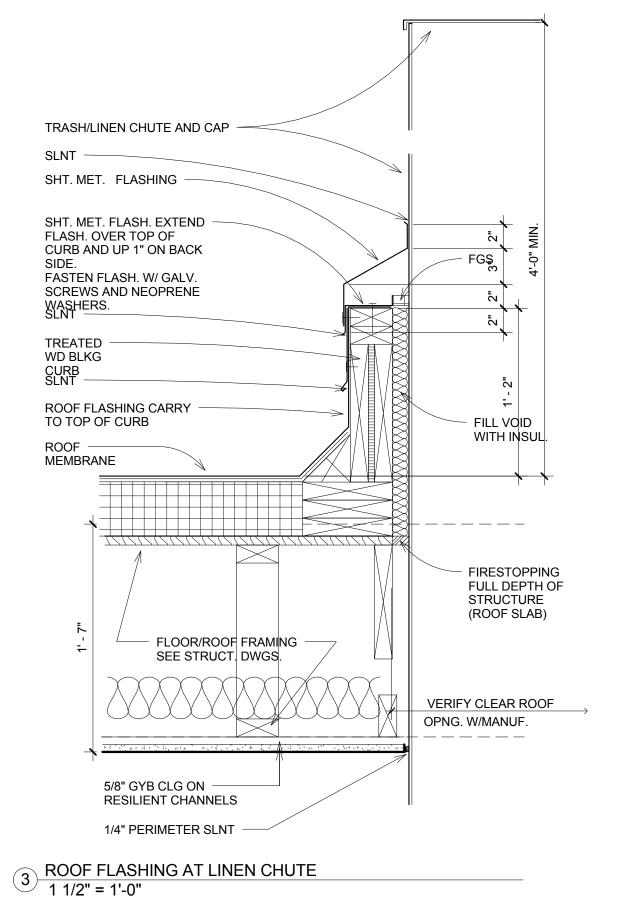
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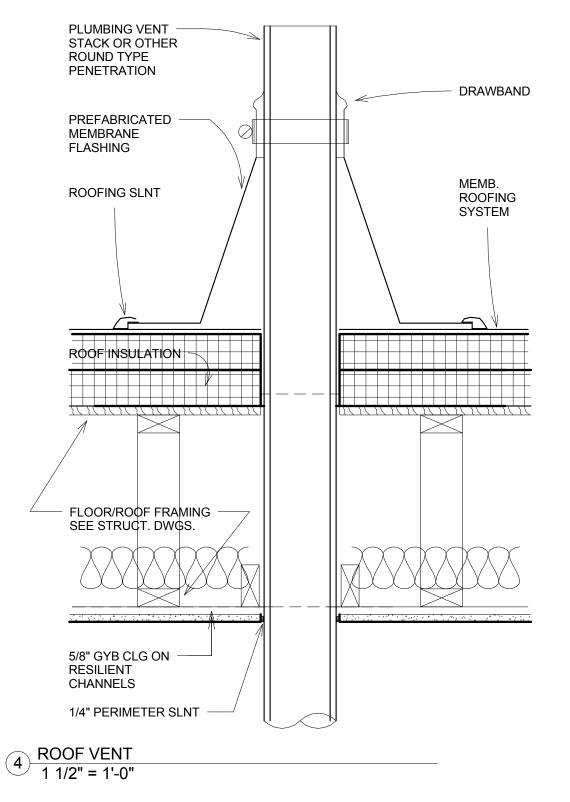
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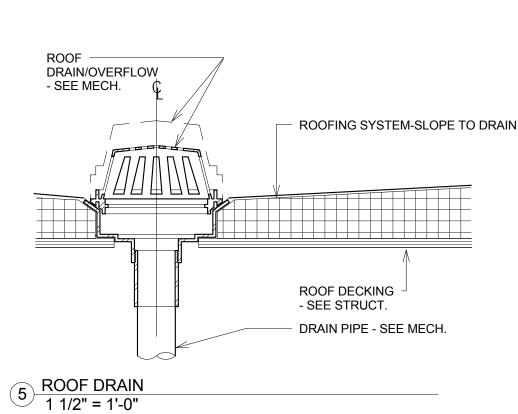
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CONSTRUCTION NOTE:
EIFS THICKNESS IS TYPICALLY 1 3/4". WHERE
INDICTAED ON EXTERIOR ELEVATION AS EIFS 3",
ADJUST DETAIL FOR EIFS THICKNESS 3 1/4". SEE
ALSO EIFS TRANSITION DETAILS FOR
ADDITIONAL INFORMATION.
GUESTROOM DEMISING WALL REGIONAL
PREFERENCE, IT IS ACCEPTABLE TO REPLACE
THE SEPARATE WALL CONSTRUCTION FOR THE
GUESTROOM DEMISING WALL WITH THE A
SINGLE WALL USING COMMON 2X8 TOP AND
BOTTOM PLATES AND STAGGERED STUDS.



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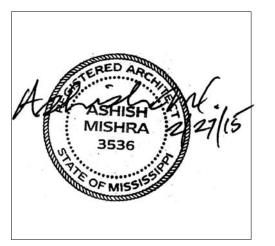
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Holiday Inn Express & Suites


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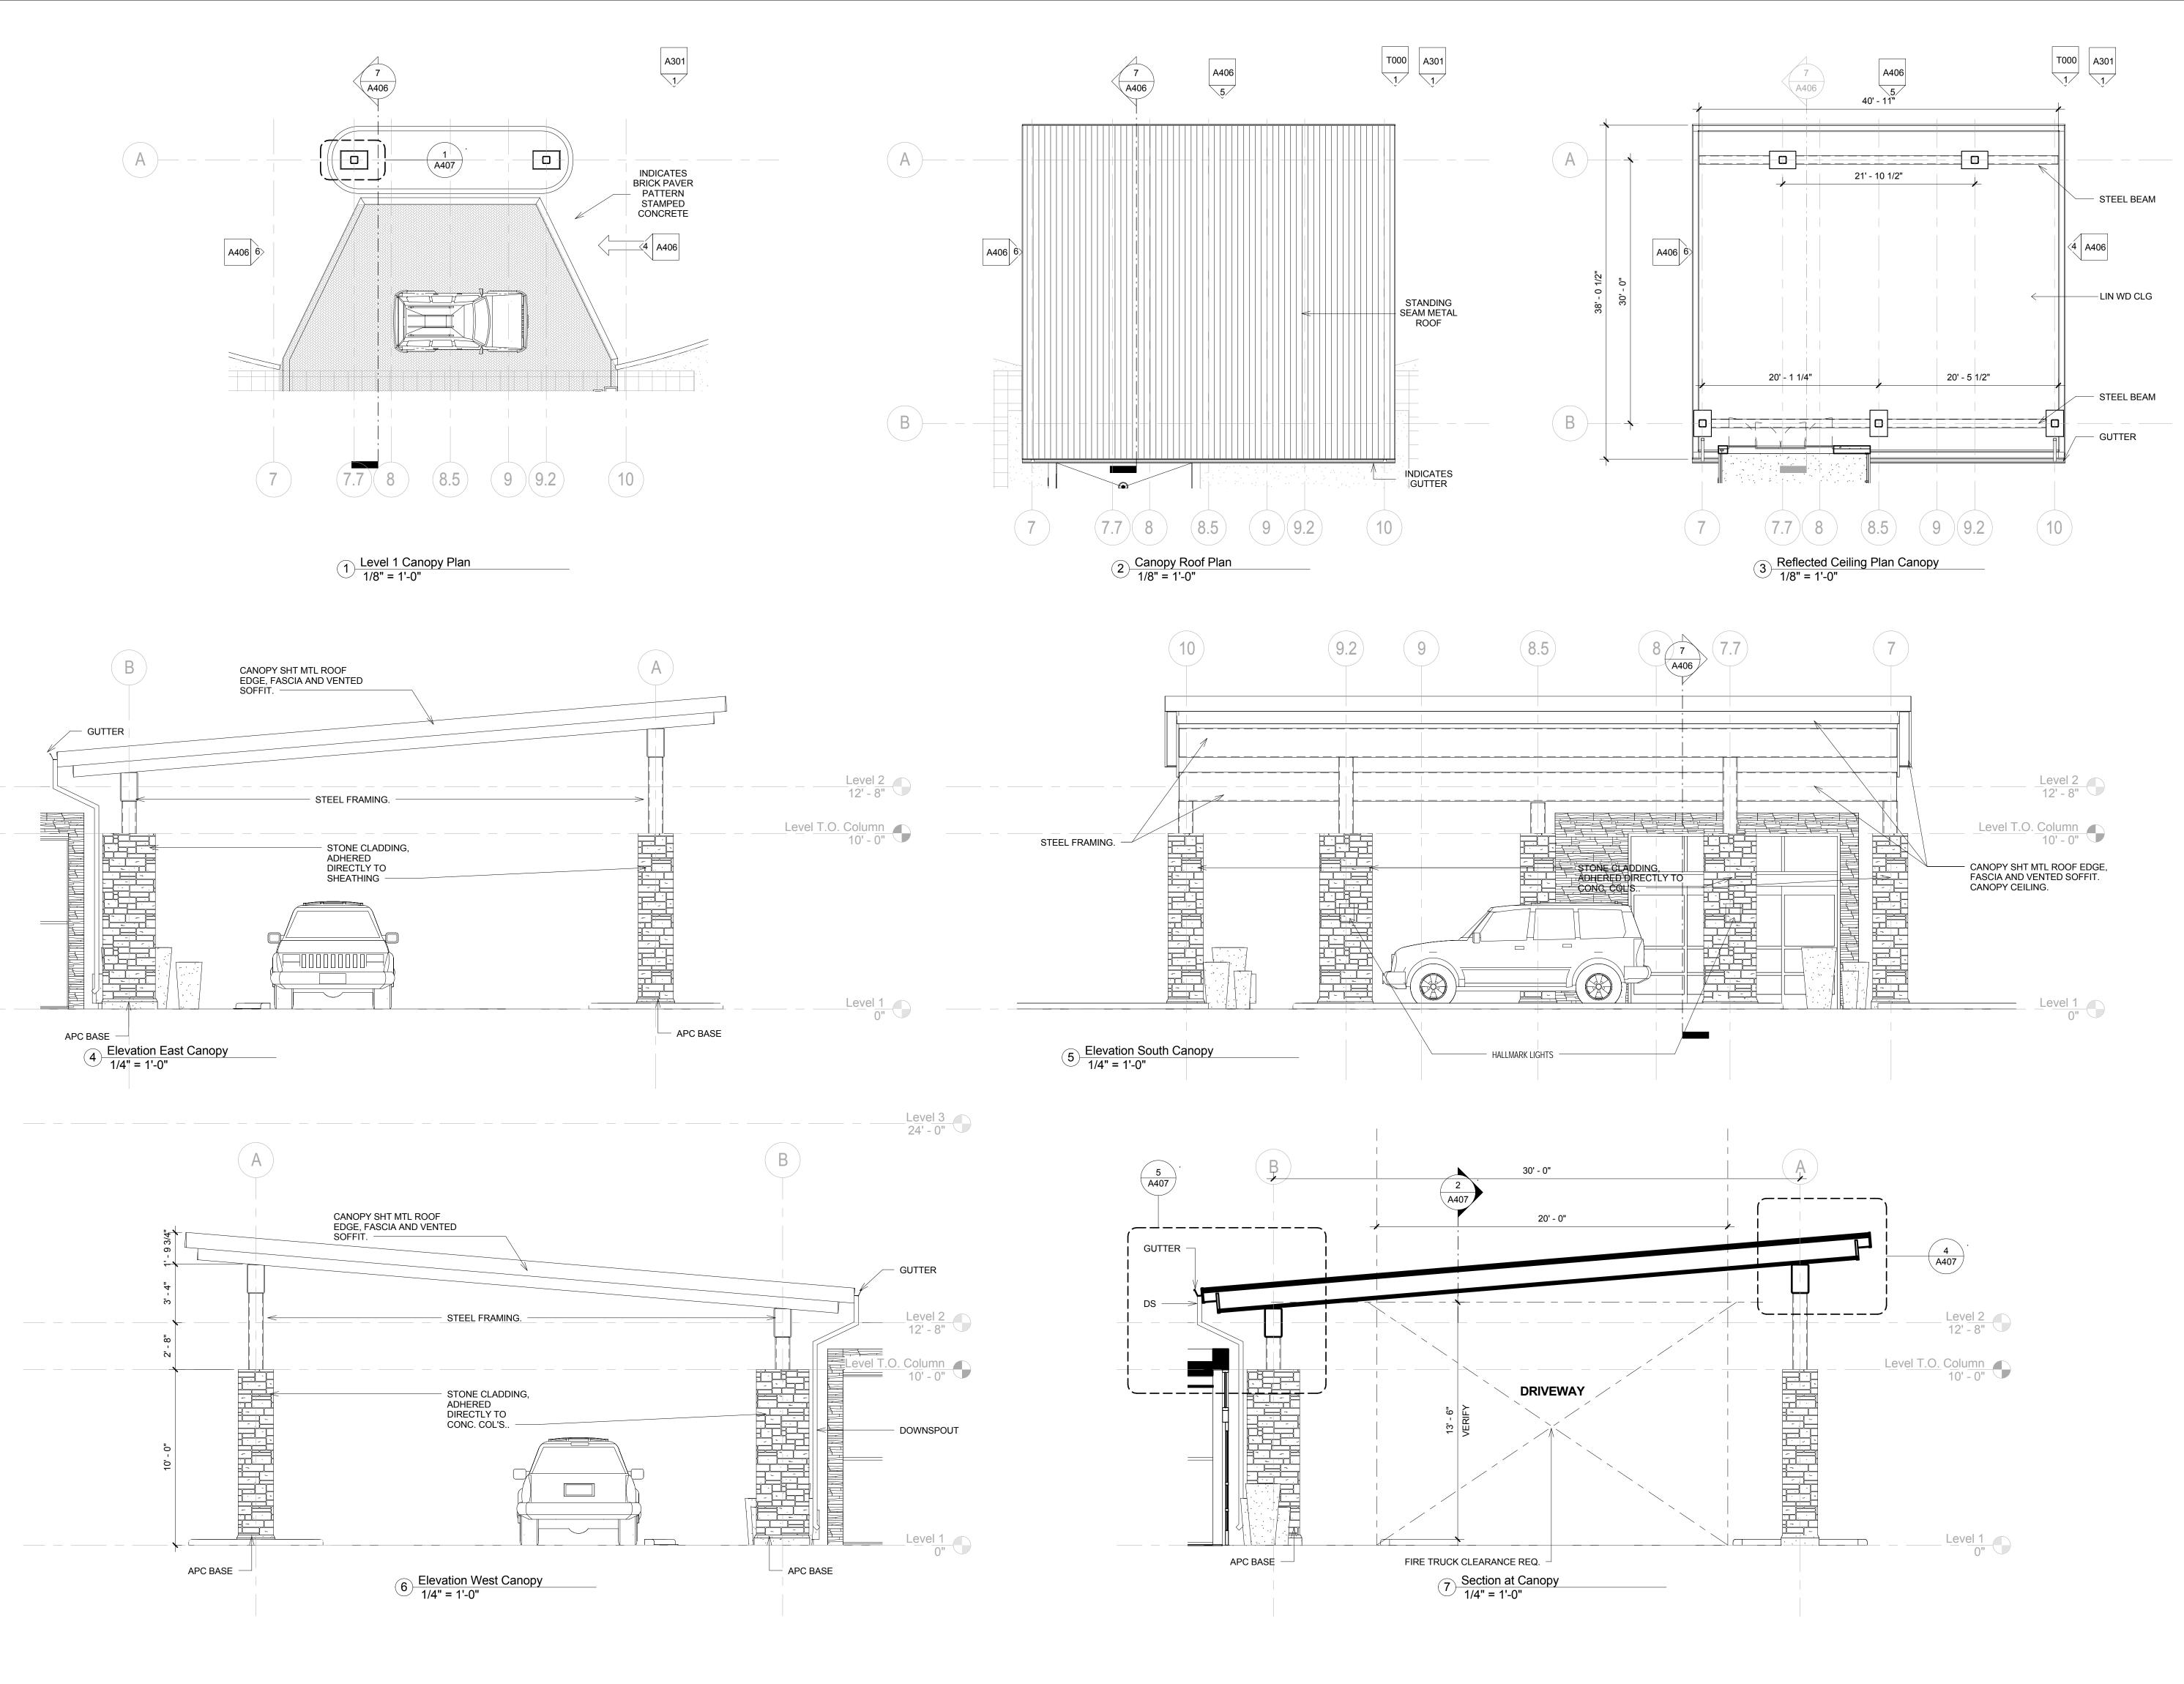
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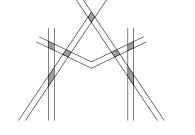
Phase
Construction Documents

Project No. 14-081 Sheet No.

Prepared by Author
Checked by Checker
Date Feb. 27, 2015





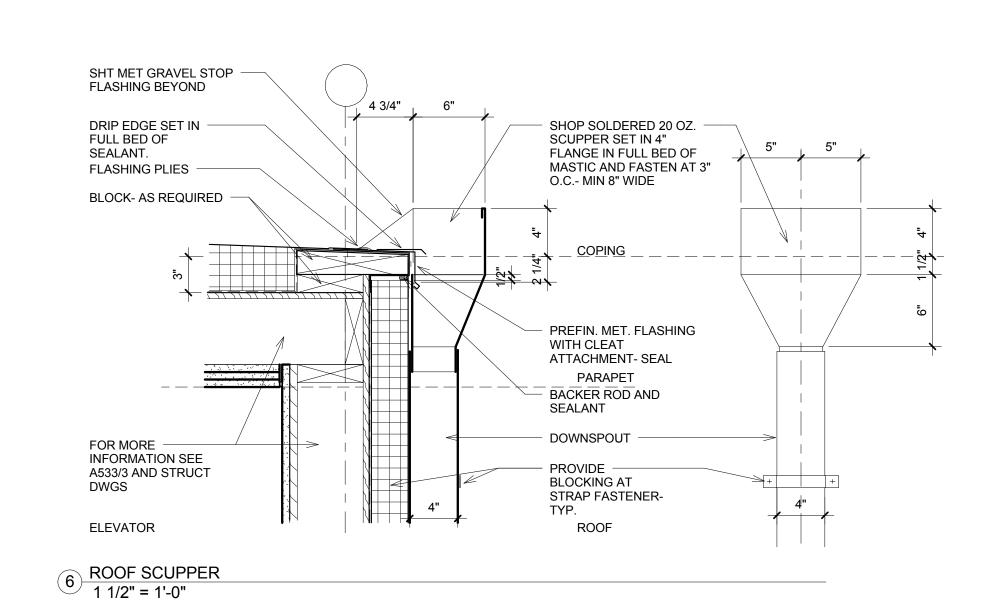

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KEY PLAN

Shiva Southaven Inc.

Holiday Inn Express & Suites

Lot 16 (Rev Lot 3) Southcrest Pkwy. Southcrest Subdivision Southaven, MS 38671

Drawing Title
Canopy Details


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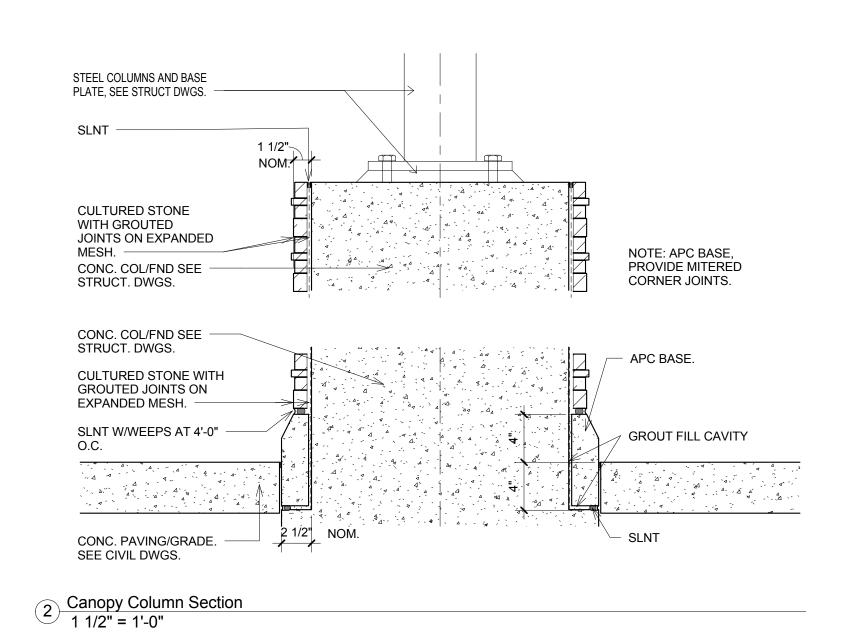
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Prepared by Author
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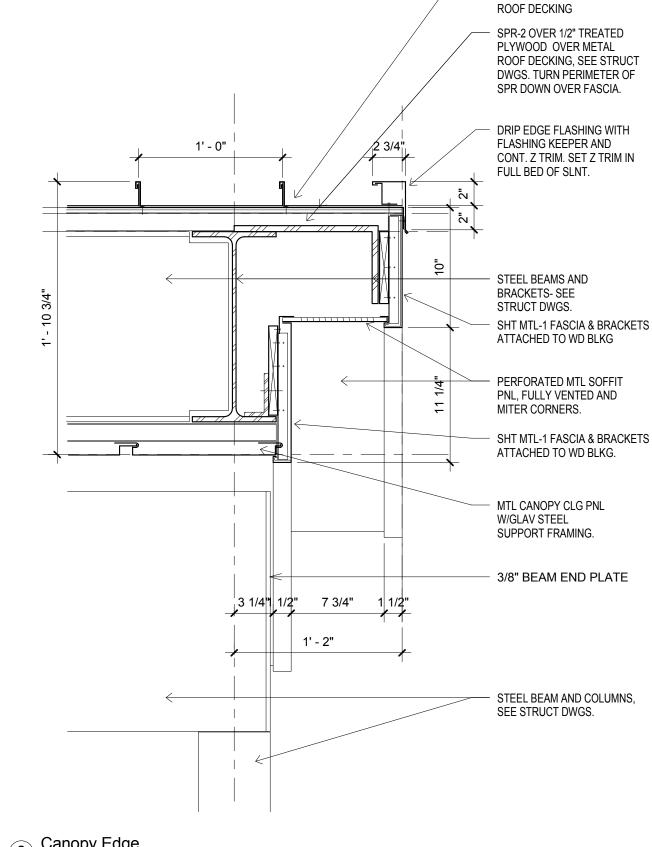
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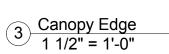
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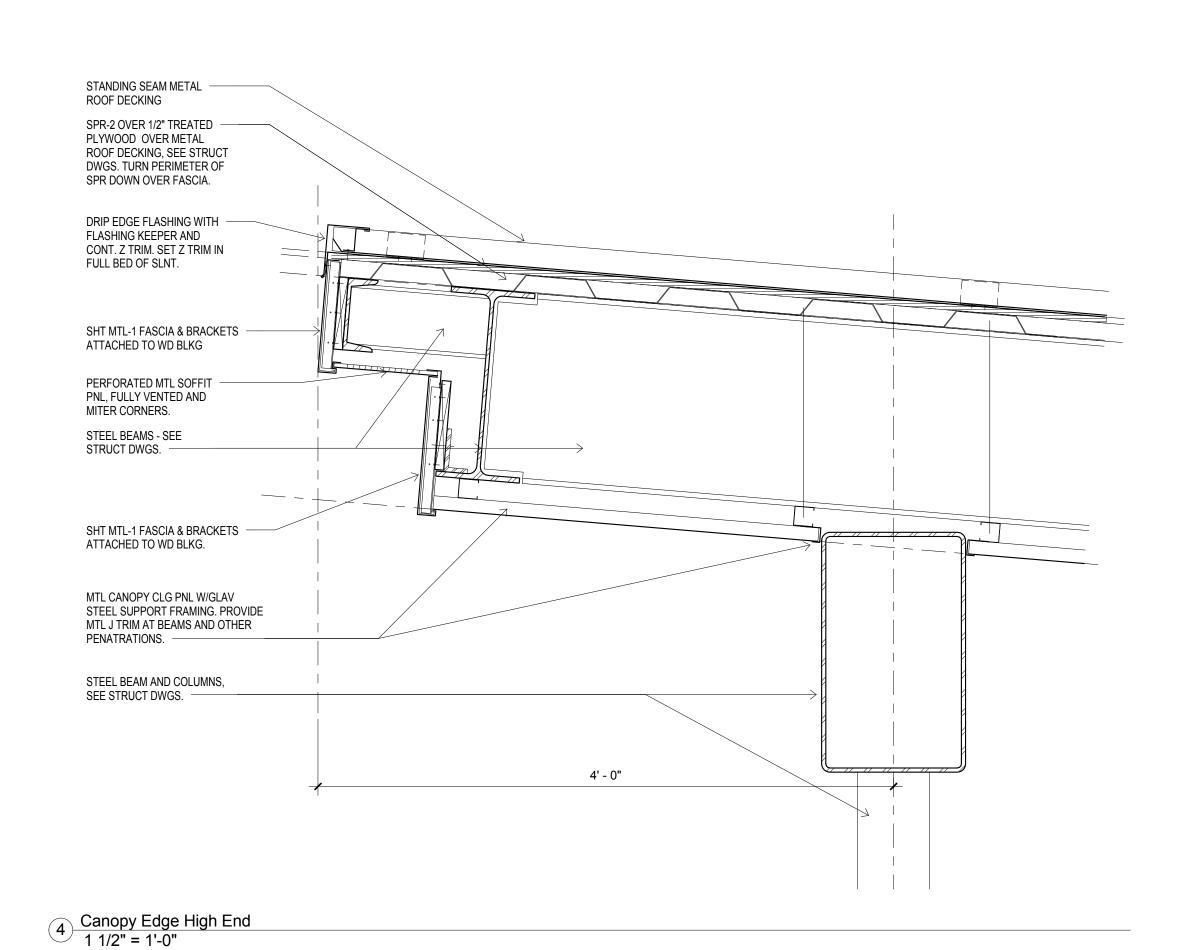







STANDING SEAM METAL



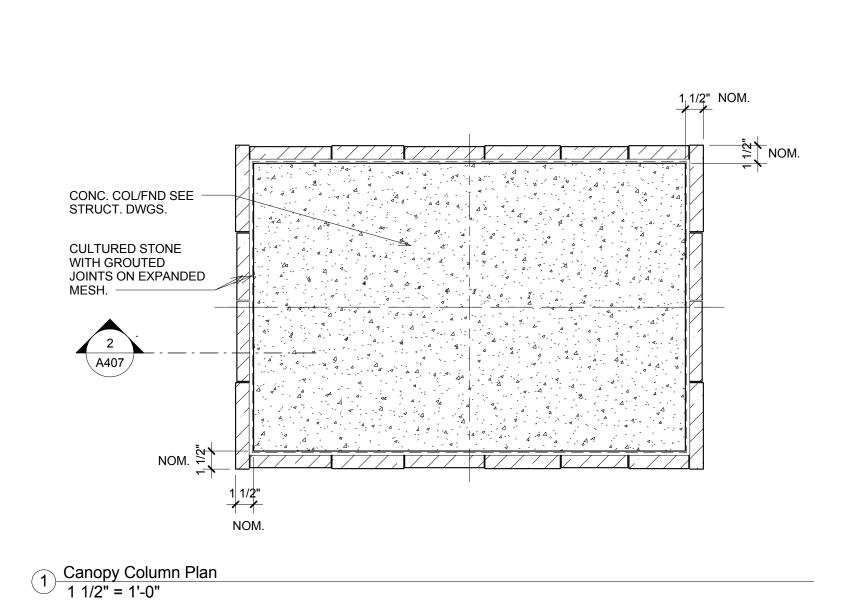

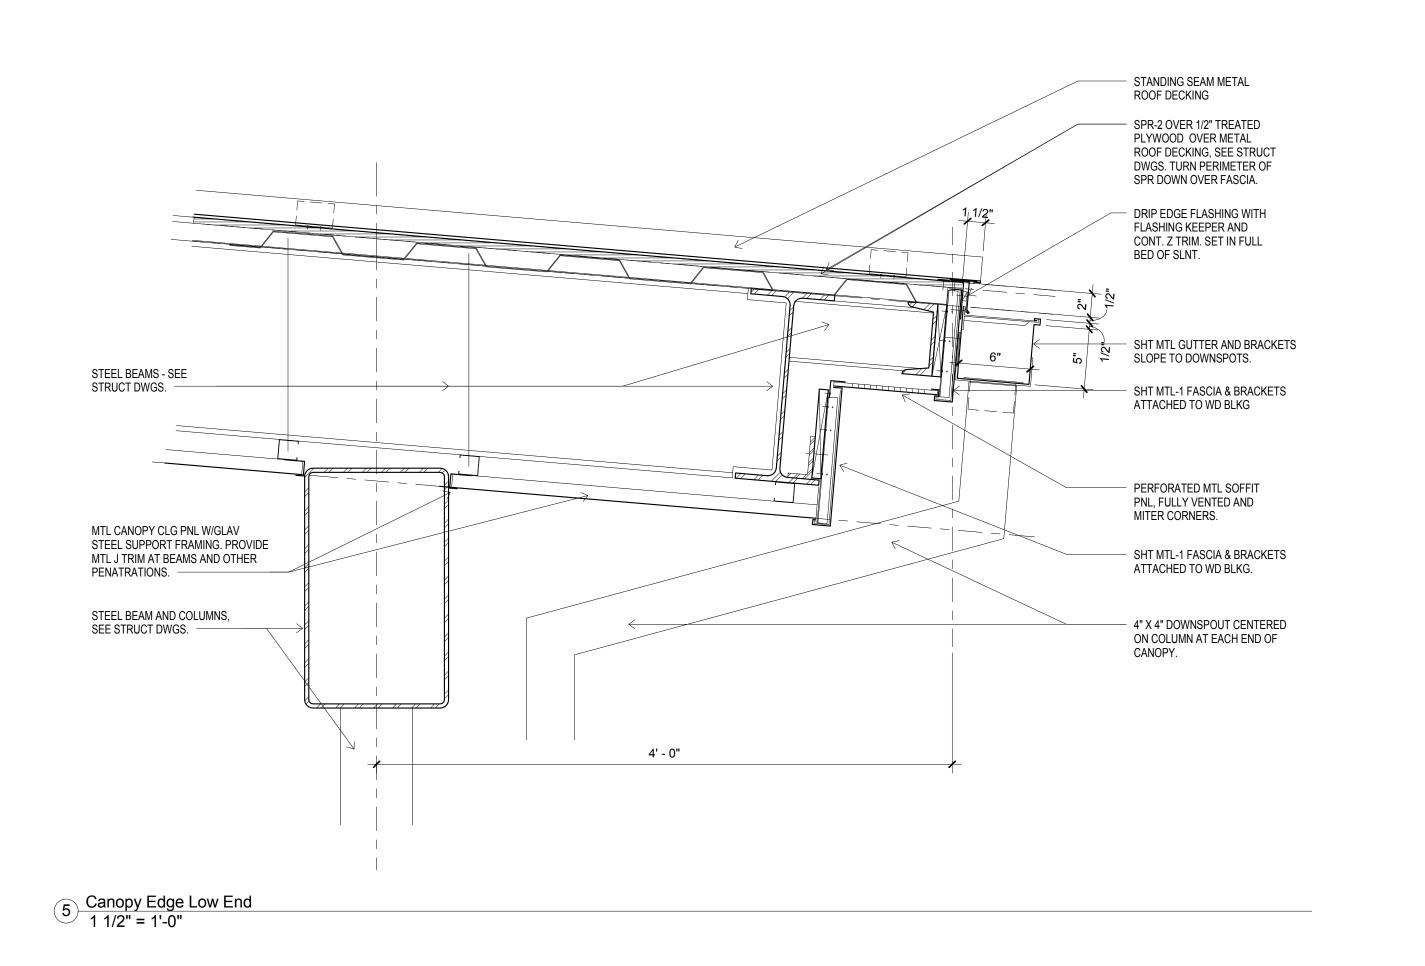

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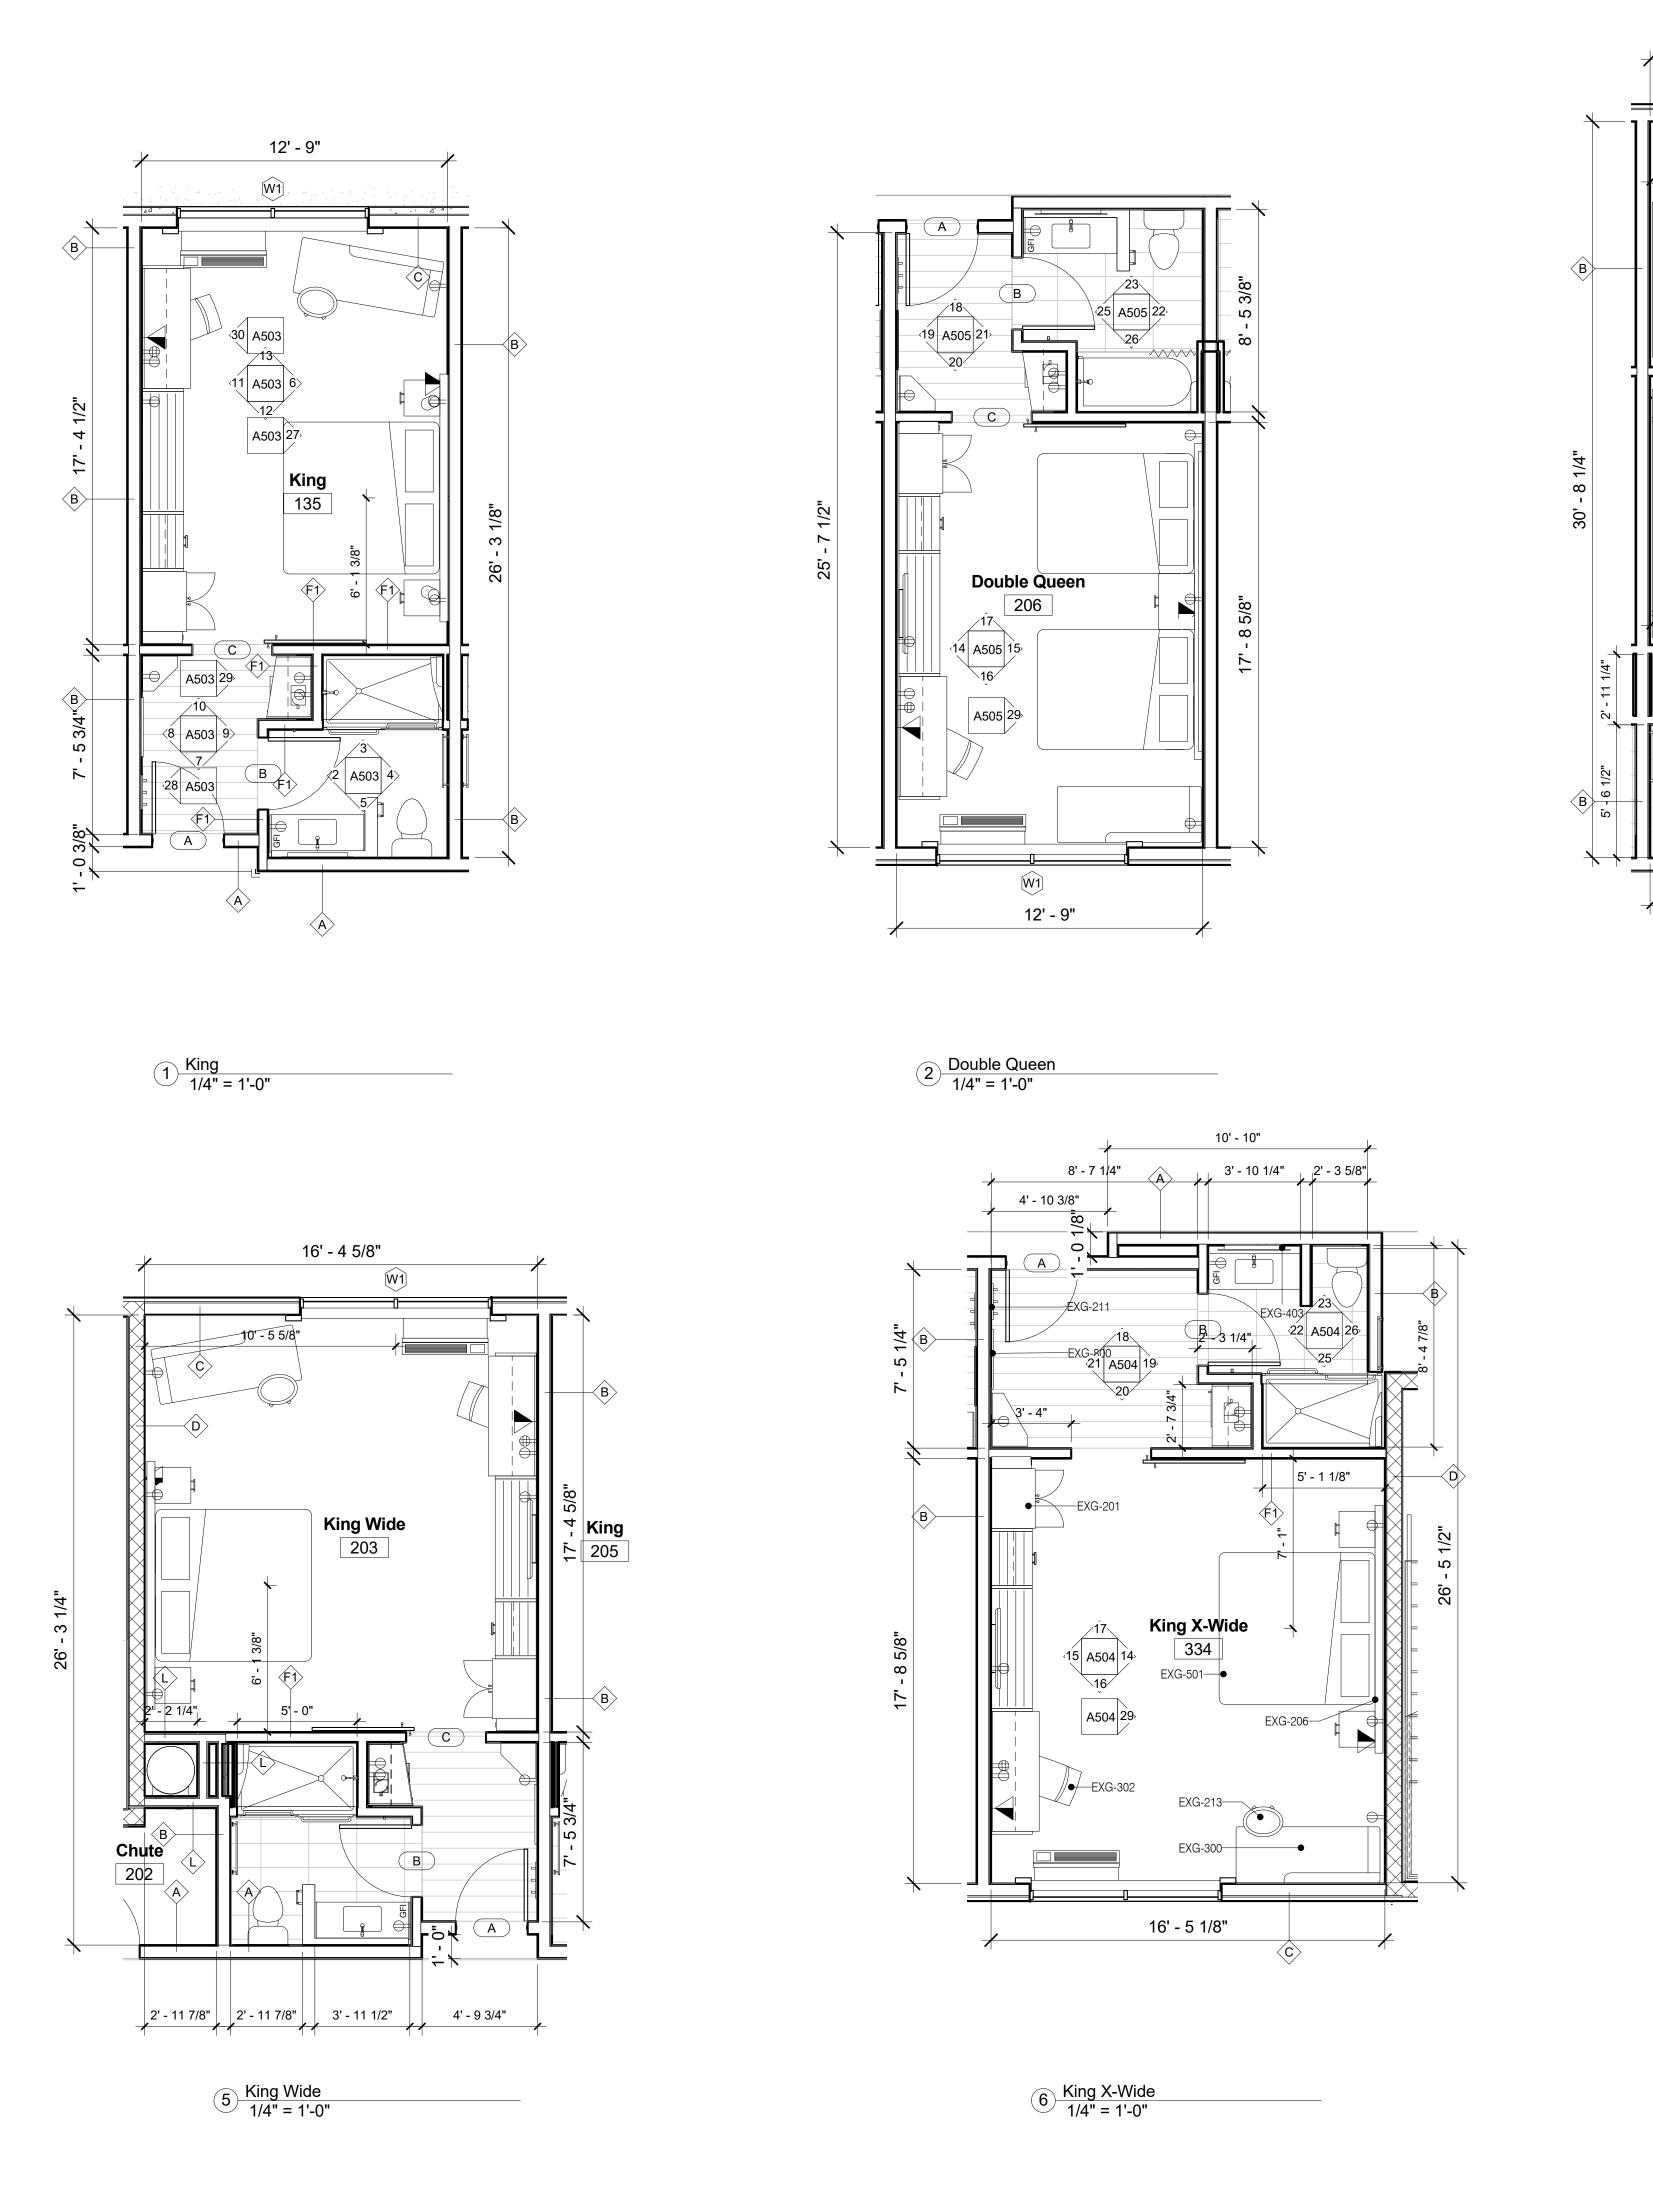
Shiva Southaven Inc.


Holiday Inn Express & Suites

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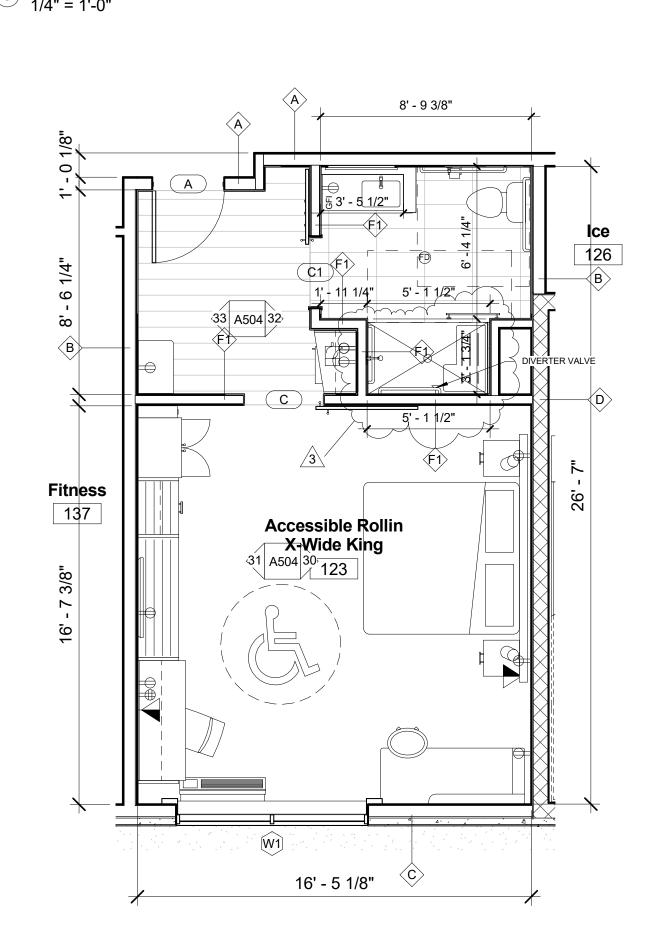
Drawing Title Canopy Details

Construction Documents 14-081 Sheet No. Project No. Prepared by Author Checked by Checker Date Feb. 27, 2015



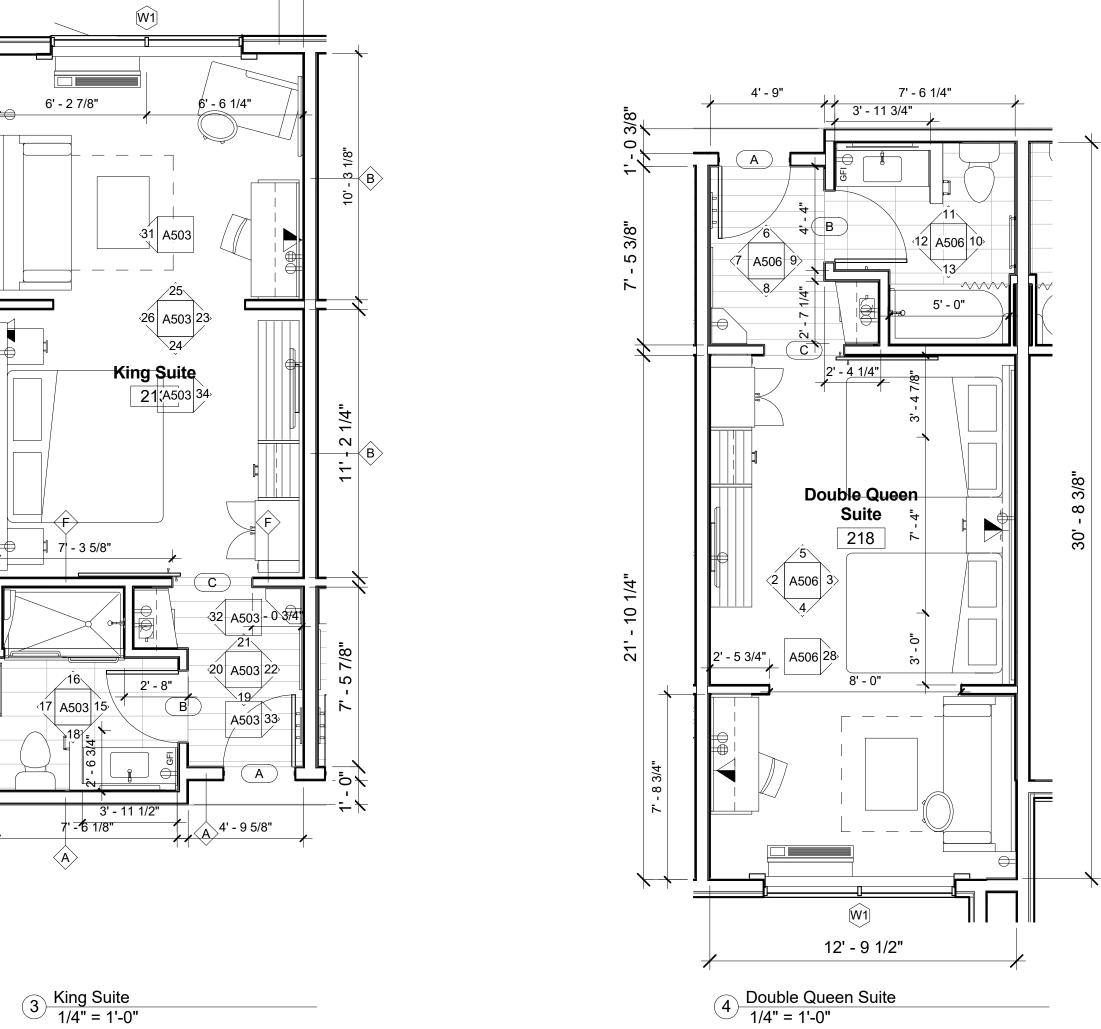

12' - 9 1/4"




7 Accessible Rollin X-Wide King
1/4" = 1'-0"

1. PROVIDE BLOCKING IN WALL IN ALL ROOMS TO FASTEN LCD T.V., PICTURE FRAMES, HEAD BOARDS, BEHIND ENTRY AND BATHROOM DOORS, ABOVE LUGGAGE RACK, COAT HANGERS, ROOM MIRROR, DRAPERY RODS, BUILT-IN TABLE, IRON BOARD HANGER, TOWEL RODS, SHOWER RODS, TOILET PAPER HOLDERS, TOWEL RACK, HANDRAIL IN BATH TUBS AND MAKEUP MIRROR. COORDINATE WITH OWNER FOR HEIGHTS AND SIZES OF FFE ITEMS AND LOCATION AND HEIGHTS OF SWITCHES, OUTLETS, LIGHT FIXTURE IN ROOMS.

. TOURT LIGHT COONCES TO BE @ 51.011 A.F.

2. TOILET LIGHT SCONCES TO BE @ 5'-6" A.F.F.3. PROVIDE SILICON-BASED CAULKING AT ALL THE EDGES OF WALL PAPER TO AVOID ANY FUTURE PEALING OF

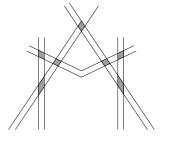

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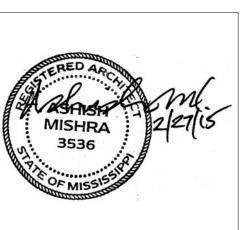
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REVISIONS		
No.	Date	Description
3	3/18/16	ADA Showers

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KEY PLAN

Shiva Southaven Inc.

Holiday Inn Express & Suites

Lot 16 (Rev Lot 3) Southcrest Pkwy. Southcrest Subdivision Southaven, MS 38671

Drawing Title

Room Layouts


Construction Documents

Project No. 14-081
Prepared by Author
Checked by Checker

A501

Date Feb. 27, 2015



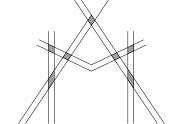

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REVISIONS		
No.	Date	Description
3	3/18/16	ADA Showers

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KEY PLAN

Shiva Southaven Inc.


Holiday Inn Express & Suites


Lot 16 (Rev Lot 3) Southcrest Pkwy. Southcrest Subdivision Southaven, MS 38671


Drawing Title Room Layouts

Construction Documents 14-081 Sheet No. Project No. Prepared by Author Checked by Checker

Date Feb. 27, 2015

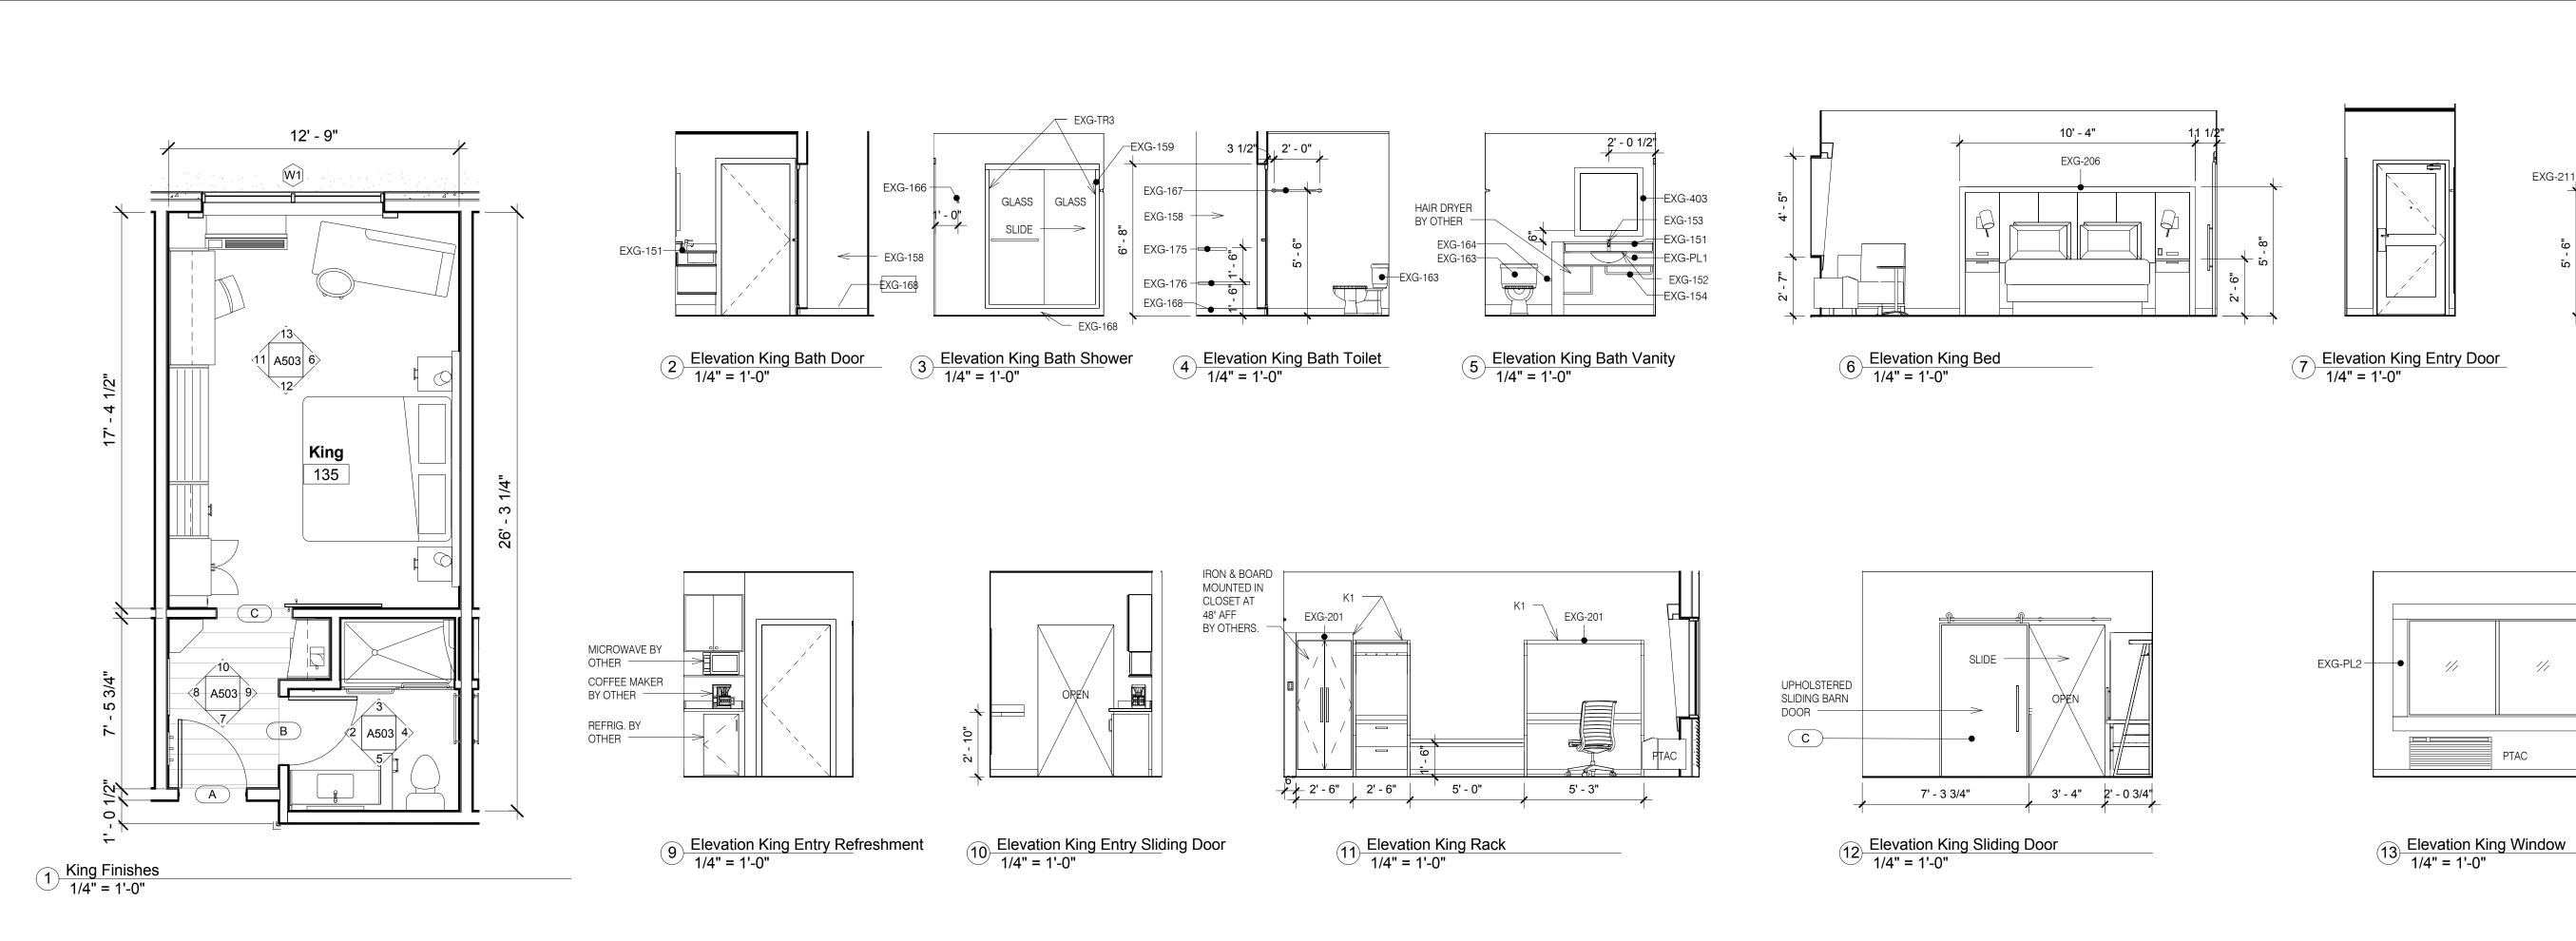

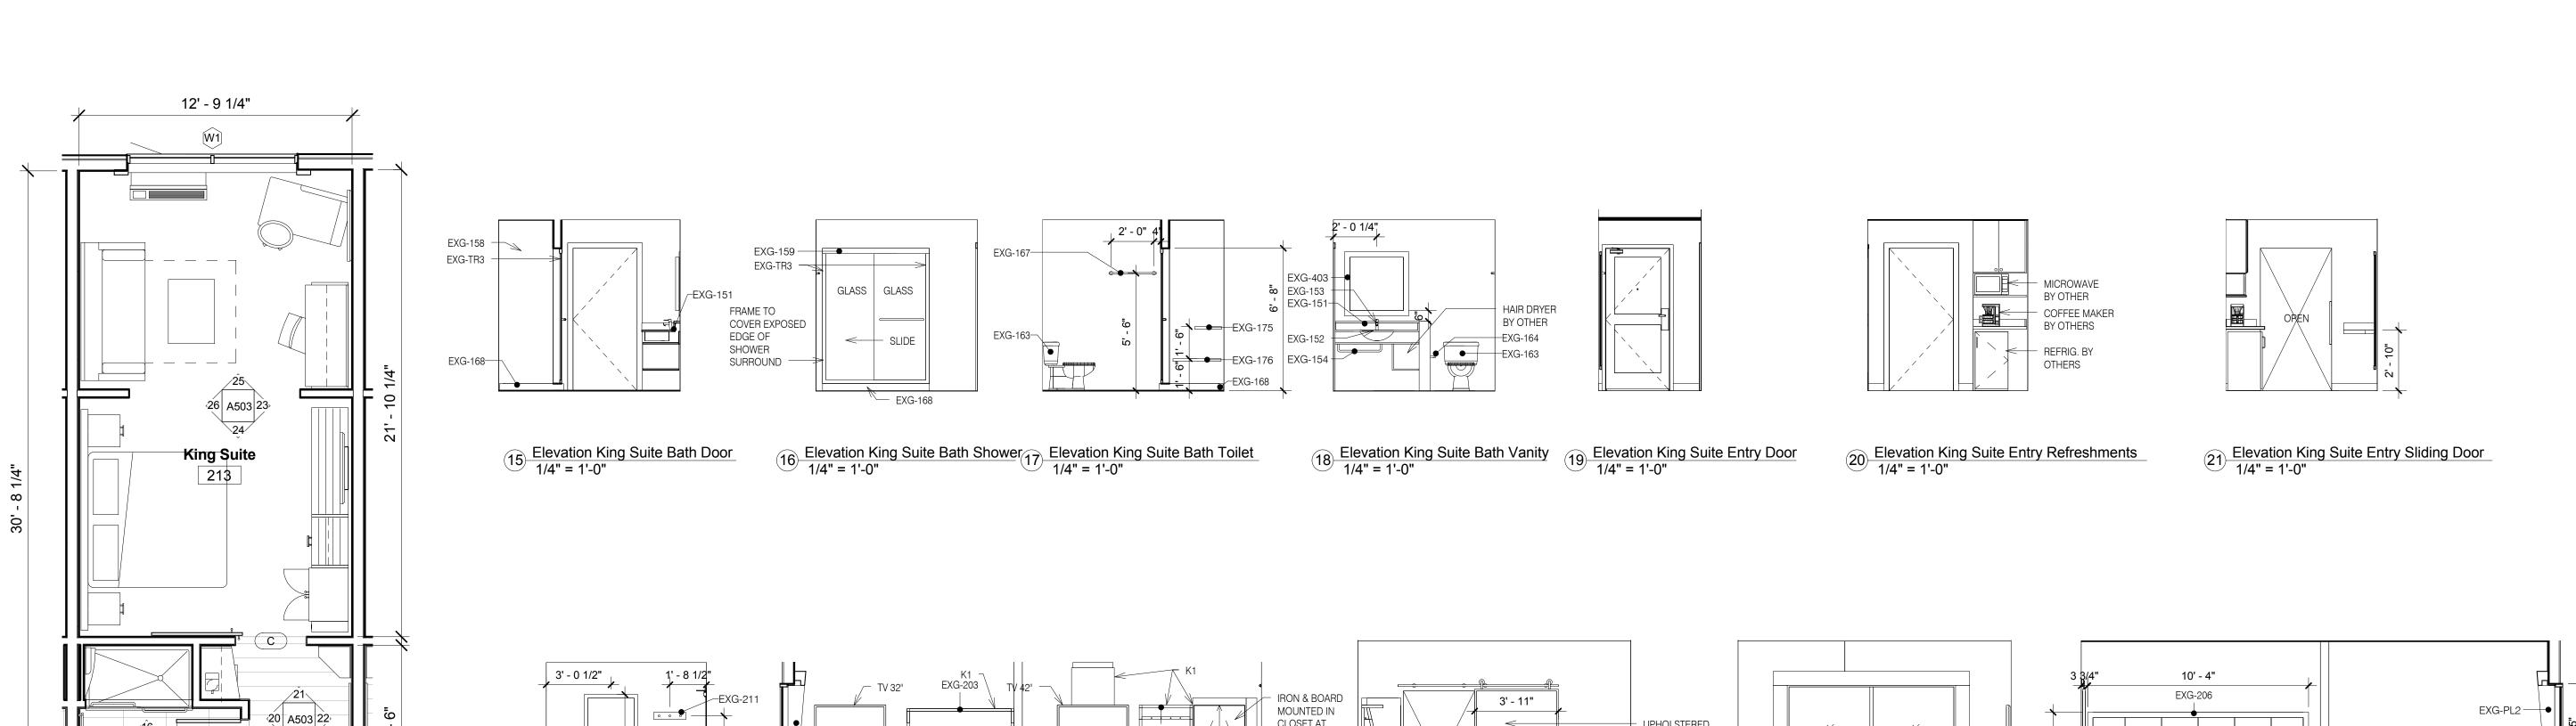

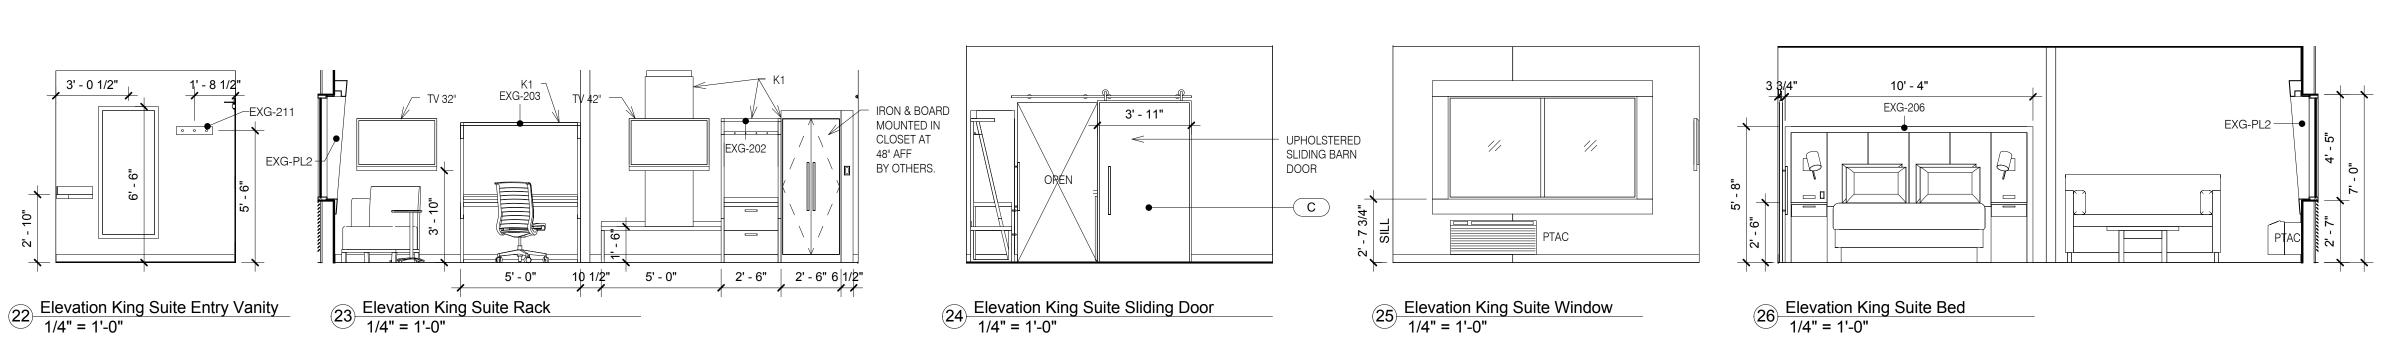



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EXG-800 -

8 Elevation King Entry Mirror 1/4" = 1'-0"

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No.	Date	Description
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**KEY PLAN** 

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Holiday Inn Express & Suites

Lot 16 (Rev Lot 3) Southcrest Pkwy. Southcrest Subdivision Southaven, MS 38671

Drawing Title King & King Suite


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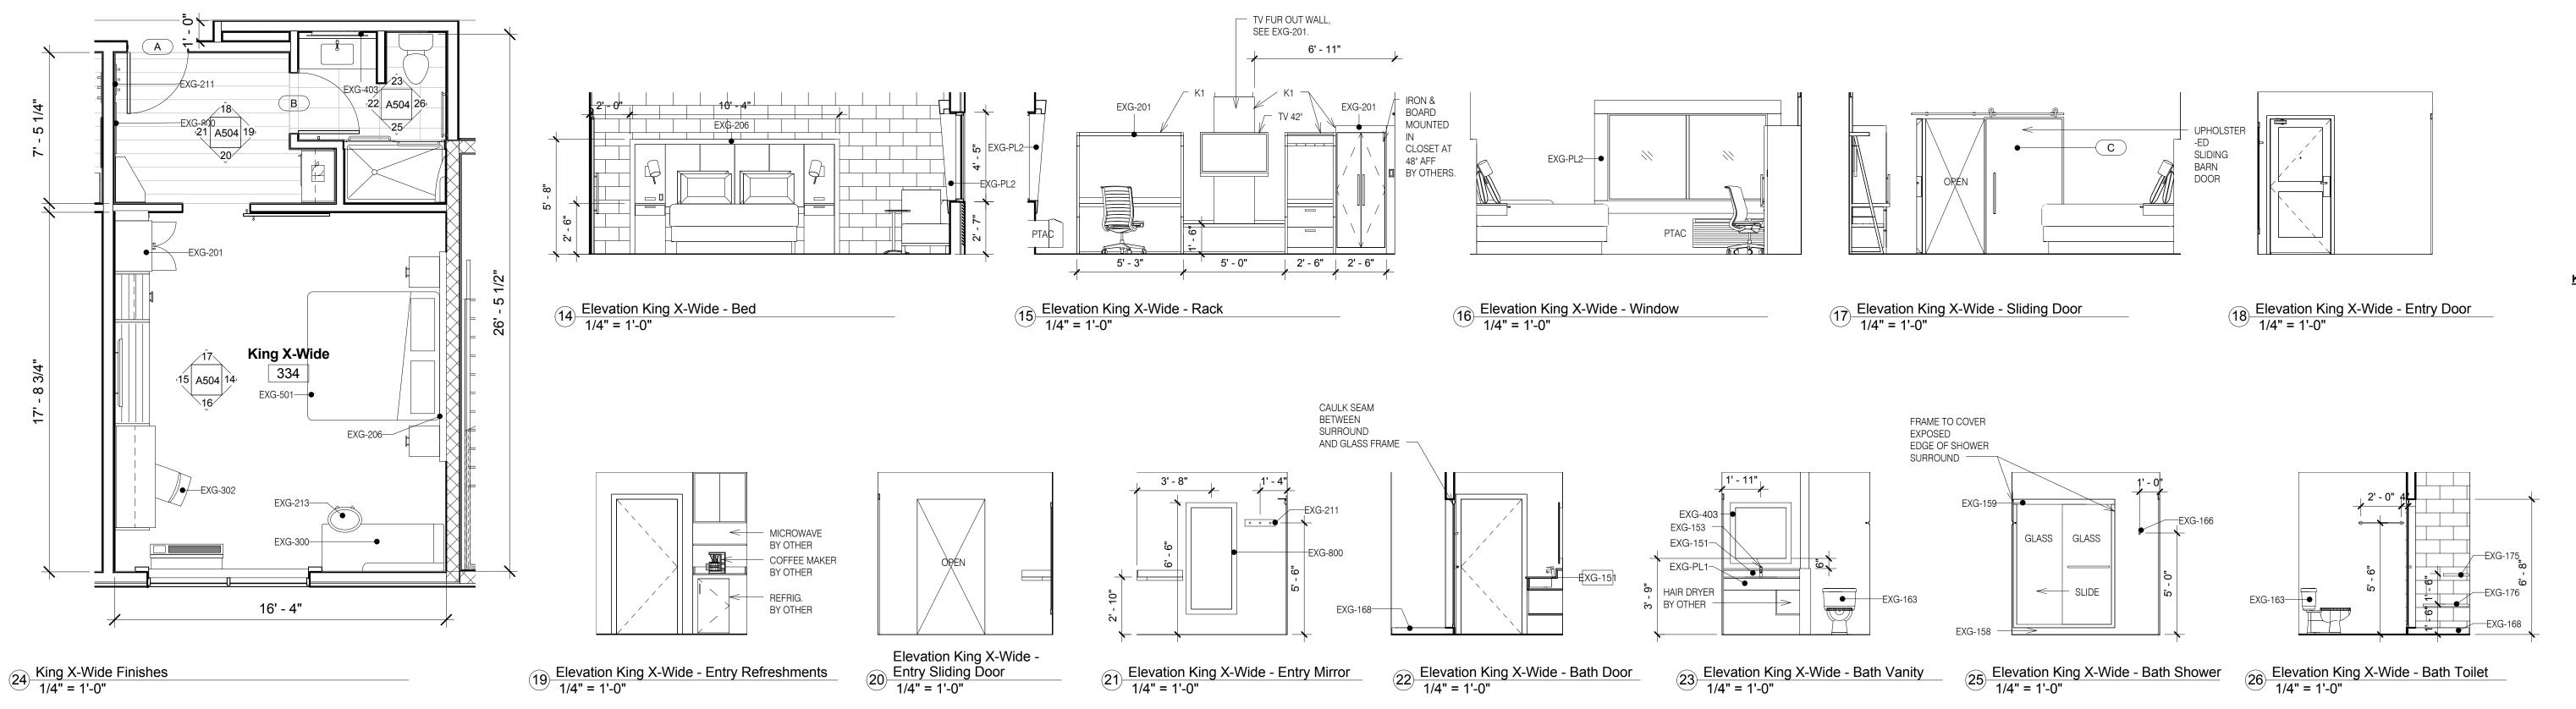
14-081 Sheet No. Project No. Prepared by Author A503 Checked by Checker Date Feb. <u>27</u>, 2015

Review

17 A503 15

King Suite Finishes
1/4" = 1'-0"



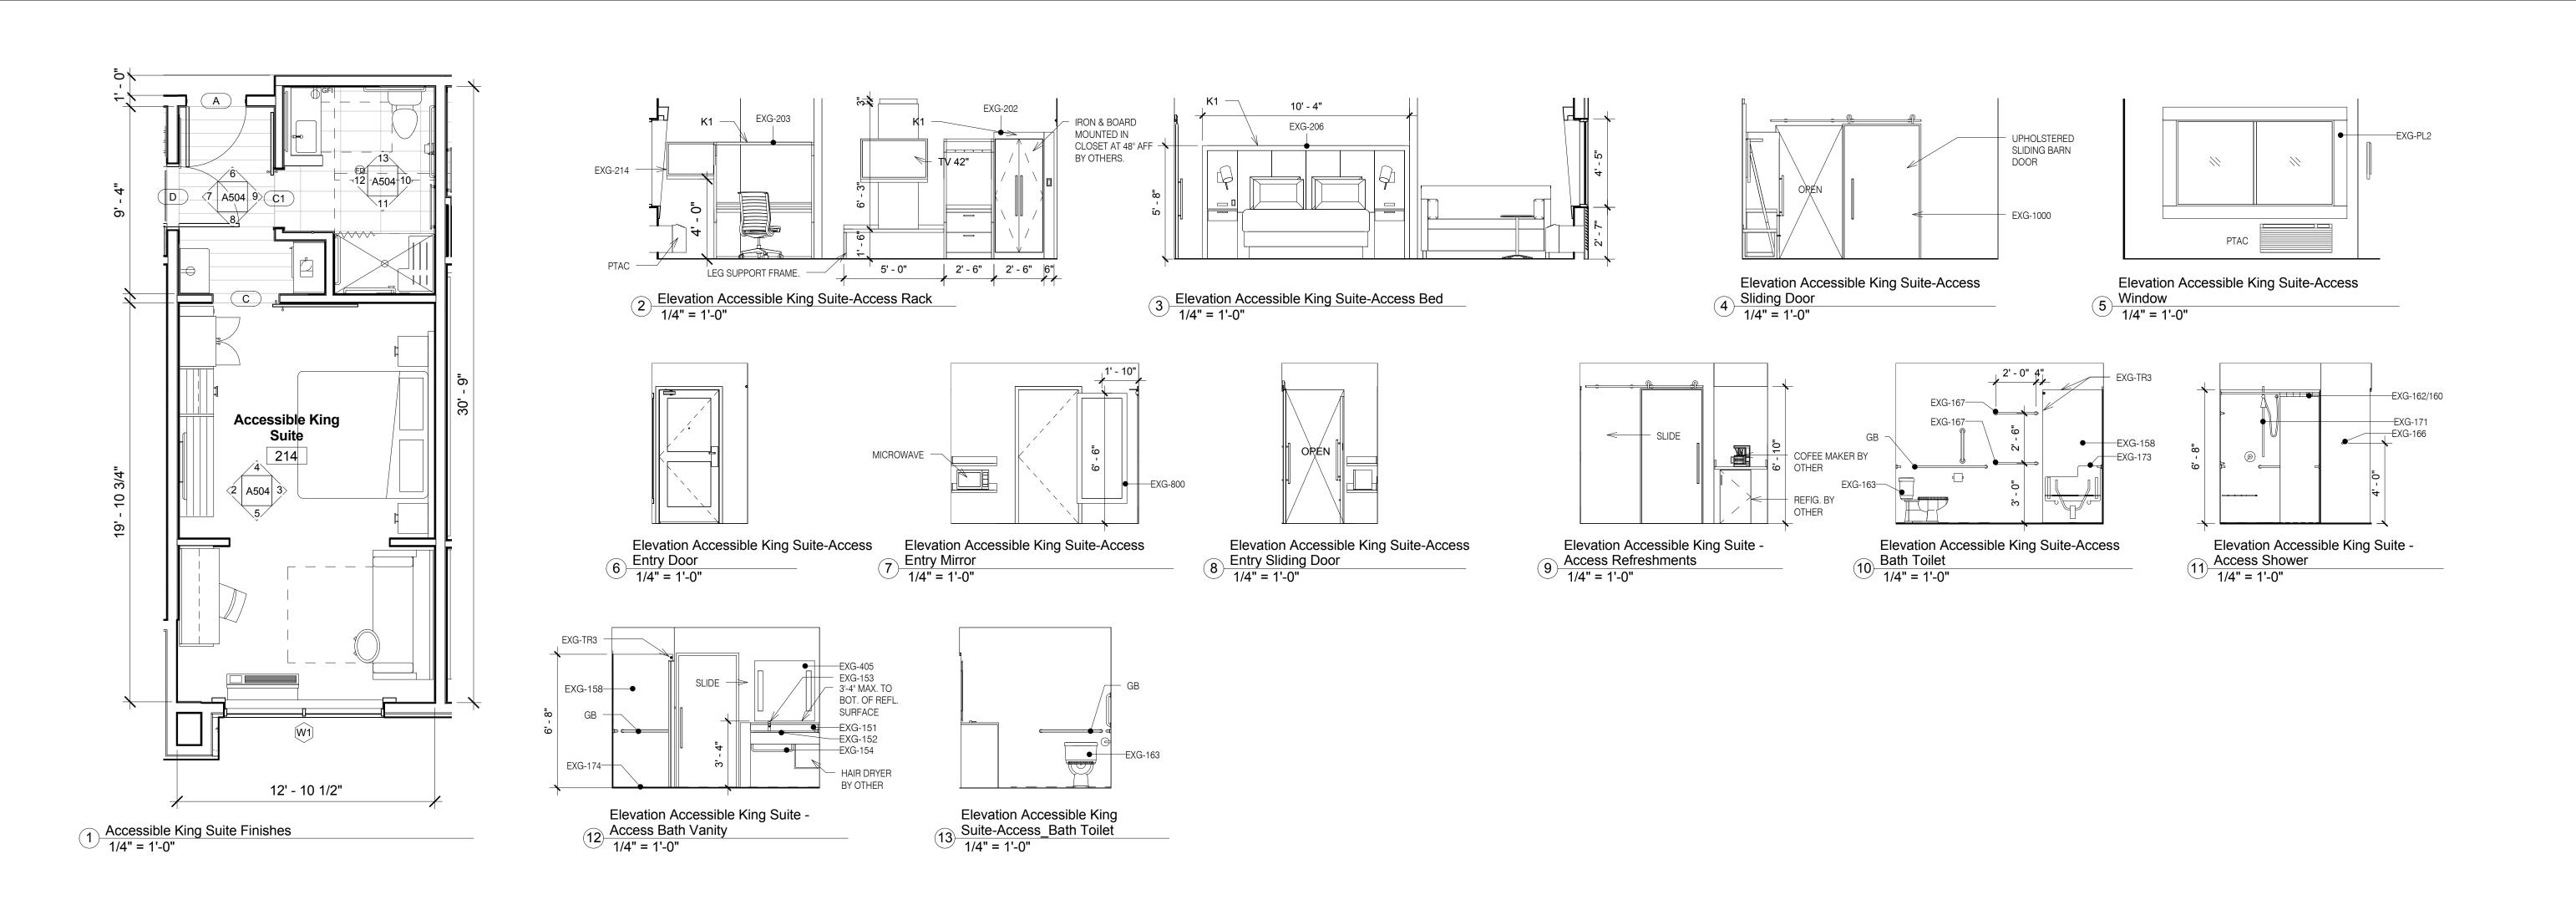



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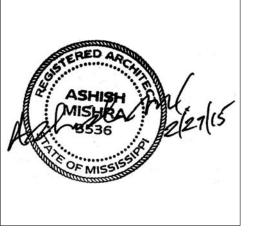
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Holiday Inn Express & Suites

Lot 16 (Rev Lot 3) Southcrest Pkwy. Southcrest Subdivision Southaven, MS 38671

Drawing Title


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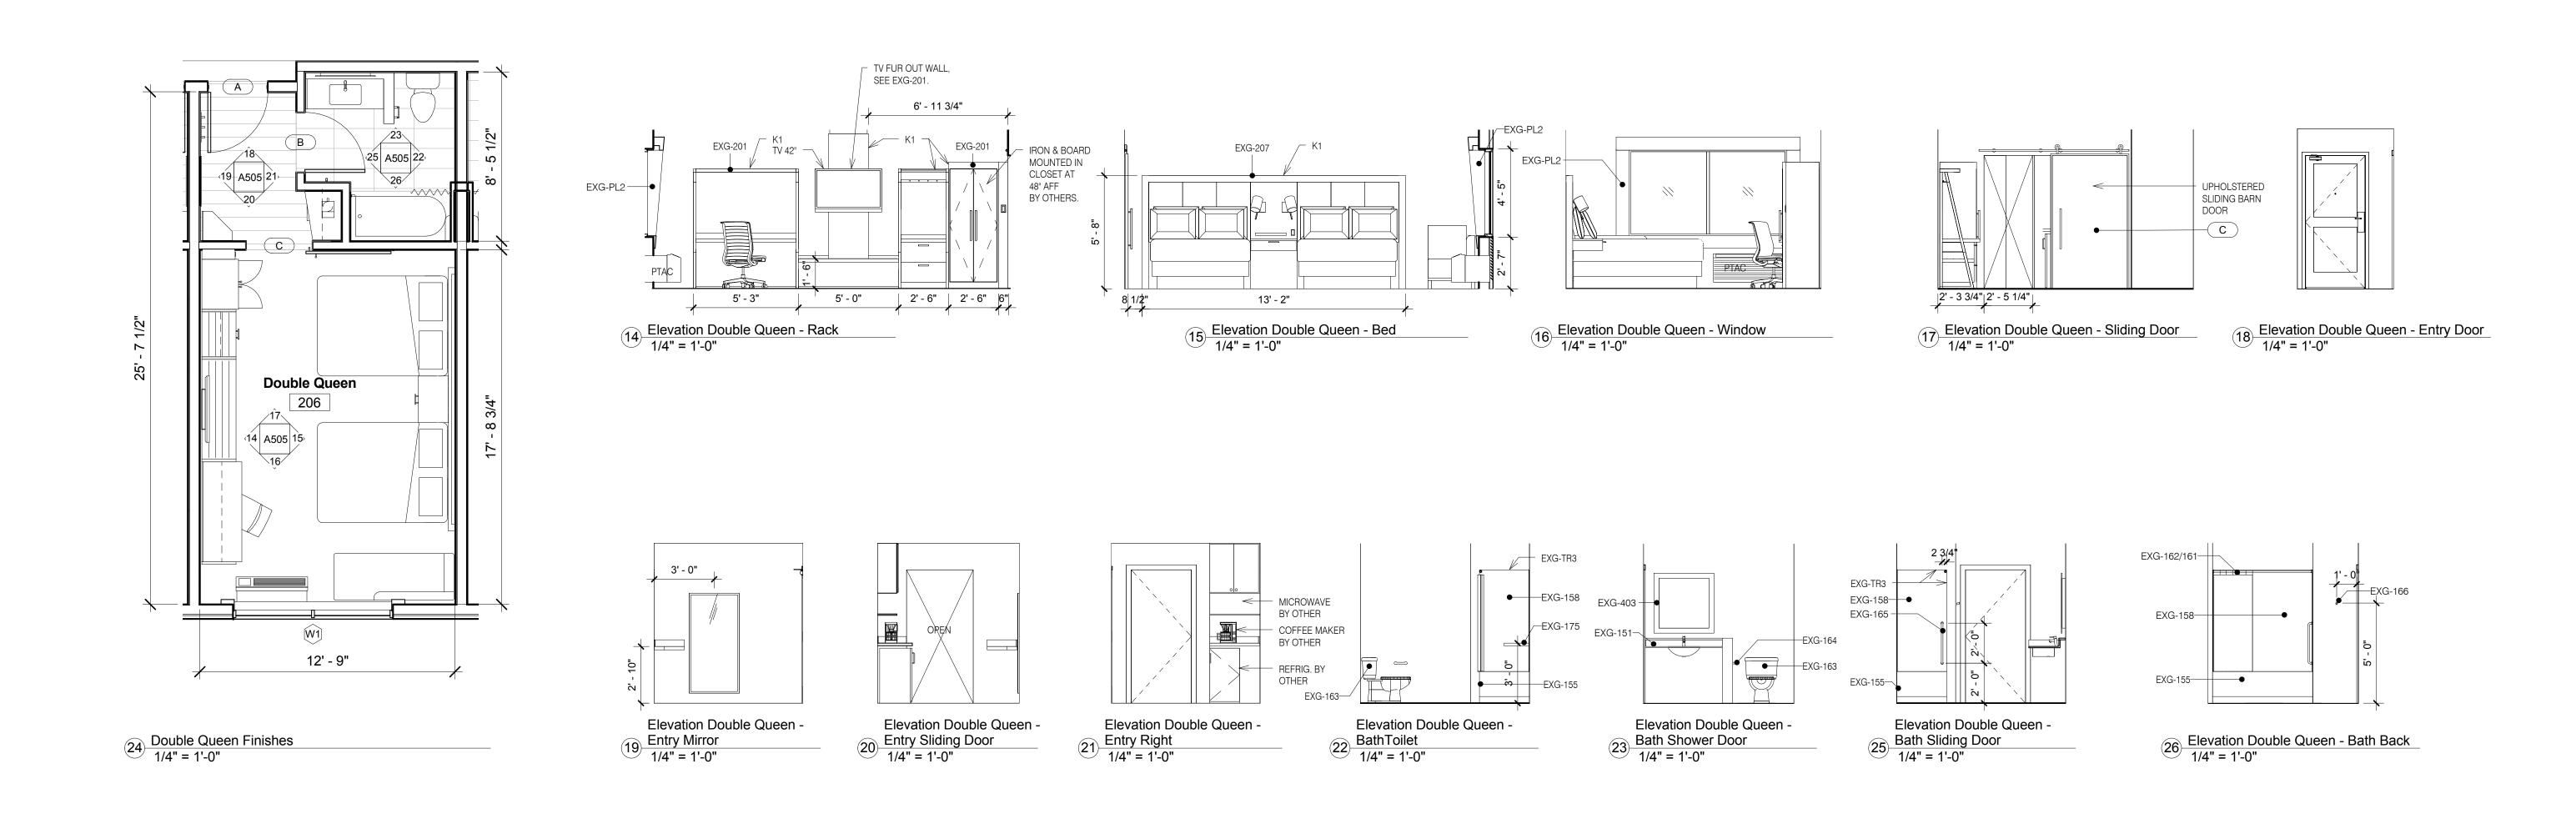
Project No. 14-081 Sheet No.

Project No. 14-081
Prepared by Author
Checked by Checker
Date Feb. 27, 2015

Sheet No.

A504



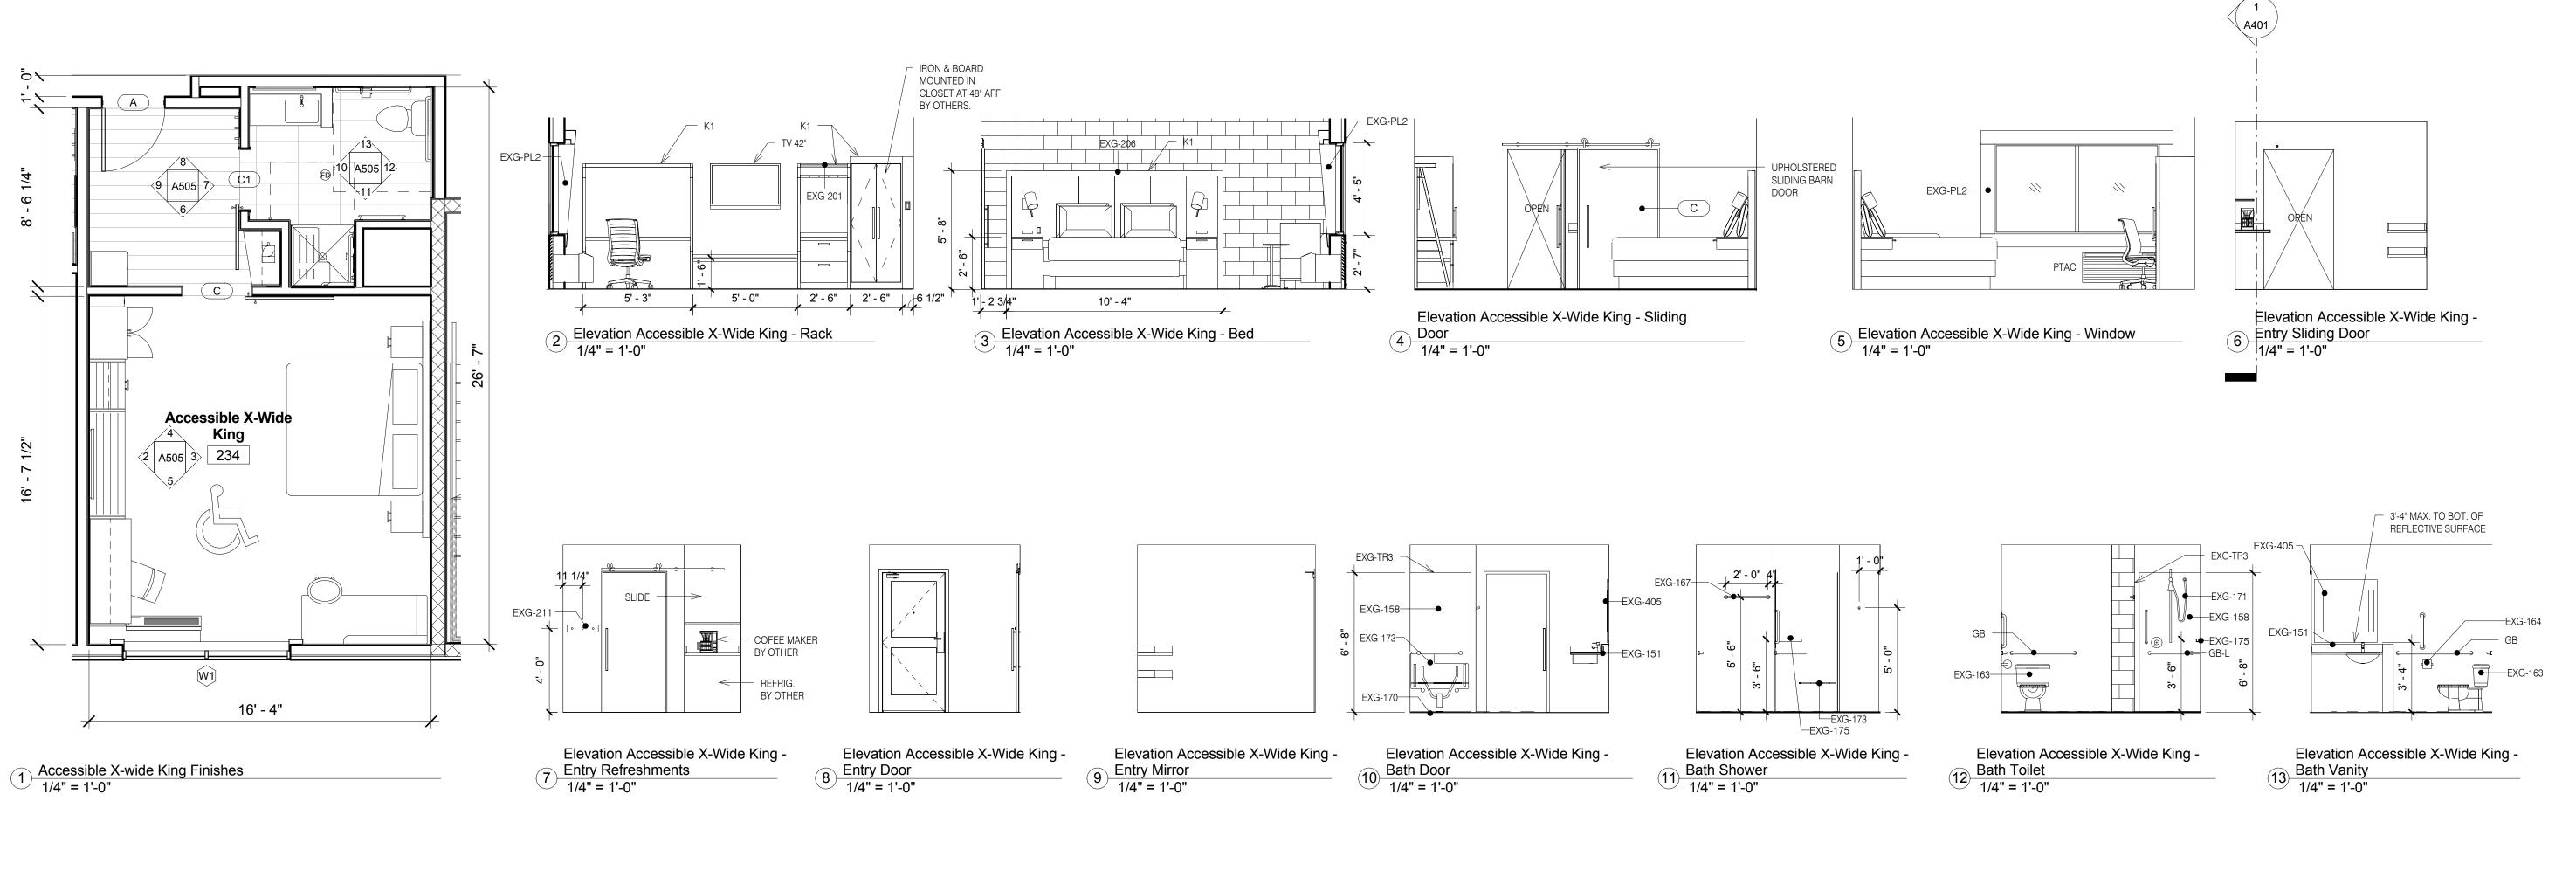



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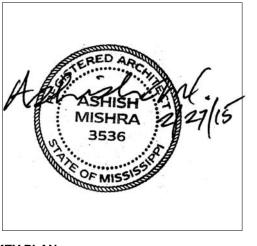
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KEY PLAN

Shiva Southaven Inc.

Holiday Inn Express & Suites


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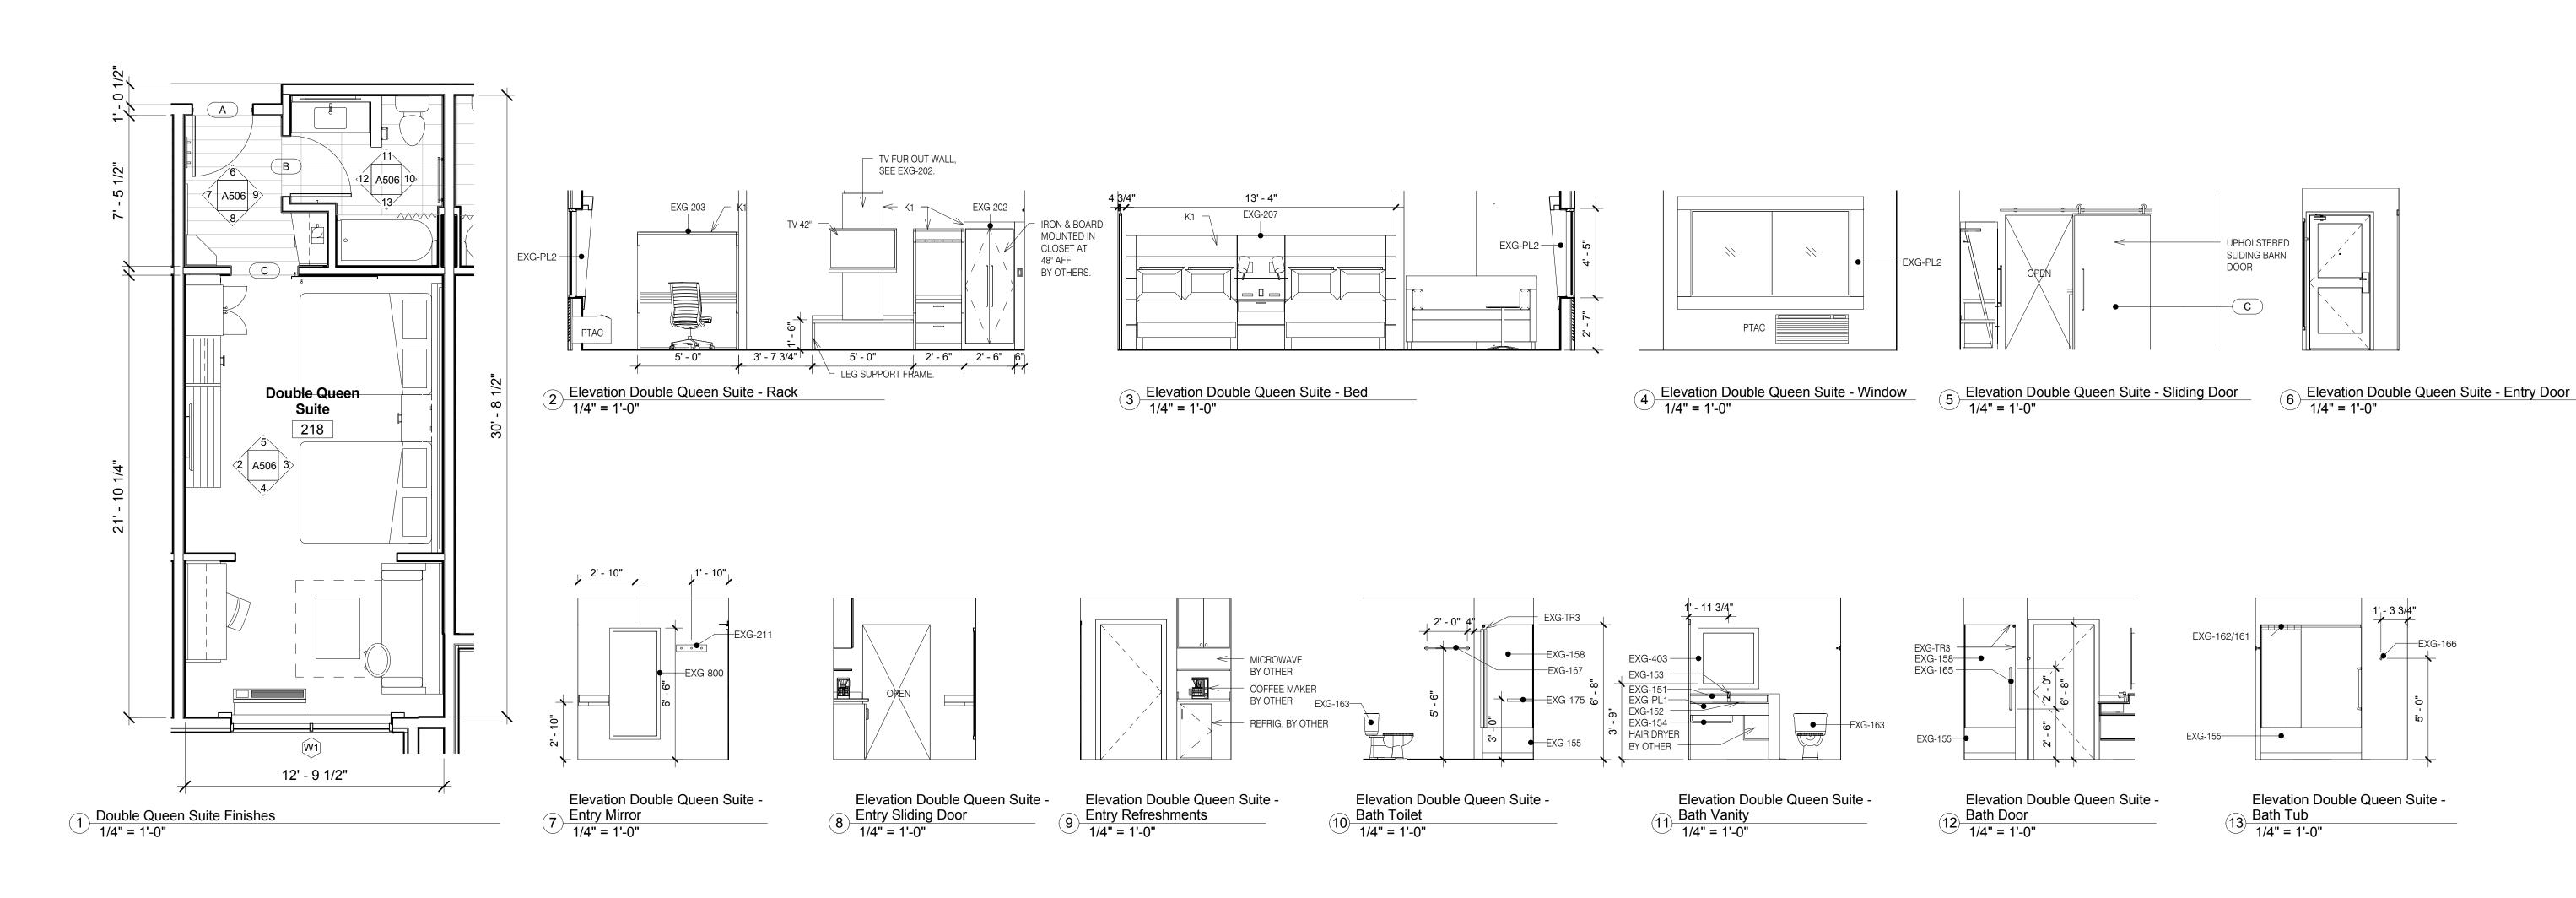
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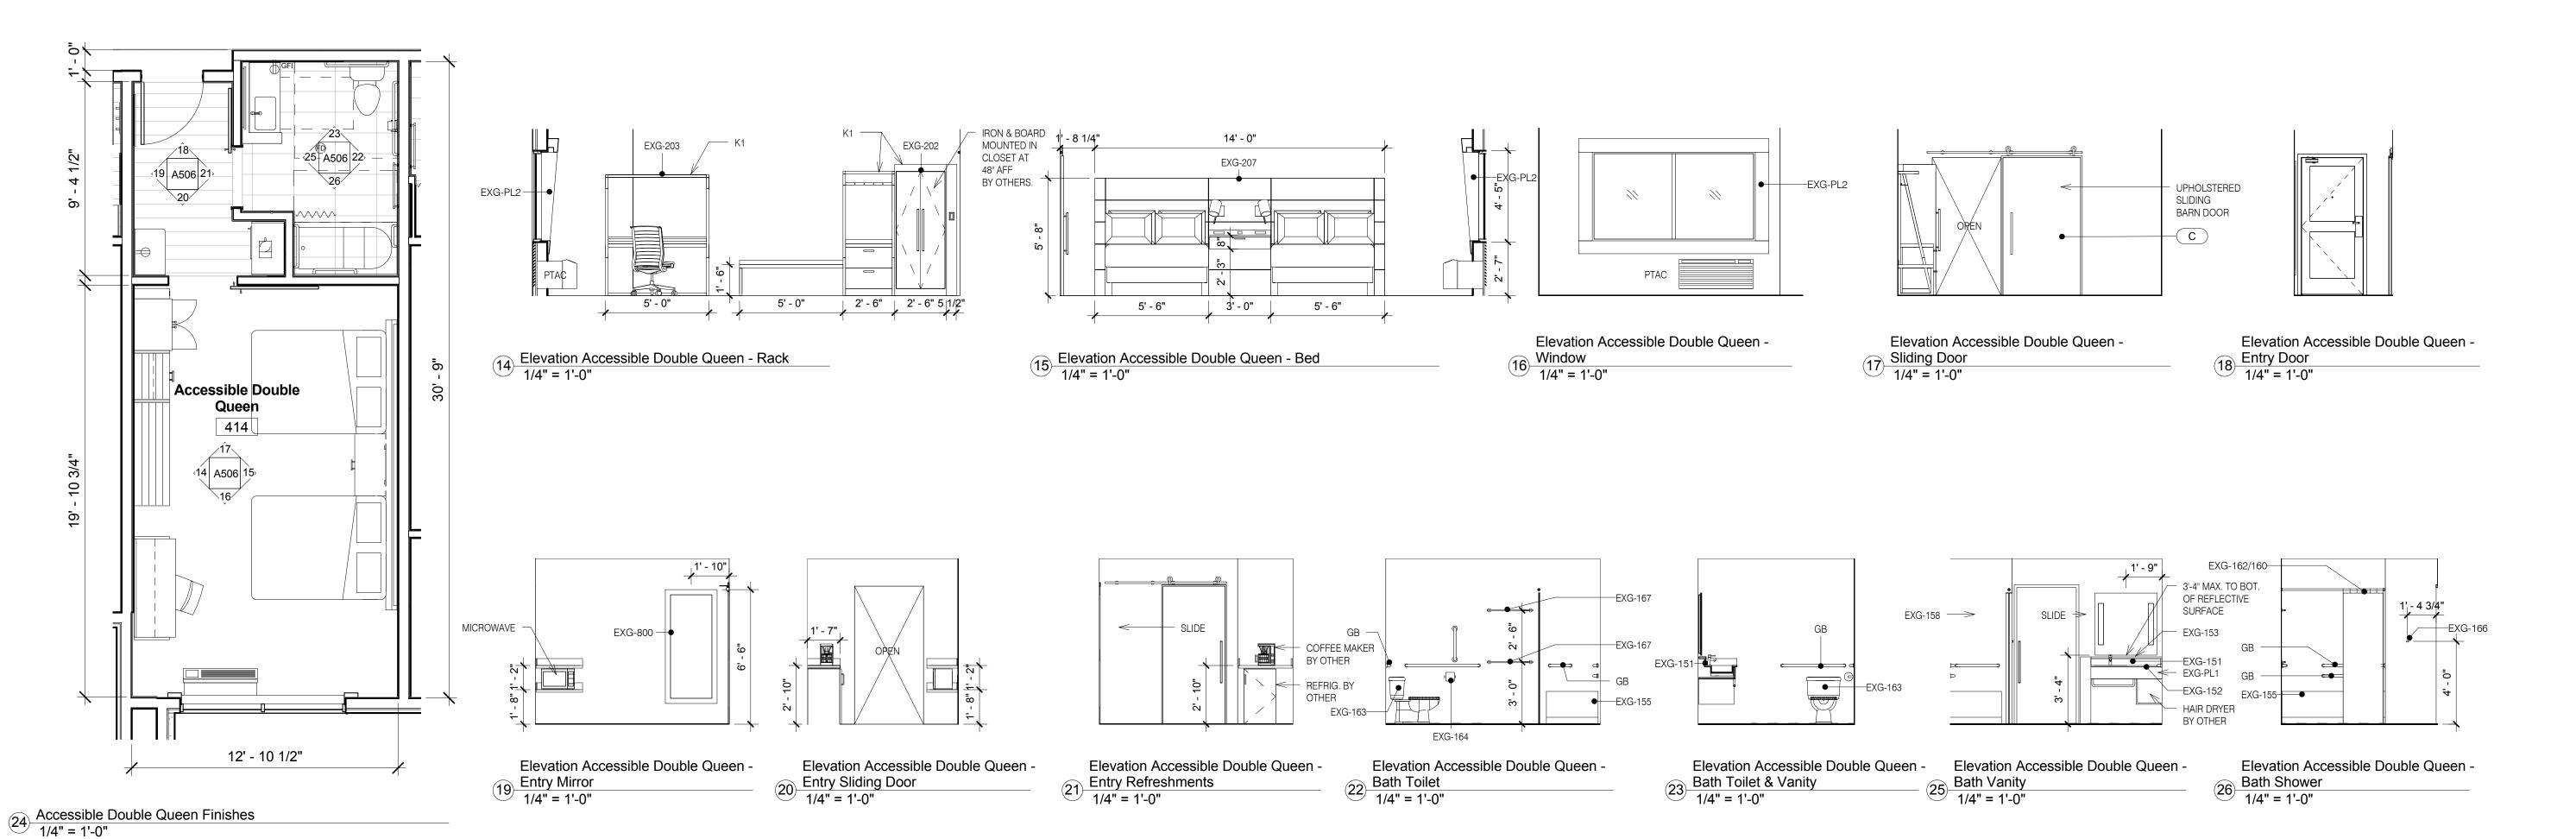
Accessible X wide King a


Accessible X wide King and Double Queen

Construction Documents





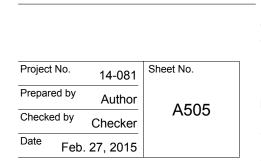

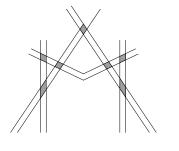

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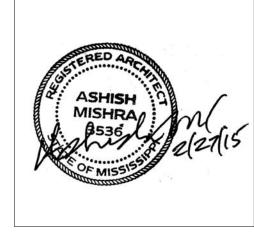
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Holiday Inn Express & Suites


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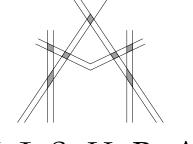
Drawing Title

Double Queen Suite and Accessible Double Queen

Phase
Construction Documents

Project No.	14-081	Sheet No.
Prepared by	Author	A506
Checked by	Checker	A506
Date Feb	. 27, 2015	



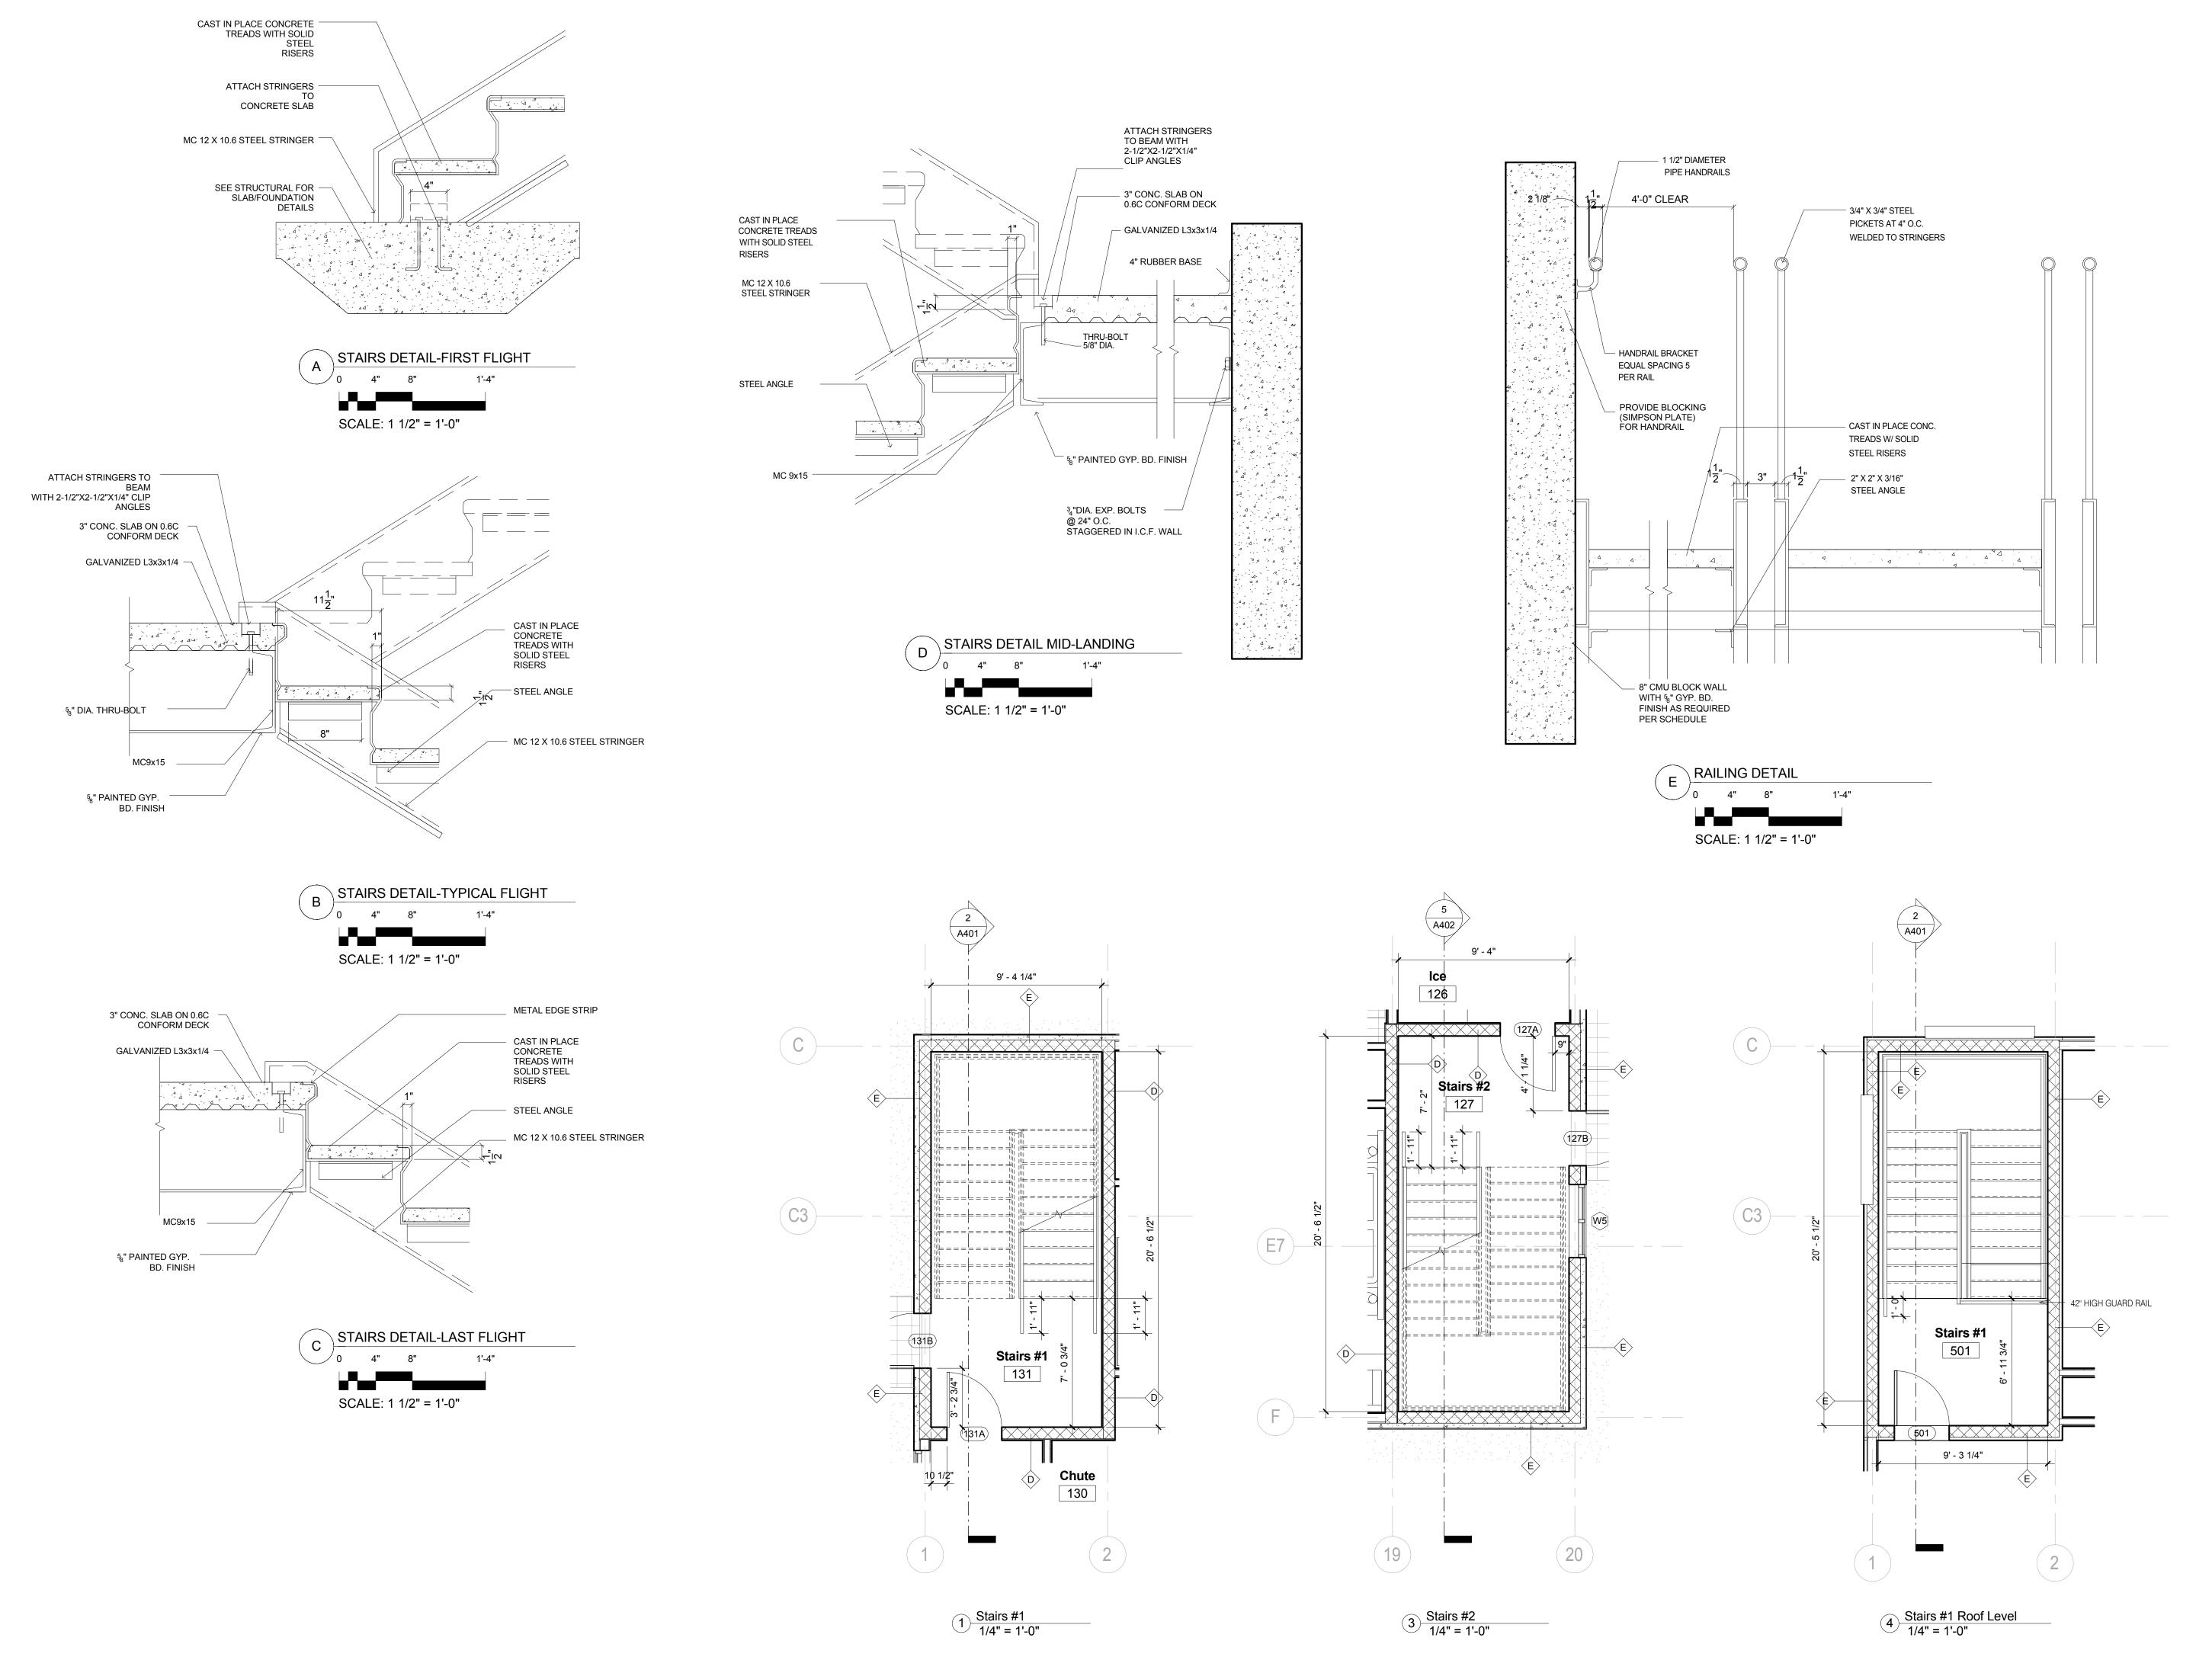

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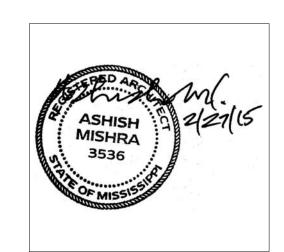
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**KEY PLAN** 

Shiva Southaven Inc.

Holiday Inn Express & Suites

Lot 16 (Rev Lot 3) Southcrest Southcrest Subdivision Southaven, MS 38671

Drawing Title Stair Details

Construction Documents 14-081 Sheet No. Project No. Prepared by Author Checked by Checker

Date Feb. 27, 2015





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KEY PLAN

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Holiday Inn Express & Suites

Lot 16 (Rev Lot 3) Southcrest Pkwy. Southcrest Subdivision Southaven, MS 38671

Drawing Title


Administrative Area Layout

Phase Construction Documents

Project No. 14-081
Prepared by Author
Checked by Checker
Date Feb. 27, 2015

Sheet No.

A521

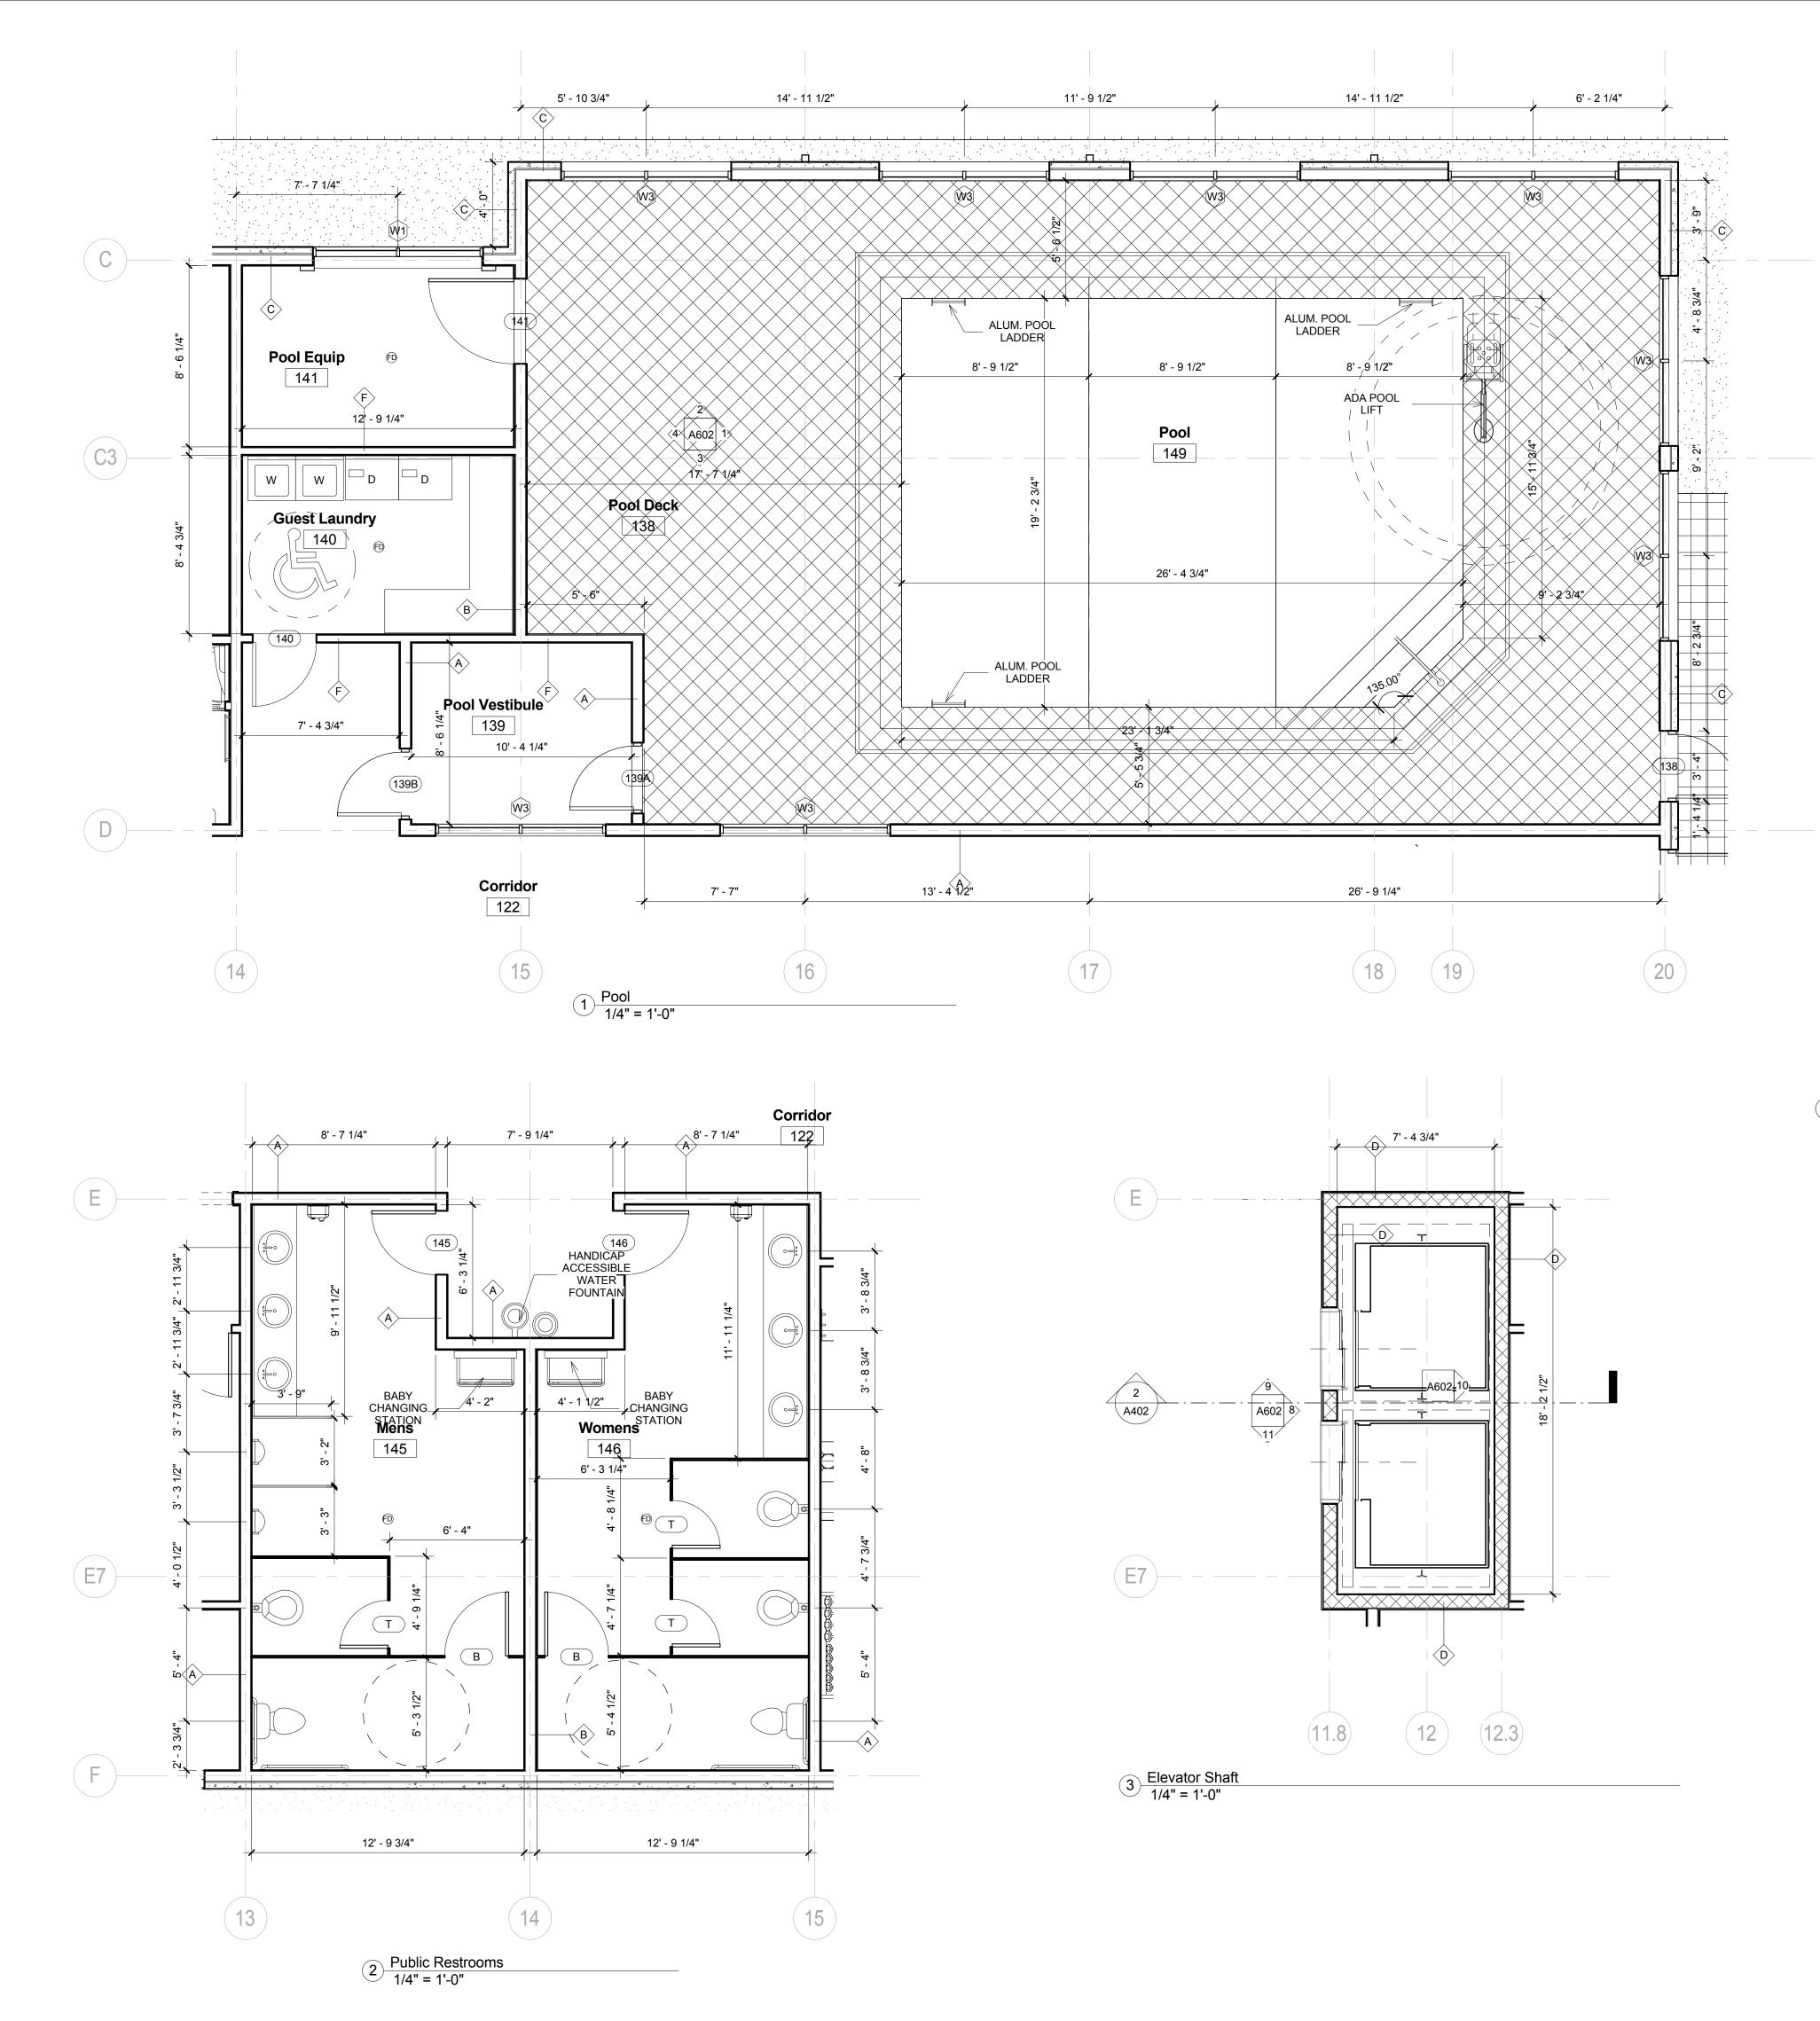

### **GENERAL NOTES**

1. HANDRAIL AND LADDER SHALL BE 1 1/2" DIA. STAINLESS STEEL.

2. THE POOL DRAWINGS & RELATED SPECS. ARE TO BE CONSIDERED AS MINIMUM REQUIREMENTS. THE G.C. & POOL CONTRACTOR ARE RESPONSIBLE FOR THE IMPLEMENTATION OF ALL APPLICABLE CODES ASSOCIATED WITH THE CONSTRUCTION TECHNIQUE OF THE POOL AREA & THE POOL FOLIRMENT POOM

3. DRAINAGE FOR THE DECK AREA MUST BE PROVIDED BY TRENCH DRAIN OR SLOPING DECK TOWARDS LANDSCAPED AREA. CONTRACTOR TO PROVIDE TWO POOL DRAINS.

4. AN EMERGENCY HOUSE PHONE MUST BE PROVIDED AT THE POOL. IT MUST BE IN A WEATHER TIGHT ENCLOSURE. WHEN THE RECEIVER IS LIFTED, THE PHONE MUST AUTOMATICALLY DIAL THE FRONT DESK. THE TOP OF THE PHONE MUST BE MOUNTED NO HIGHER

5. GENERAL CONTRACTOR TO PROVIDE UNDERWATER LIGHTS AND CONNECTIONS TO POOL DRAINS.

6. PROVIDE PROFESSIONALLY DESIGNED AND MANUFACTURED INTERNATIONAL NO DIVING EMBLEM AND DEPTH MARKINGS AS DESCRIBED BELOW. (PAINTED DEPTH MARKINGS ARE NOT PERMITTED)

-DEPTH MARKINGS: DEPTH MUST BE CLEARLY SHOWN ON BOTH THE TOP AND SIDE
(ABOVE THE WATER LINE) OF THE SWIMMING POOL COPING. DEPTH MARKINGS MUST BE COMMERCIAL GRADE AND INDICATE BOTH FEET
AND METERS ON THE TOP OF THE POOL COPING AND FEET ON THE SIDE OF THE POOL COPING. PAINTED DEPTH MARKINGS ARE NOT

PERMITTED; SLIP PROOF TILES ARE REQUIRED.
-NO DIVING: COMMERCIAL GRADE "NO DIVING" AND THE INTERNATIONAL SYMBOL MUST BE DISPLAYED ON THE TOP SIDE OF THE POOL COPING NEAR THE DEPTH MARKINGS. THE WORDS AND SYMBOL MUST BE DISPLAYED IN CONTRASTING COLORS TO THE BACKGROUND.


7. THE 2010 ADA STANDARDS REQUIRE THAT ALL POOLS OFFER ONE OR MORE ACCESSIBLE MEANS OF ENTRY (AS DEFINED BY THE 2010 ADA STANDARDS) FOR DISABLED GUESTS, DEPENDING ON THE SIZE OF THE POOL. TO THE EXTENT A POOL LIFT IS PROVIDED TO SATISFY THIS REQUIREMENT, THE LIFT MUST BE OPERABLE BY THE GUEST WITHOUT ASSISTANCE. REFER TO 2010 ADA STANDARDS FOR ALL NEW REQUIREMENTS. SUBMIT LOCATION OF POOL LIFT AT THE POOL AND SHOW THE REQUIRED MANEUVERING CLEARANCES.

8. PROVIDE THE REQUIRED POOL ACCESSORIES INCLUDING: SHEPHERD'S HOOK, RING, ROPE, ETC. SEE BRAND STANDARDS FOR


9. PROVIDE THE REQUIRED SIGNAGE AND COORDINATE WITH THE HOTEL'S OVERALL SIGNAGE PACKAGE. PERMANENTLY INSTALLED "POOL RULES" AND "HOURS OF OPERATION" SIGNAGE IS REQUIRED.

10. RECOMMEND A MAXIMUM POOL DEPTH OF 5'-0". FLOATER LINES ARE REQUIRED AT EITHER THE 5'-0" DEPTH LINE IN POOLS DEEPER THAN 5'-0" OR ALTERNATELY 1'-0" BEFORE THE POINT WHERE THE SWIMMING POOL SLOPES TOWARDS THE DEEP END.

11. SUBMIT POOL DESIGN DRAWINGS SHOWING THE FURNISHINGS, FINISH SELECTIONS AND SPECIFICATIONS PRIOR TO INSTALLATION. POOL DECK MUST BE DECORATIVELY SURFACED WITH A FINISH THAT PROVIDES A MINIMUM COEFFICIENT OF FRICTION, WET & DRY, OF 0.6. DECK FINISH MAY BE CERAMIC/PORCELAIN TILE, PATTERNED SYNTHETIC CEMENT TOPPING OR A DECORATIVELY PATTERNED AND SEALED CONCRETE SURFACE.

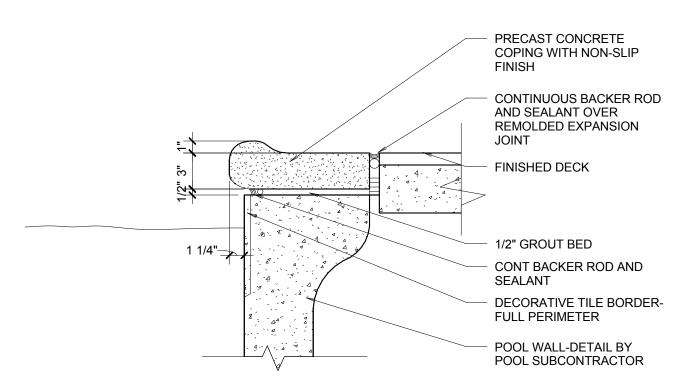

7 Pool Coping Detail
1 1/2" = 1'-0"

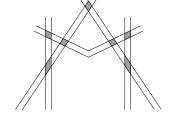

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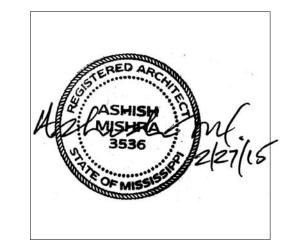
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**KEY PLAN** 

Shiva Southaven Inc.

Holiday Inn Express & Suites

Lot 16 (Rev Lot 3) Southcrest Pkwy. Southcrest Subdivision Southaven, MS 38671

Drawing Title
Pool, Restrooms and

Elevator

Phase Construction Documents


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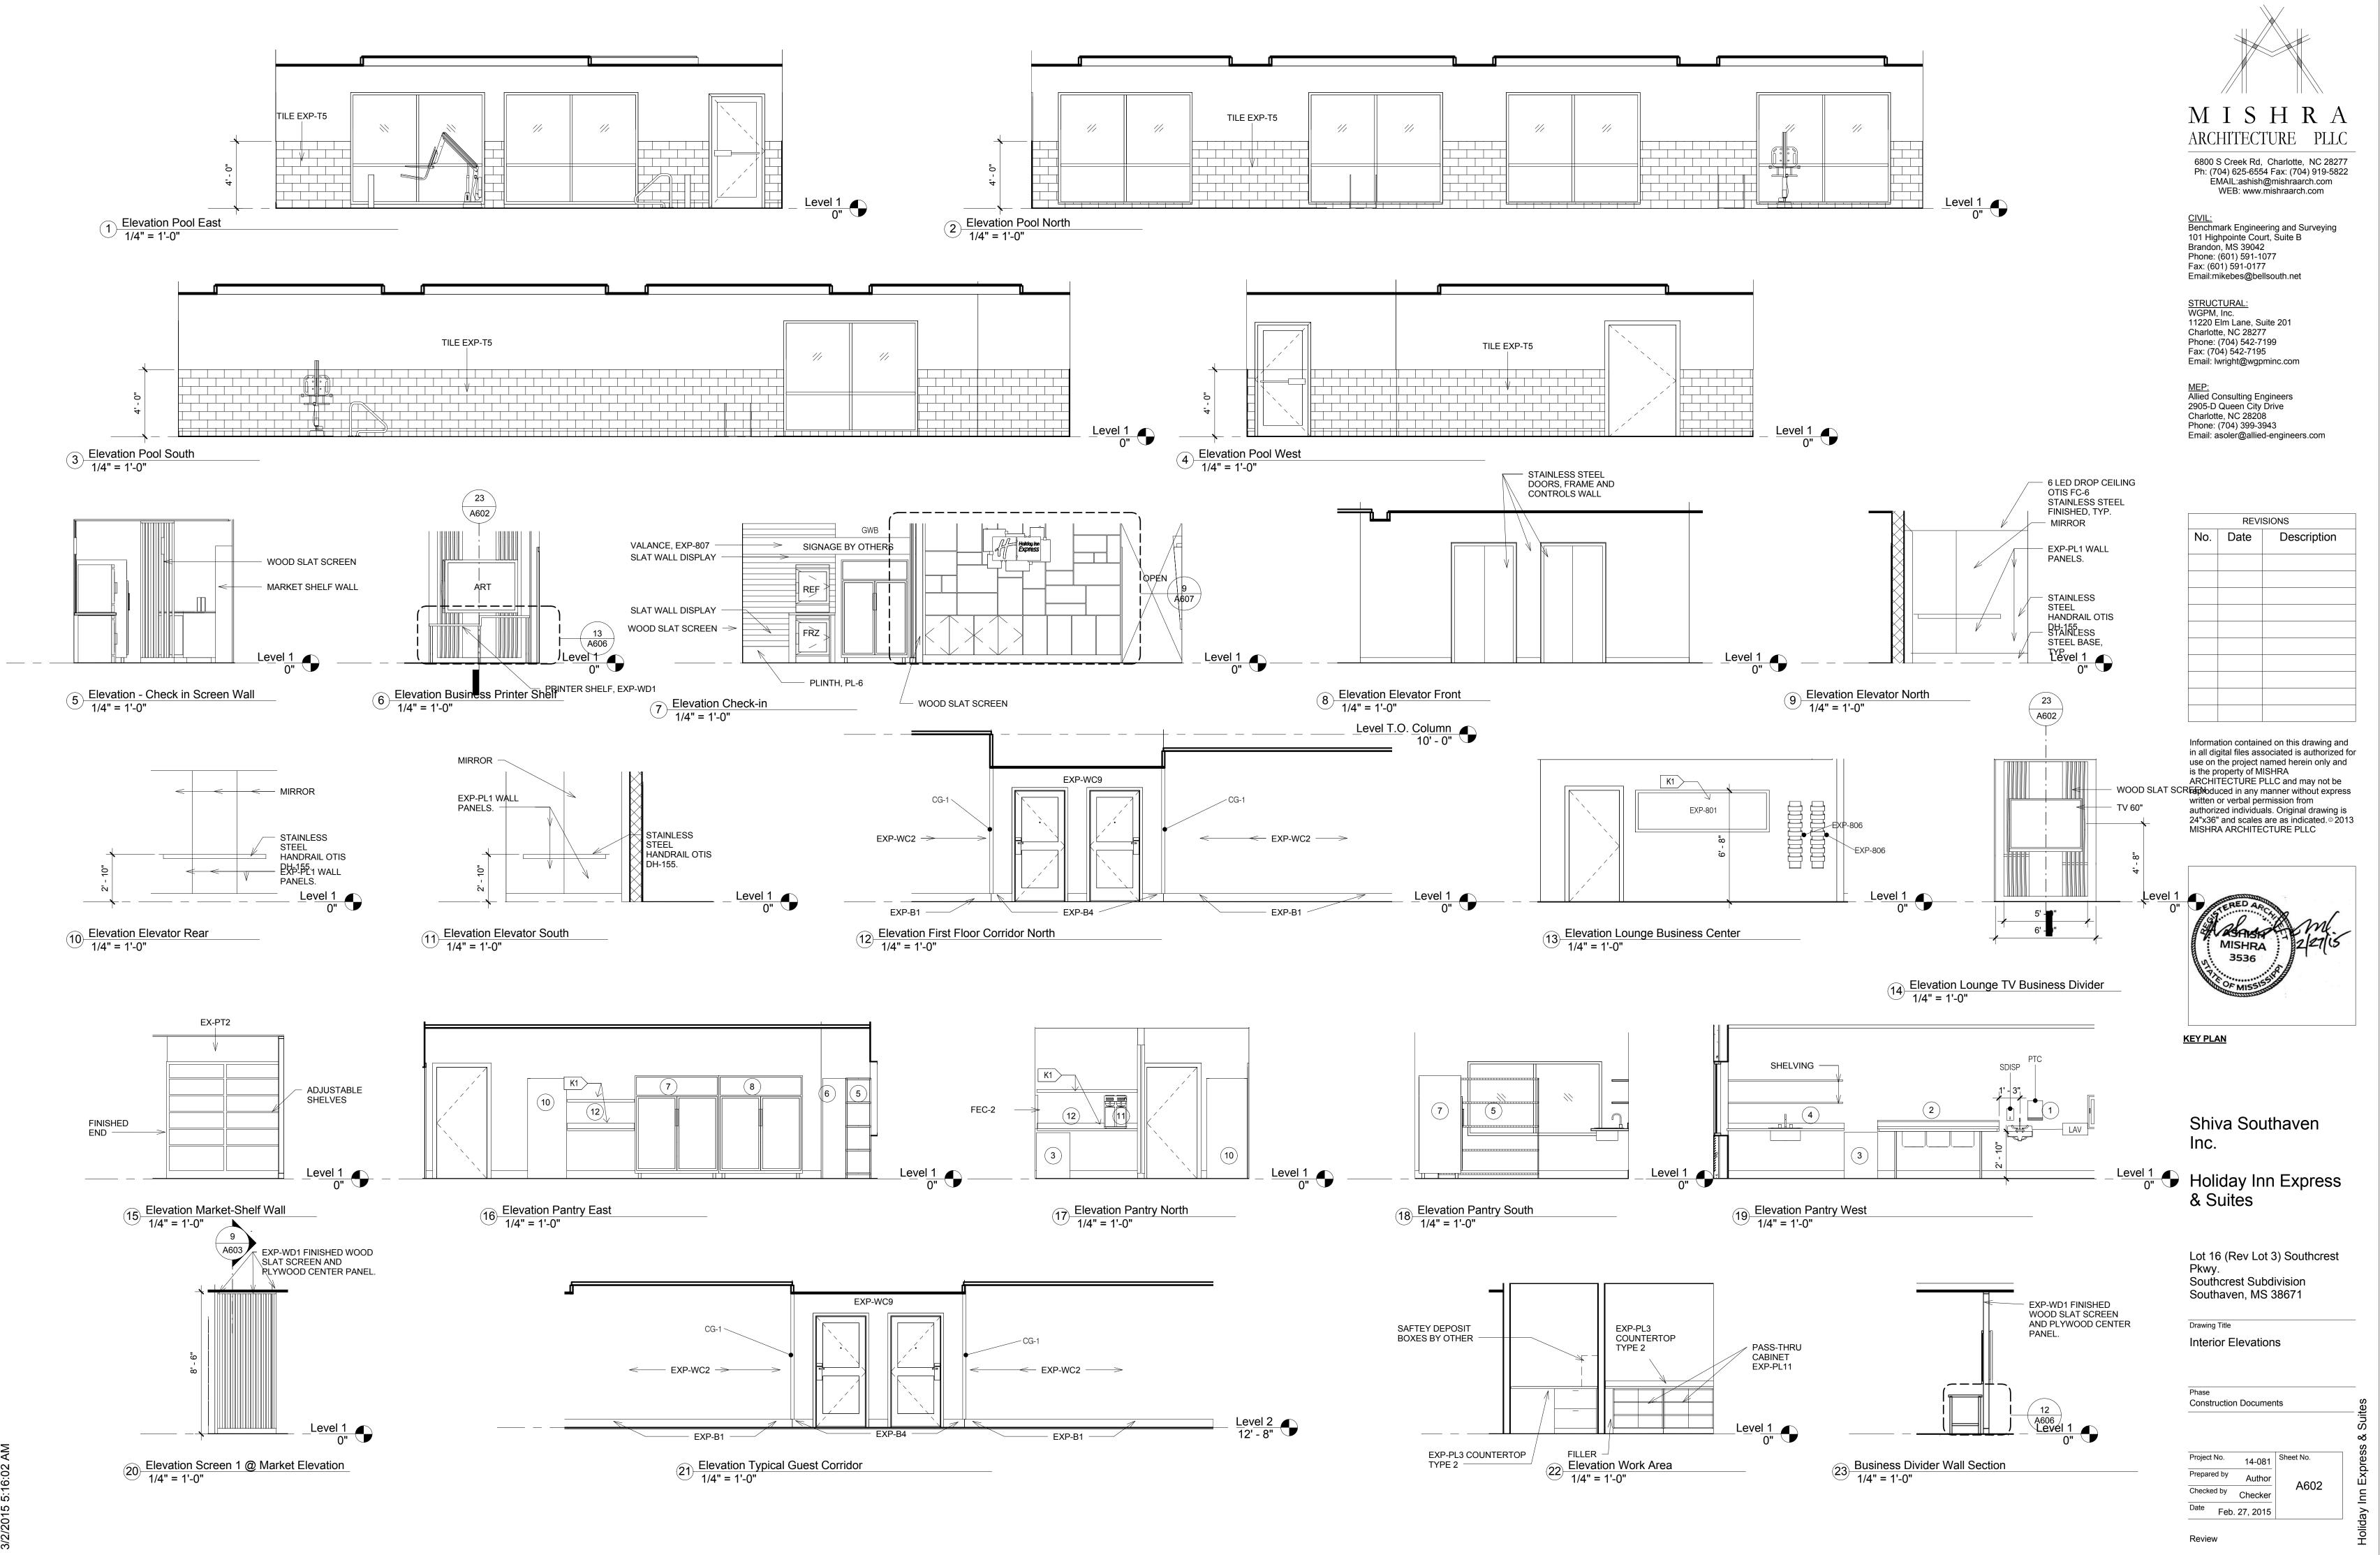
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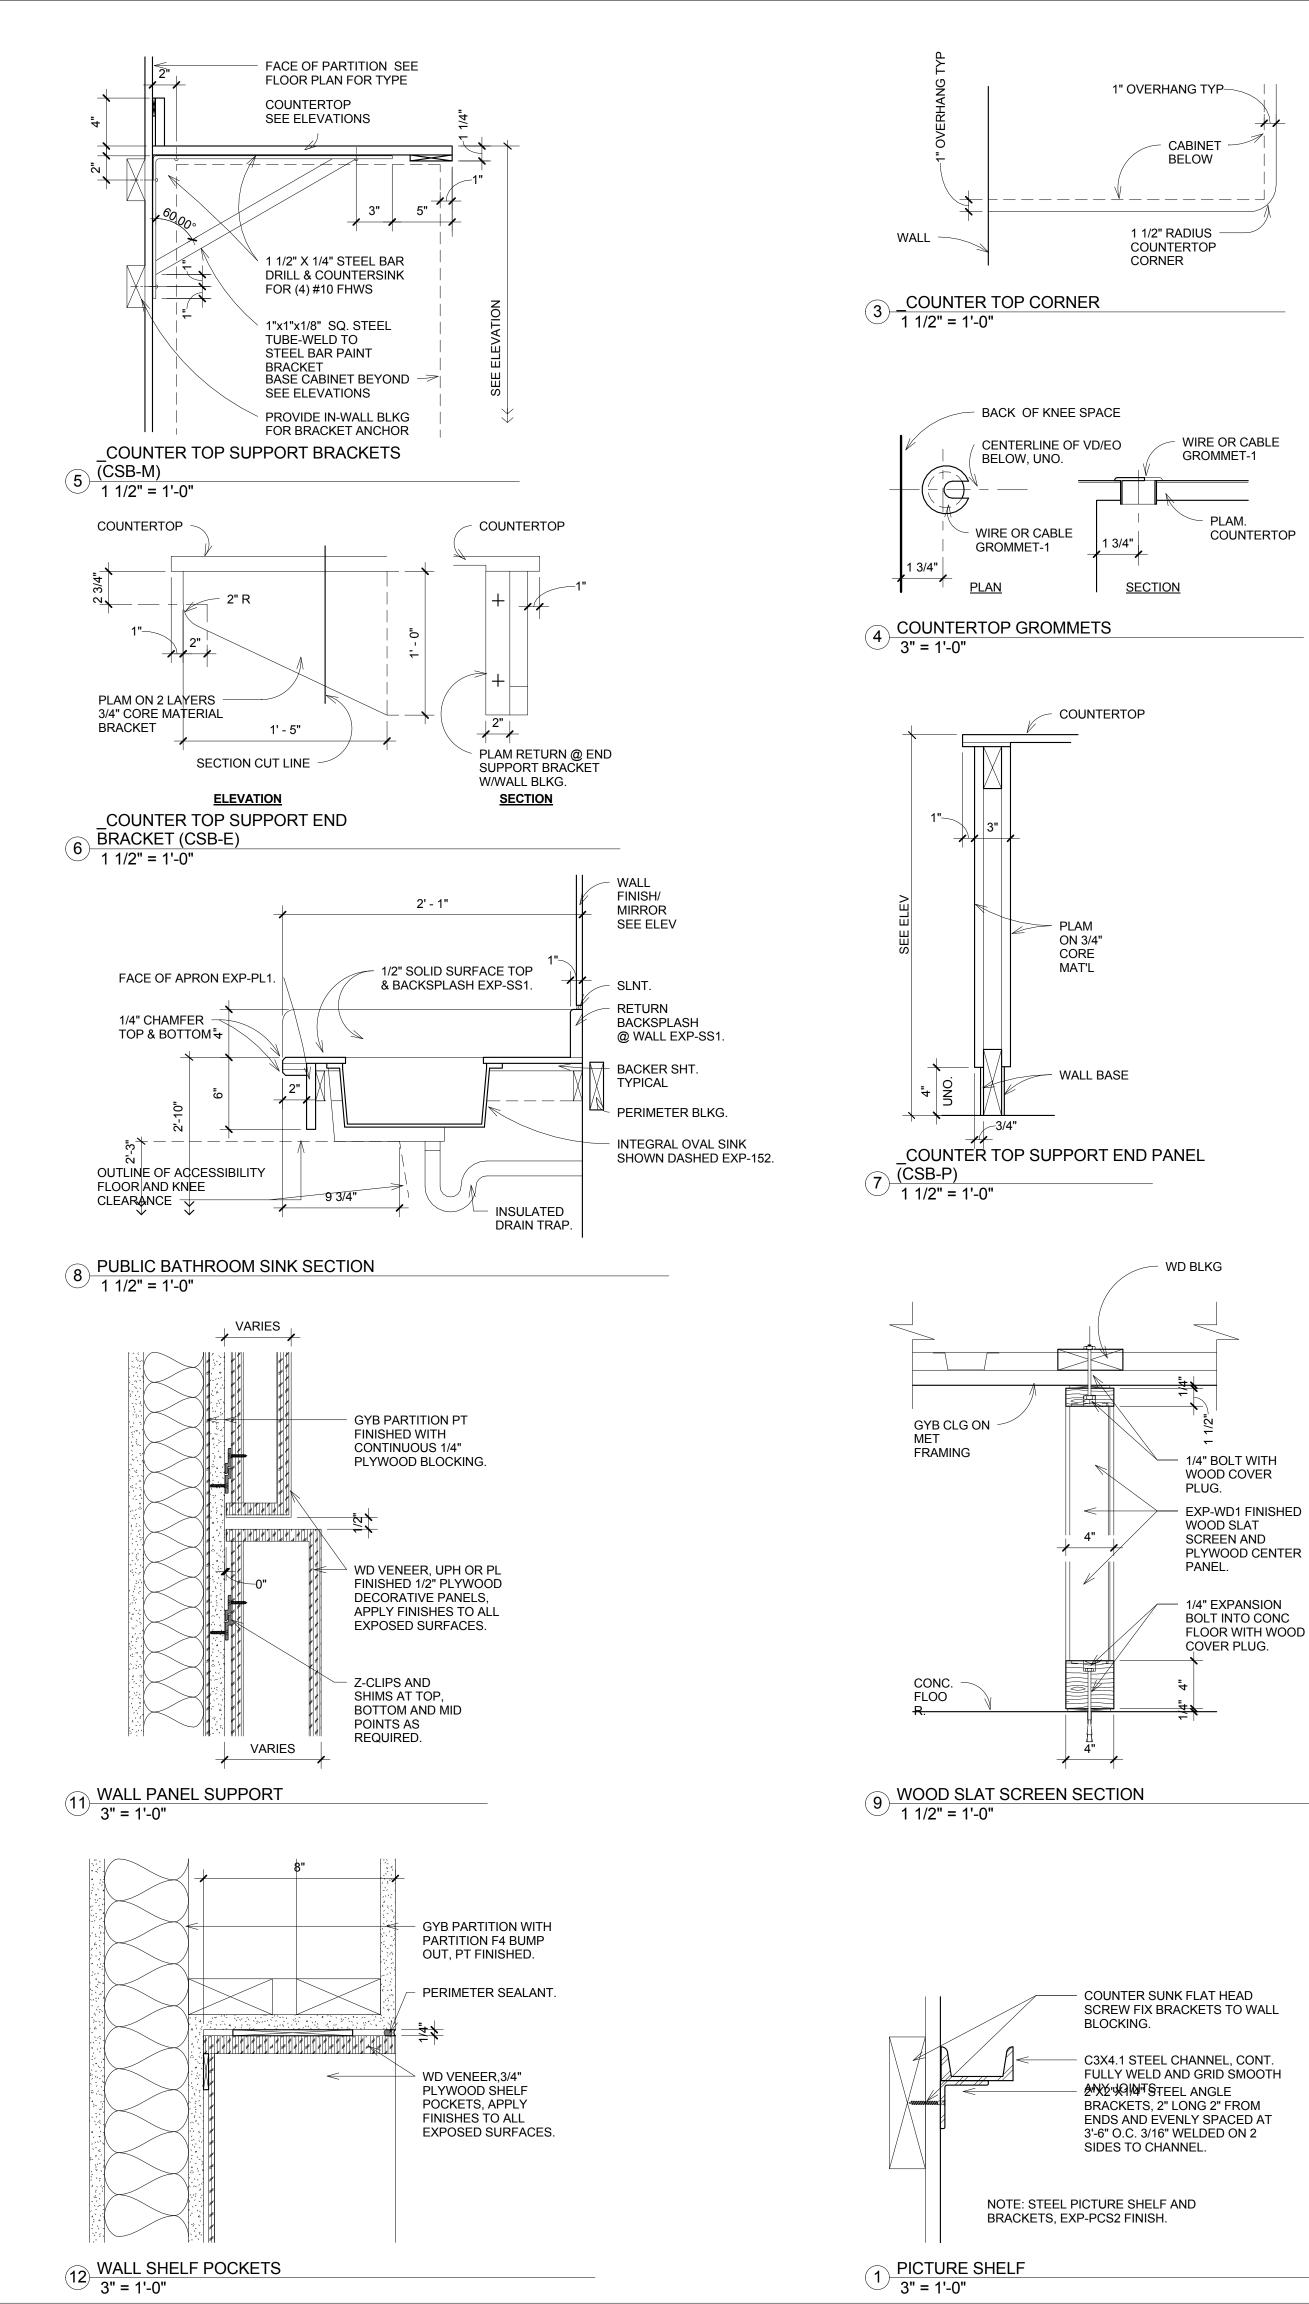
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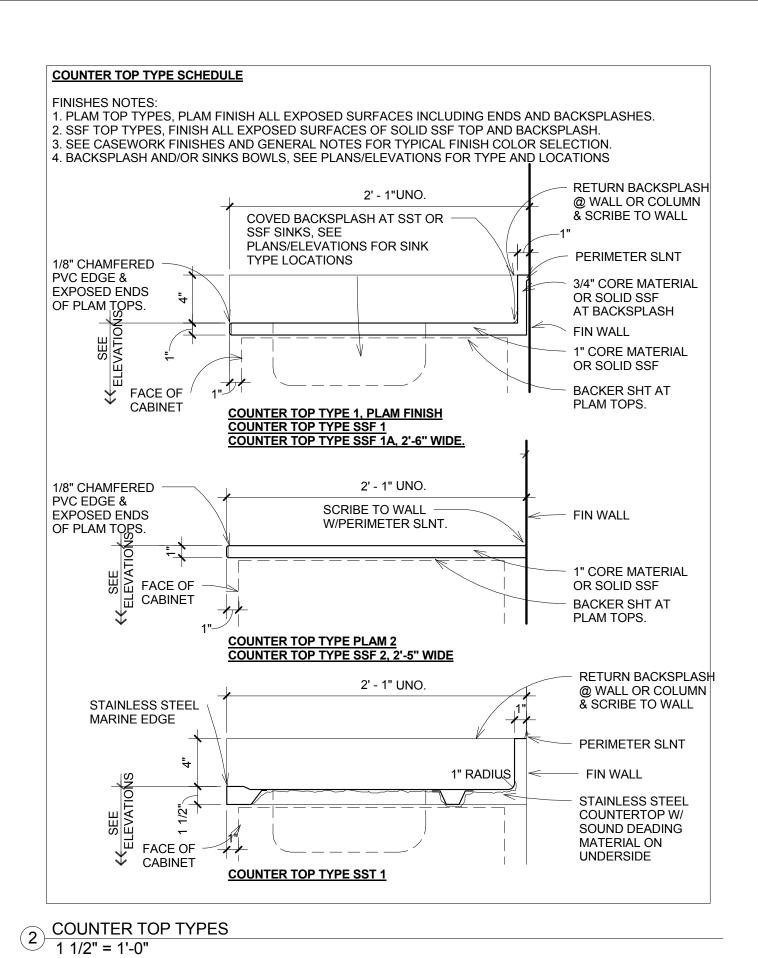
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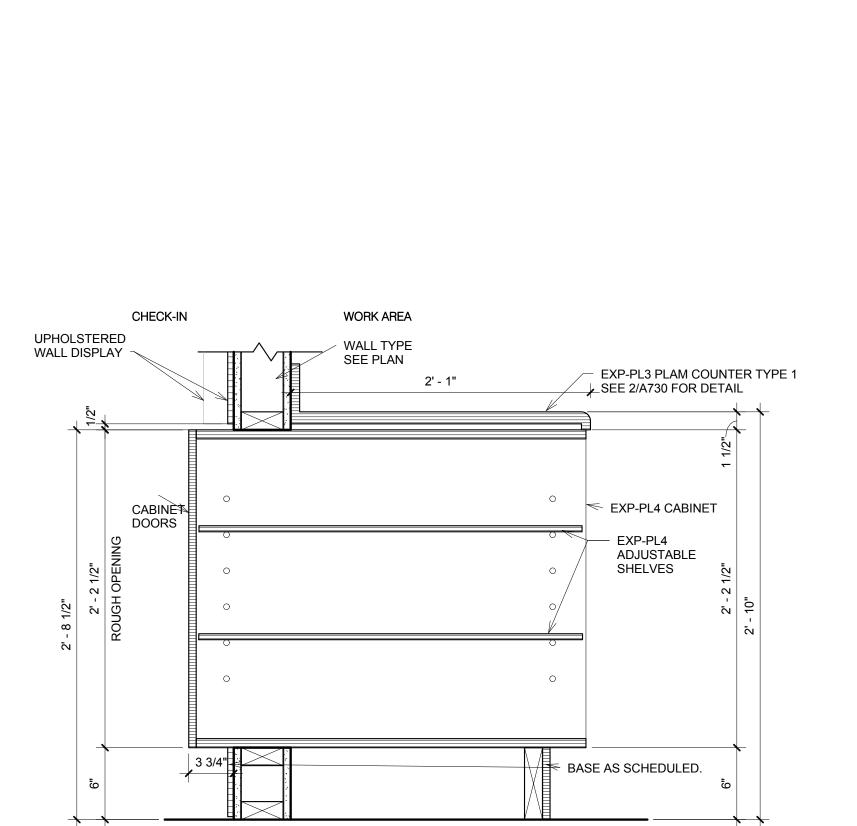
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10 CHECK-IN WALL DRAWER DETAIL
1 1/2" = 1'-0"

### **CASEWORK GENERAL NOTES**

1. CASEWORK SUBCONTRACTOR SHOULD INSPECT THE ALIGNMENT OF ALL GYPSUM BOARD CONSTRUCTION AND SHOULD NOTIFY THE ARCHITECT OF ANY CONDITION THAT WOULD PREVENT THEM FROM COMPLETING THEIR WORK. CASEWORK SUBCONTRACTOR SHALL COORDINATE WITH THE GENERAL CONTRACTOR ON THE LOCATION AND INSTALLATION OF ALL GROUNDS AND BLOCKING INSIDE THE WALL CONSTRUCTION RELATED TO CABINETWORK.

2. ALL CASEWORK SHALL HAVE A FINE, SMOOTH FINISH, FREE FROM MACHINE OR TOOL MARKS, ABRASIONS OR RAISED GRAIN ON EXPOSED SURFACES. JOINTS SHALL BE TIGHT AND SO FORMED AS TO CONCEAL SHRINKAGE. MITERS OR MORE FROM HEEL TO POINT SHALL BE GLUED 4" AND FEATHERED, LOCKED, SPLINED, AND DOWELED. TENONS AND DOWELS SHALL BE OF HARDWOOD AND SPACED NOT LESS THAN 3" ON CENTER. JOINTS SHALL BE MADE WITH WATER-RESISTANT GLUE OR HOT GLUED UNDER PRESSURE. ALL EXPOSED WORK SHALL BE FULLY ASSEMBLED IN THE SHOP IN AS LARGE A UNIT AS PRACTICAL, THEN DELIVERED AND INSTALLED.

3. SCREW AND GLUE ALL JOINTS AND CONNECTIONS. NO NAILING PERMITTED.

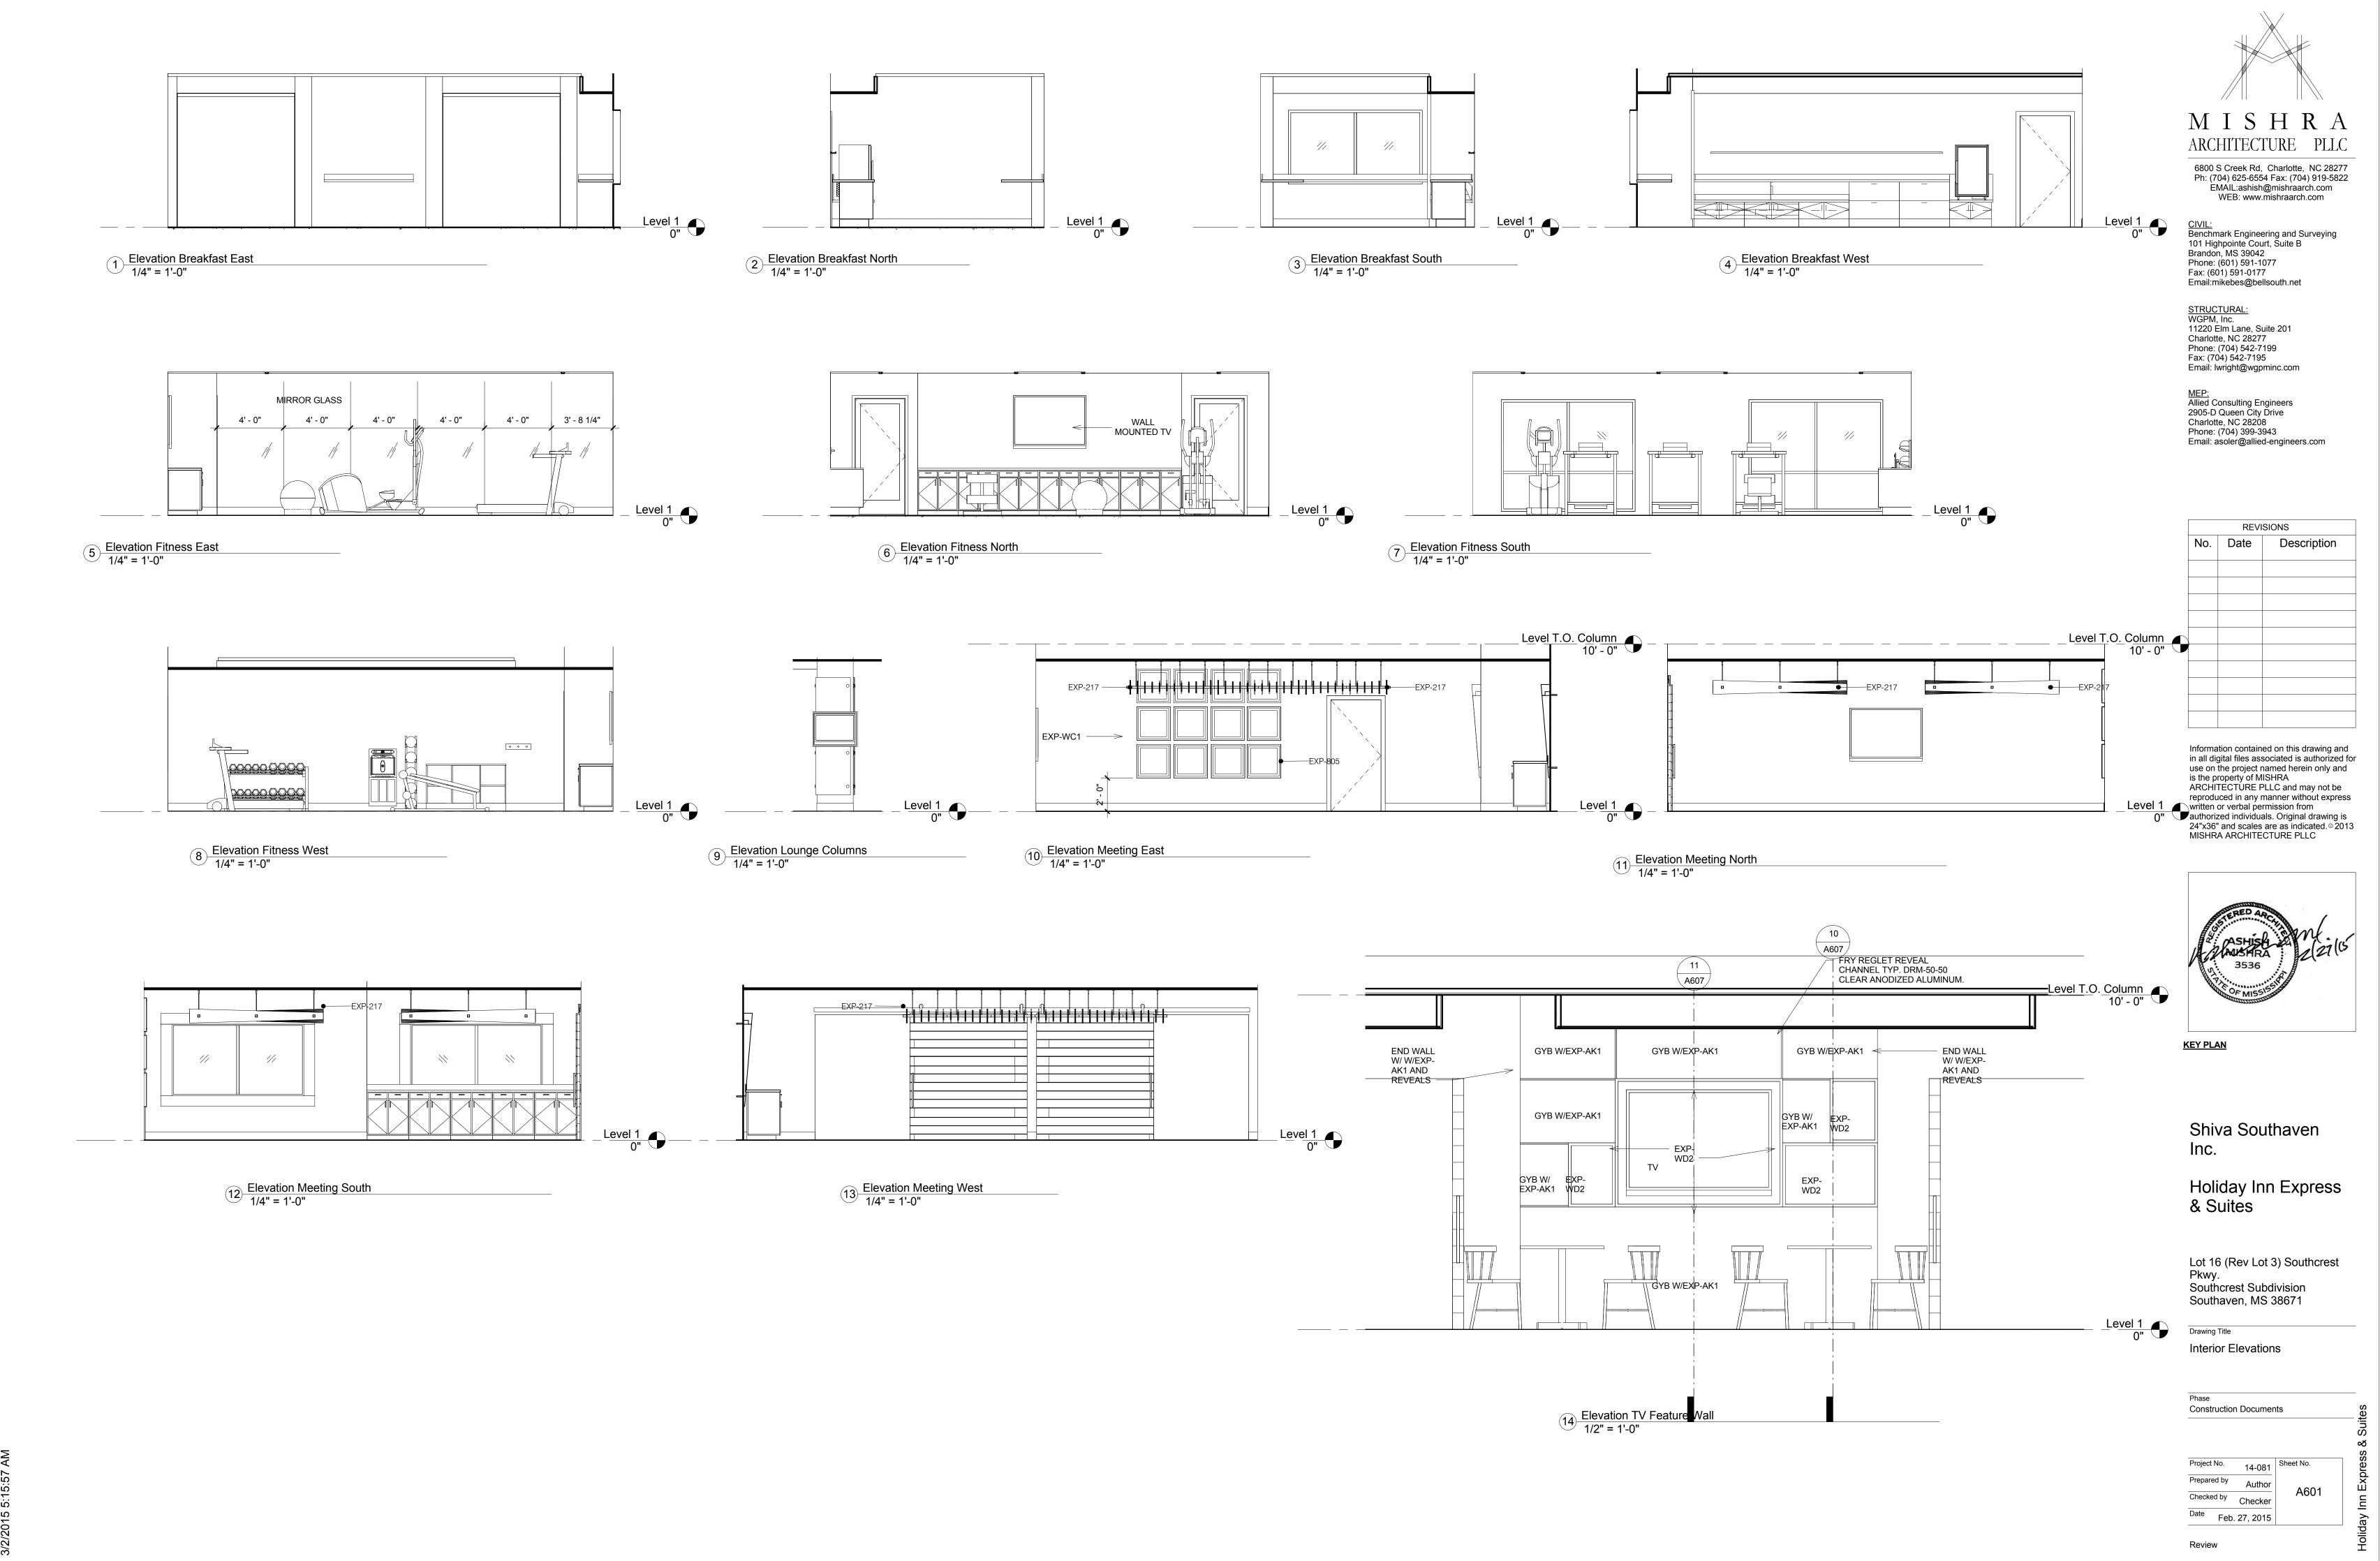4. ALL HIGH-PRESSURE PLASTIC LAMINATE WORK SHALL BE SOLID, IN ONE PIECE AND WITHOUT SPLICE JOINTS (EXCEPT WHERE PROHIBITED BY THE MAXIMUM AVAILABLE SIZE OF THE MANUFACTURED PLASTIC LAMINATE MATERIALS) AND SHALL BE BONDED TO THE CORE STOCK USING THE "HOT PLATE" PRESS METHOD. ALL EDGES AND EXPOSED CORNERS TO BE FINELY JOINED: UNSIGHTLY JOINTS, NICKS, SCRATCHES, CHOPS, DEFECTS, WAVY OR UNEVEN LAMINATION WILL BE REJECTED. IF JOINTS ARE REQUIRED DUE TO LENGTH OF UNIT, JOINTS TO BE CENTERED SYMMETRICALLY OVER THE LENGTH OF THE UNIT.

5. ALL SURFACES TO BE LAMINATED (PLASTIC LAMINATE OR VENEERED) SHALL BE WITH THE SAME TYPE OF MATERIAL ON THE BOTH SIDES (BACKING) WHETHER VISIBLE OR NOT. PANEL AND PLYWOOD BACKS NOT EXPOSED TO VIEW SHALL BE VENEERED WITH THE SAME SPECIES AND THICKNESS OF VENEER USED FOR THE FACES, FOR BALANCED CONSTRUCTION. HOWEVER, THE VENEERED SURFACES NOT EXPOSED TO VIEW NEED NOT BE MATCHED.

6. CASEWORK CABINETRY WHERE THE DOORS HAVING PLASTIC LAMINATE FACES SHALL ALSO HAVE BACKS AND EDGES OF THE SAME PLASTIC LAMINATE AS THE FACE. DRAWERS HAVING PLASTIC LAMINATE FACES SHALL HAVE BIRCH VENEER SOLID CORE INTERIOR CONSTRUCTION (BOTTOM AND SIDES) WITH CLEAR LACQUER FINISH. DRAWER FRONT AND SIDES TO BE GROOVED TO RECEIVE (3) PLY BOTTOM PIECE.

7. WHERE ELECTRICAL WORK IS SPECIFIED IN CABINETS, LAMPS AND FIXTURES ARE TO BE PROVIDED BY THE GENERAL CONTRACTOR. CUTOUTS FOR SWITCHES, OUTLETS, AND WIRING DEVICES TO BE INSTALLED IN CABINETRY IN THE FIELD ARE BY THE CASEWORK SUBCONTRACTOR AND ARE TO BE COORDINATED BY THE GENERAL CONTRACTOR.

8. CASEWORK SUBCONTRACTOR SHALL PROVIDE ALL HARDWARE REQUIRED FOR FINISHED INSTALLATION OF CABINETS.

9. FIELD VERIFY LOCATION OF ALL HOLES THROUGH ALL NEW COUNTERTOPS AND MILLWORK. PROVIDE A GROMMET INSERT AT EACH LOCATION WERE ELECTRICAL, VOICE/DATA OUTLETS OCCUR. SEE DETAILS FOR SIZES, LOCATIONS AND FINISHES OF GROMMET.

10. CASEWORK SUBCONTRACTOR SHALL SHIM AND LEVEL ALL COUNTERS TO BE LOCATED OVER FILES, AND PROVIDE A STABLE TEMPORARY SUPPORT UNTIL FILES ARE DELIVERED FOR INSTALLATION. CONTRACTOR TO PROVIDE FILLER STRIPS AS REQUIRED BETWEEN FILE CABINETS AND COUNTERTOPS, AND BETWEEN CABINETS AND SURROUNDING WALLS AND CEILINGS.

11. CASEWORK SUBCONTRACTOR IS RESPONSIBLE TO CLEAN AND POLISH AND TOUCH UP AS REQUIRED ALL WOODWORK AFTER THE INSTALLATION IS COMPLETED.

12. CASEWORK FINISHES ARE INDICATED IN THE ROOM FINISHES SCHEDULE AND/OR INTERIOR ELEVATIONS.

DRAWER HANDLE: JG Edelen 7600-128 brushed nickel finish.

CABINET HARDWARE:
CABINET DOOR HANDLE: JG Edelen #7600-320 (12 1/2") brushed nickel finish.



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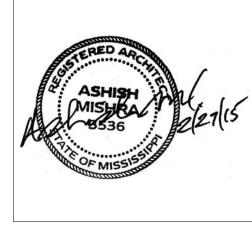
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KEY PLAN

Shiva Southaven

Holiday Inn Express & Suites

Lot 16 (Rev Lot 3) Southcrest Pkwy. Southcrest Subdivision Southaven, MS 38671

Drawing Title

Casework Types and Details

Project No. 14-081 Sheet No.


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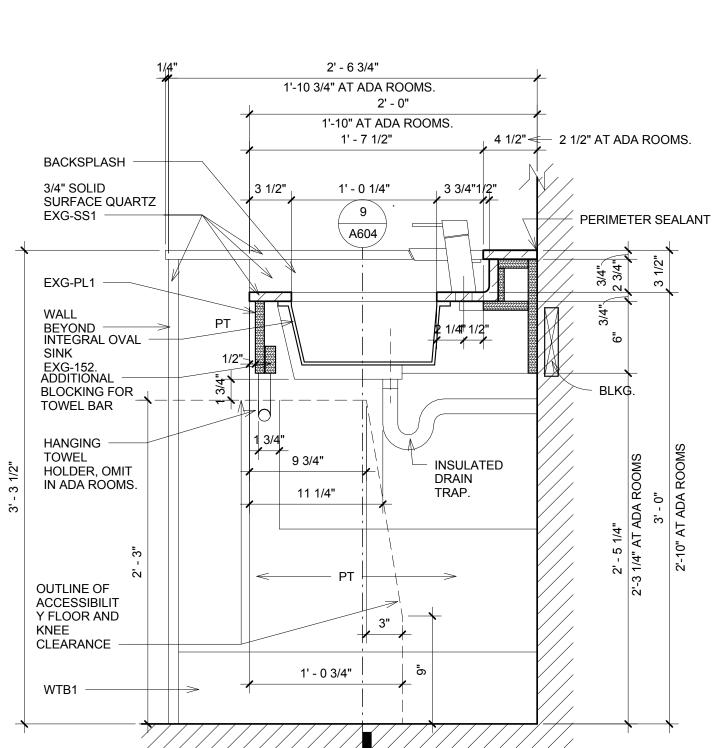
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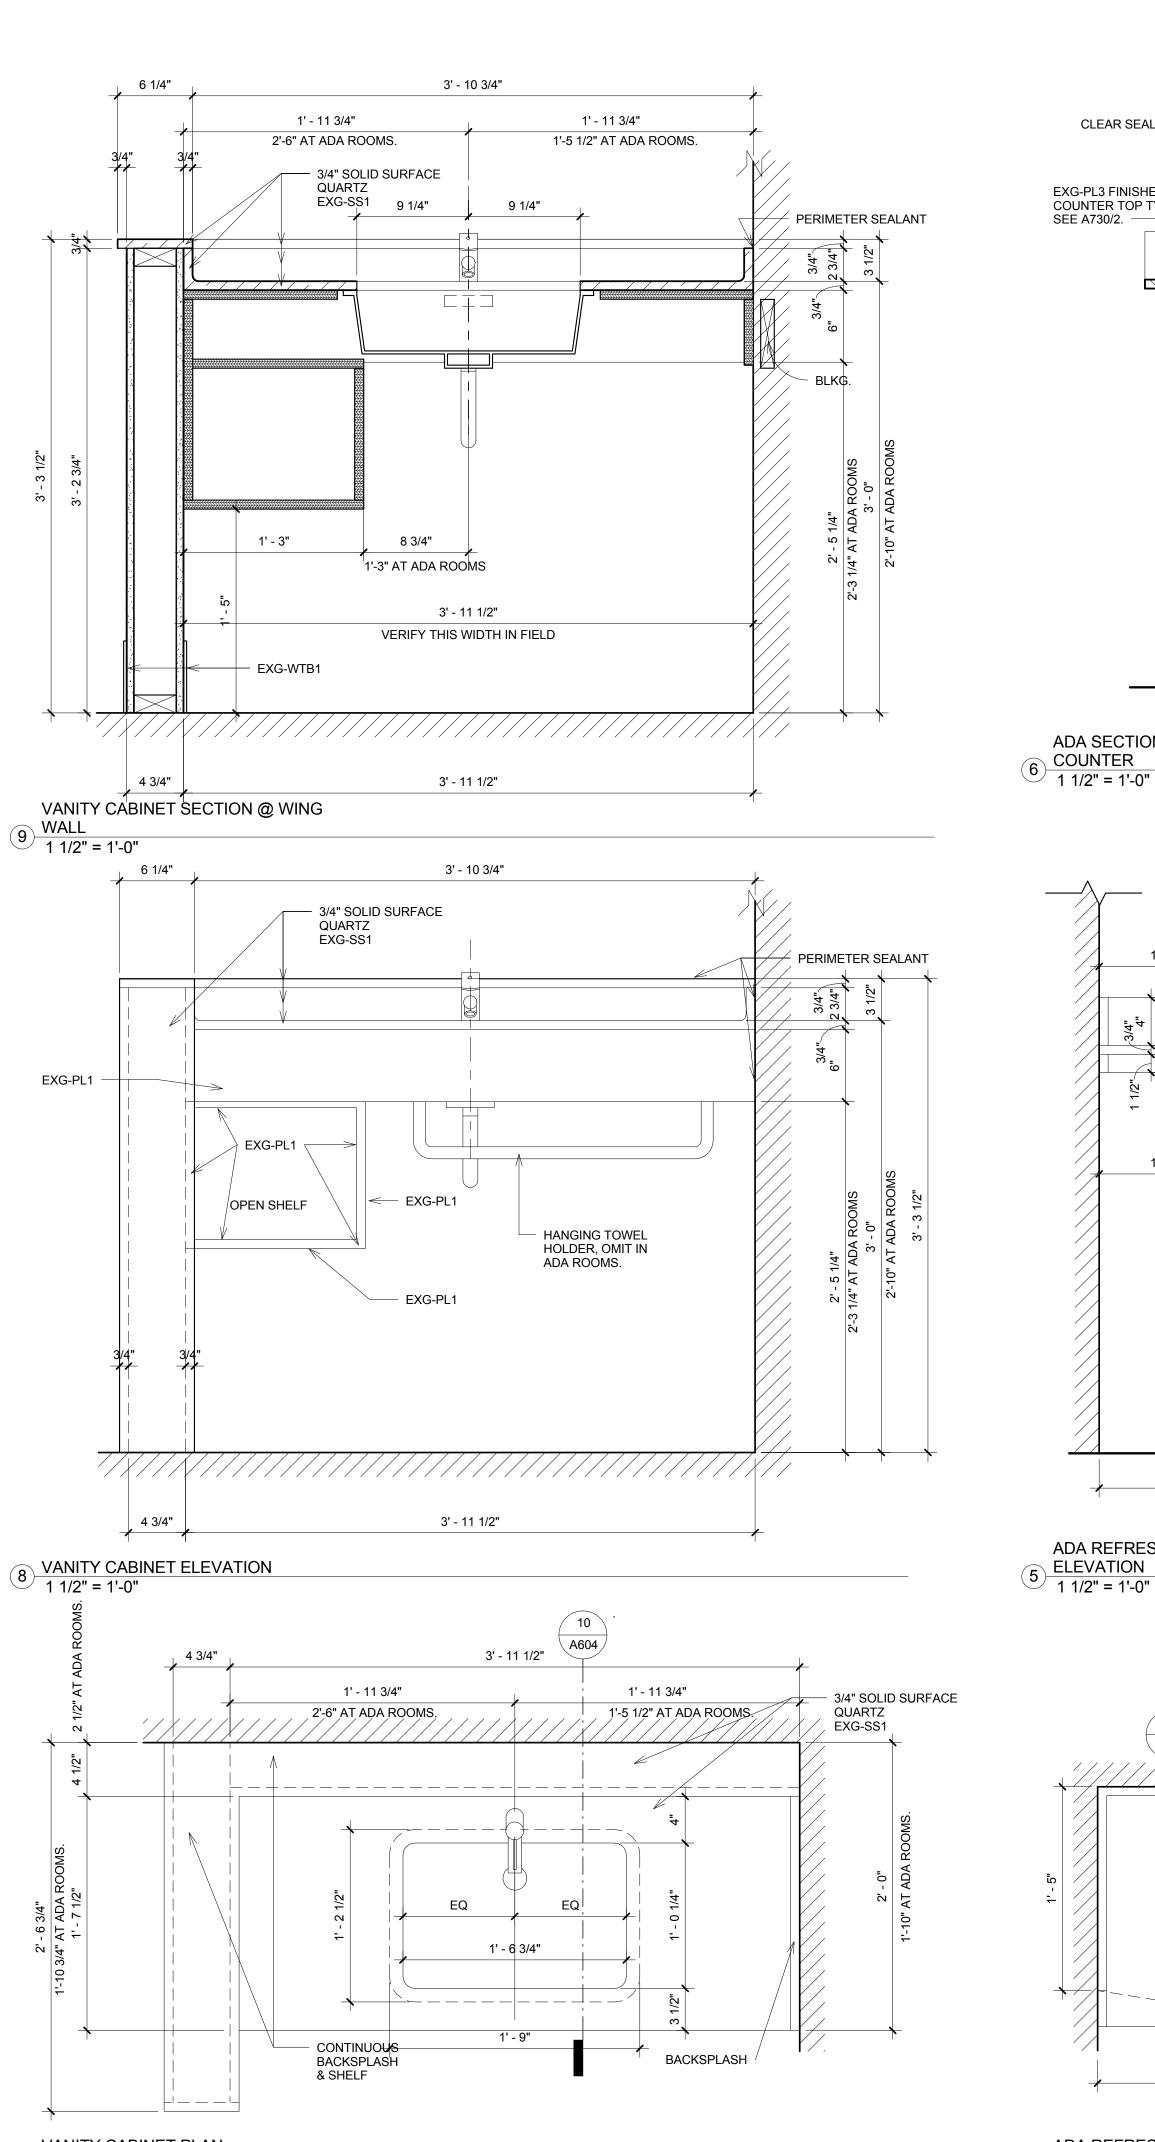
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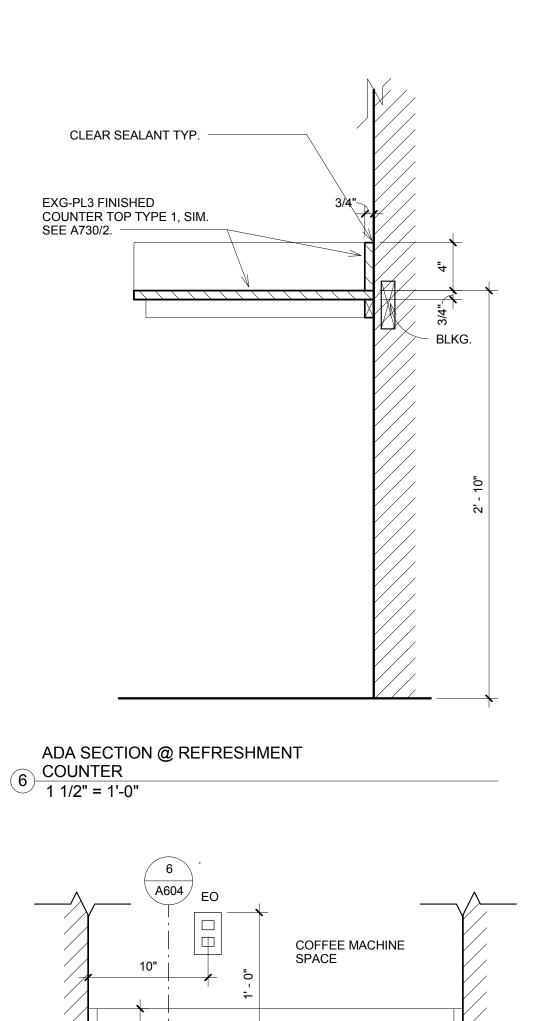
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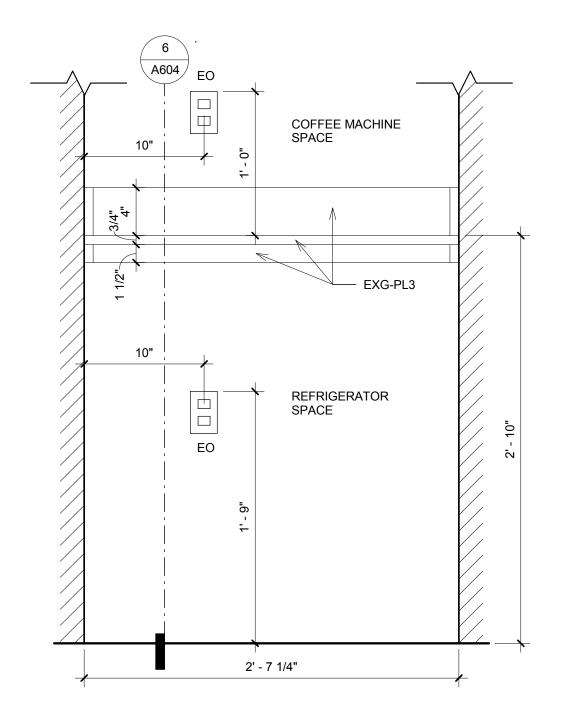
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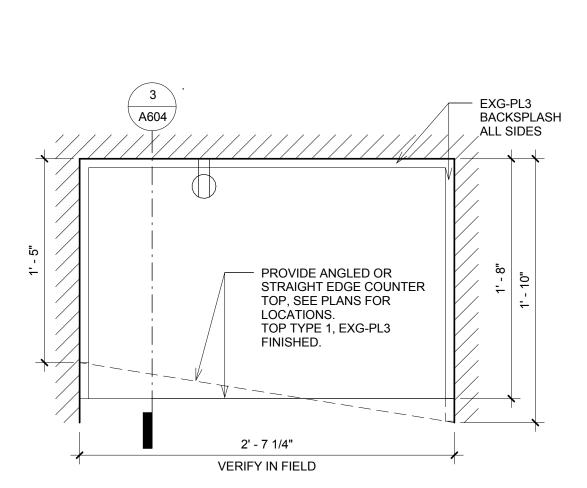










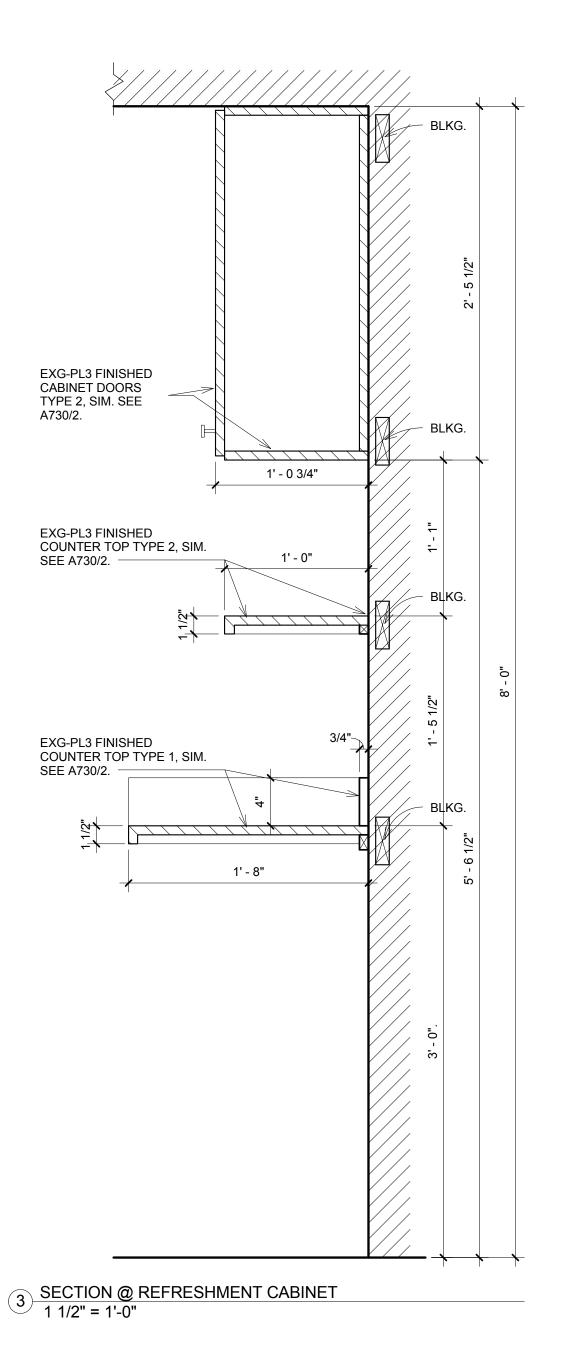



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DOOR HARDWARE: JG Edelen 7600-128 brushed nickel finish

MICROWAVE

COFFEE MACHINE

SPACE

SPACE

GROMMET

SHELF FOR SAFE

SPACE

2' - 7 1/4"

REFRIGERATOR

— 2 1/2" DIA. GROMMET /

PROVIDE ANGLED OR STRAIGHT EDGE COUNTER

TOP, SEE PLANS FOR

TOP TYPE 1, EXG-PL3

LOCATIONS.

\_FINISHED.

2' - 7 1/4"

VERIFY IN FIELD

7 3/4" |

EO


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**KEY PLAN** 

Shiva Southaven 2 REFRESHMENT CABINET ELEVATION
1 1/2" = 1'-0"

- EXG-PL3 BACKSPLASH

ALL SIDES


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Drawing Title Casework Details

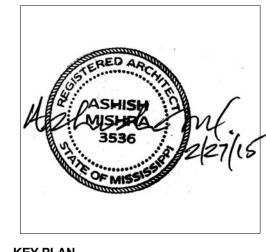Construction Documents


14-081 Sheet No. Author Checked by Checker Date Feb. 27, 2015



ADA REFRESHMENT COUNTER

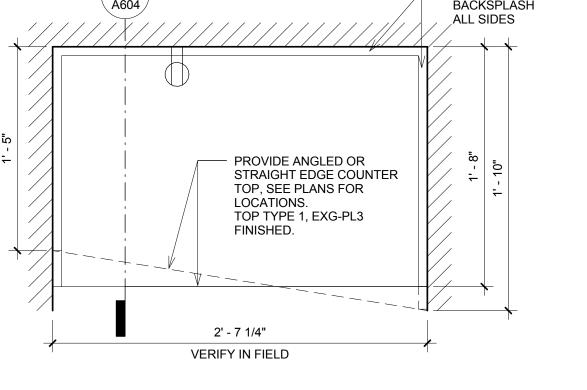10 VANITY CABINET SECTION
1 1/2" = 1'-0"

1 REFRESHMENT CABINET PLAN
1 1/2" = 1'-0" 7 VANITY CABINET PLAN
1 1/2" = 1'-0" 4 ADA REFRESHMENT COUNTER PLAN 1 1/2" = 1'-0"

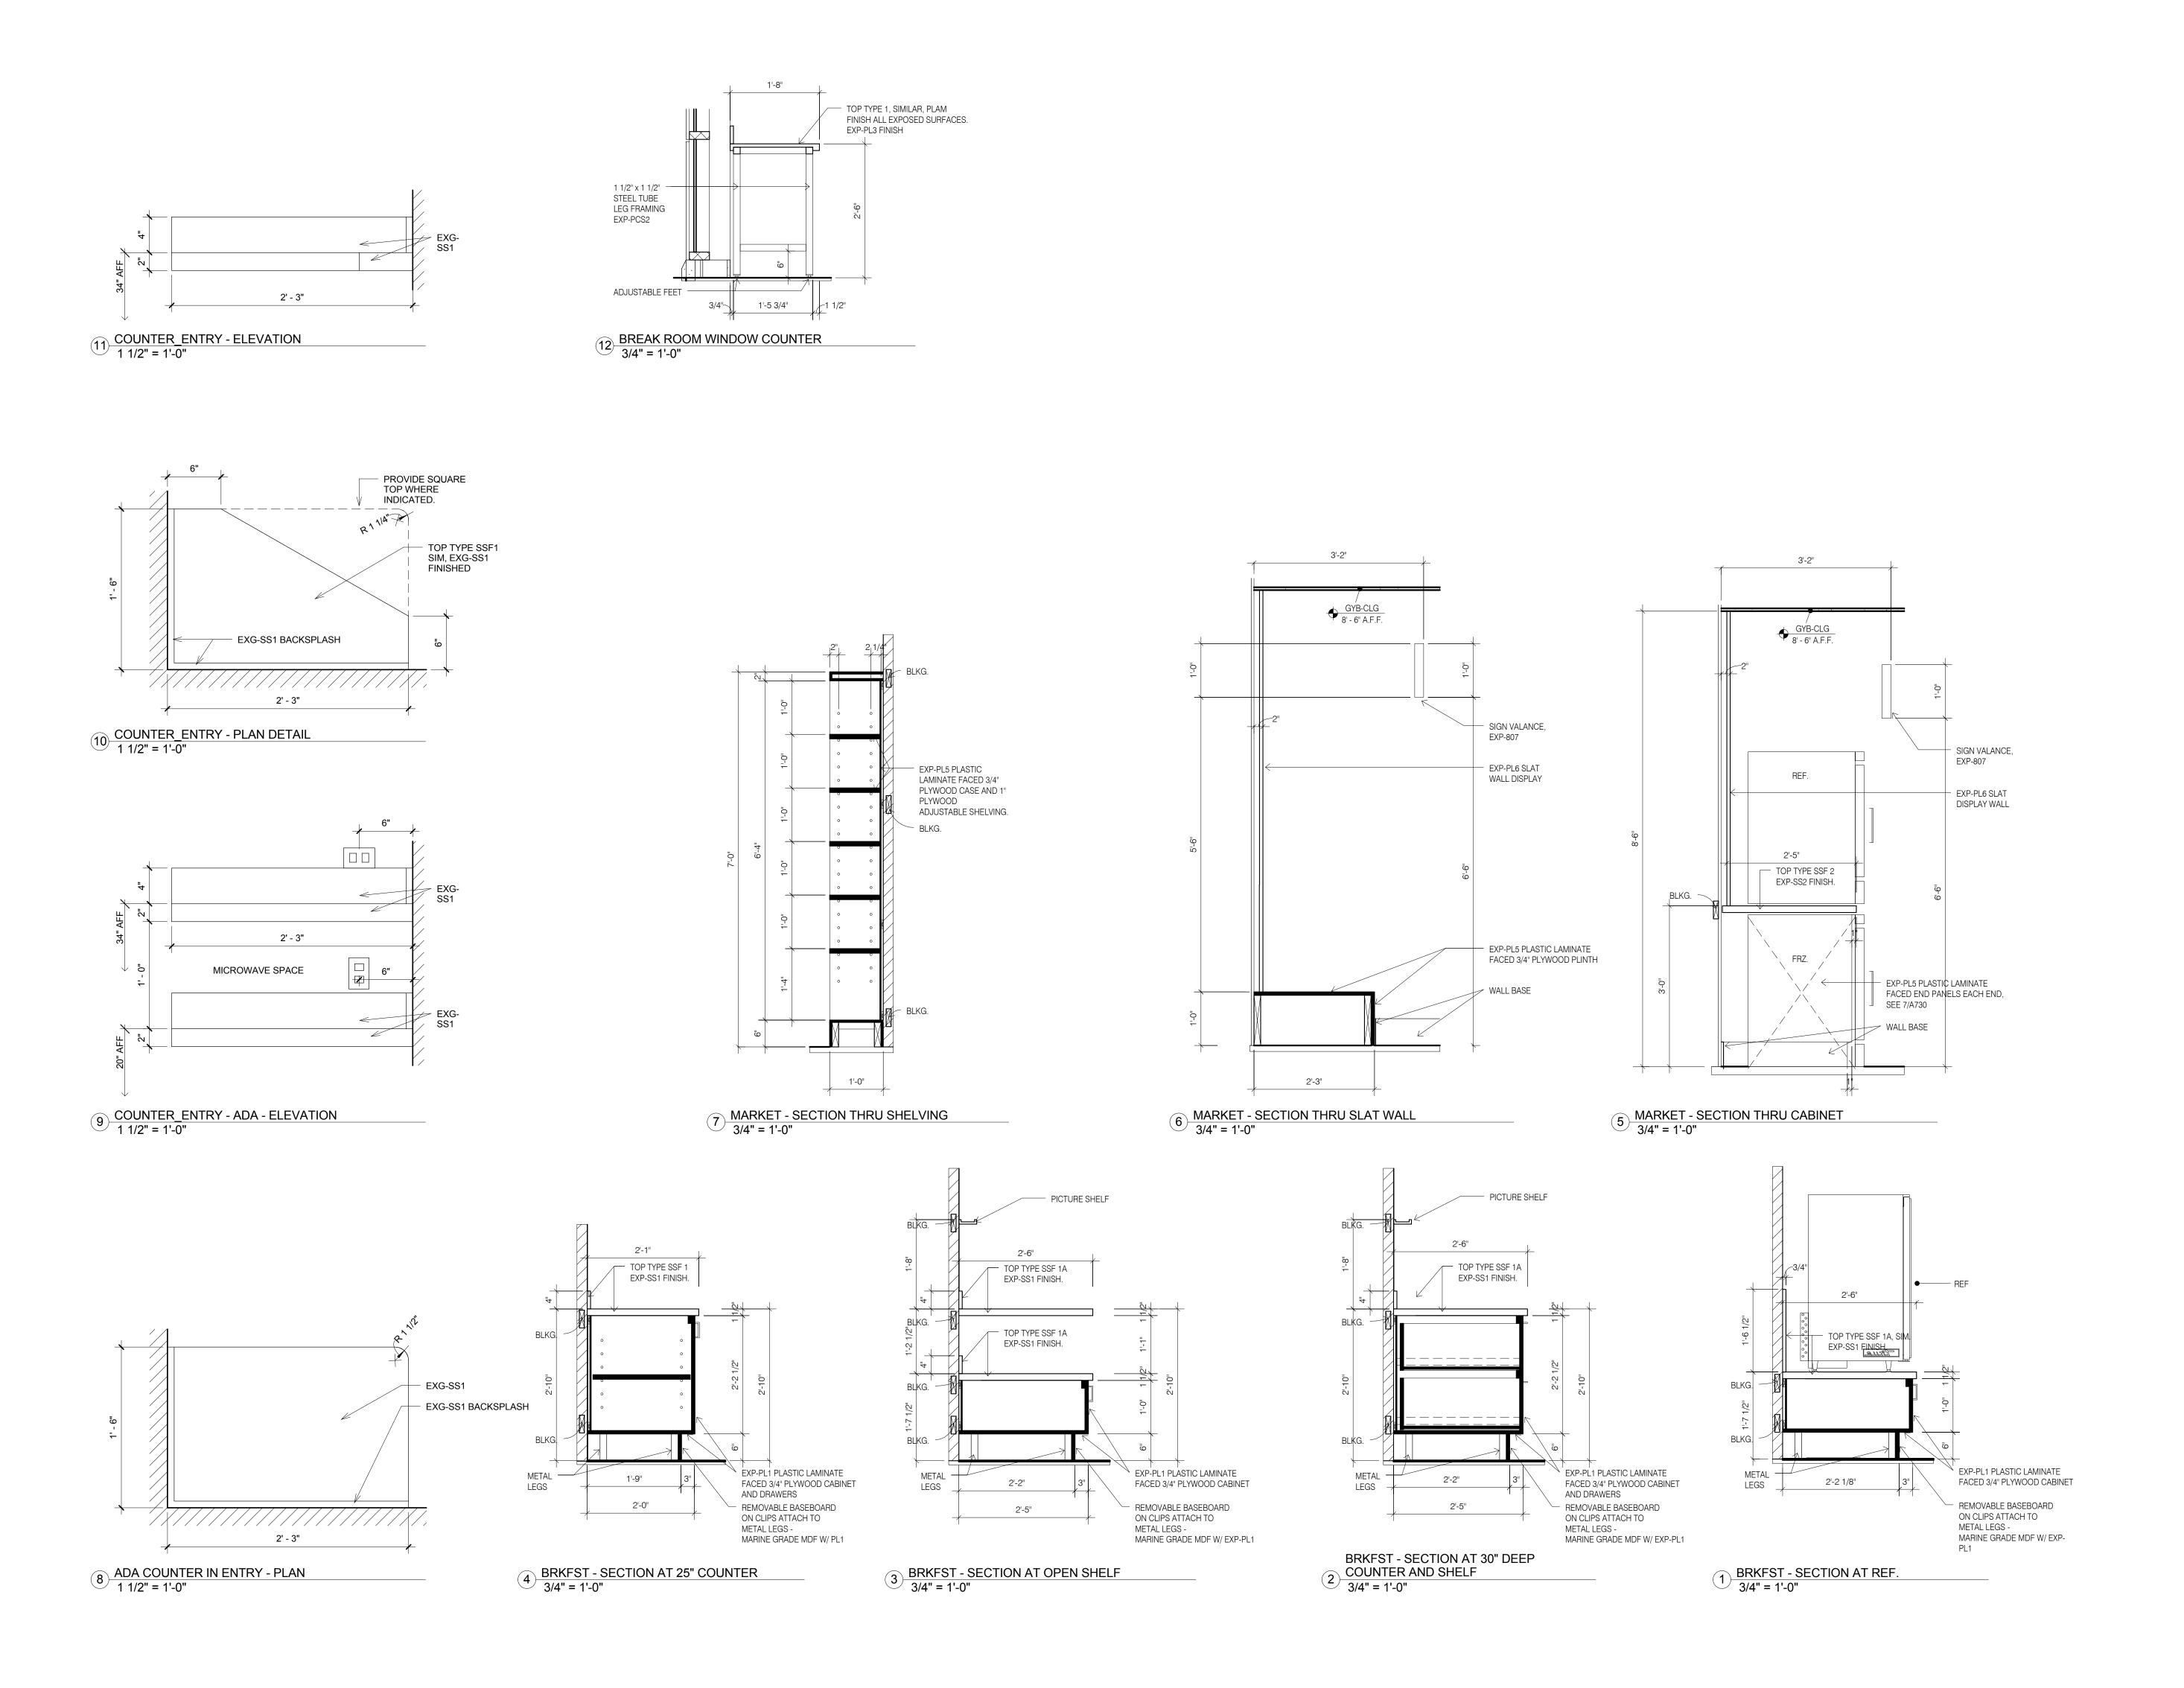



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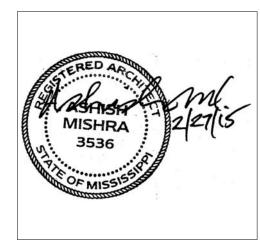
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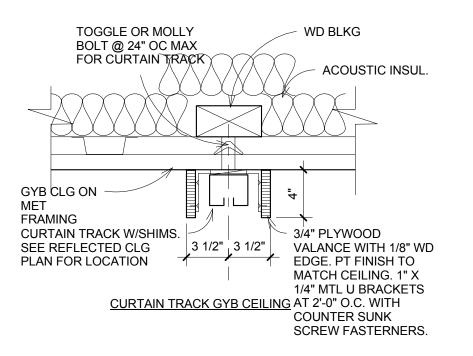
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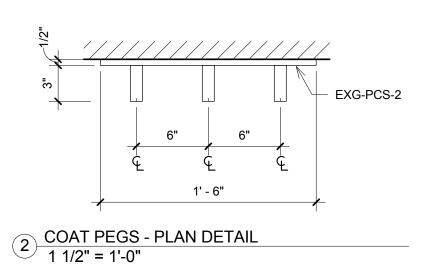
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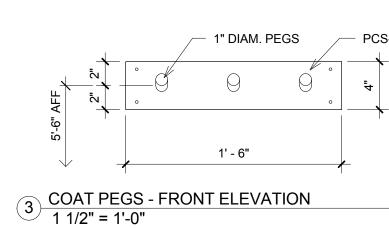
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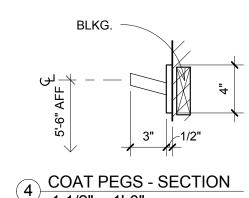
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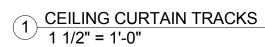











4 COAT PEGS - SECTION 1 1/2" = 1'-0"




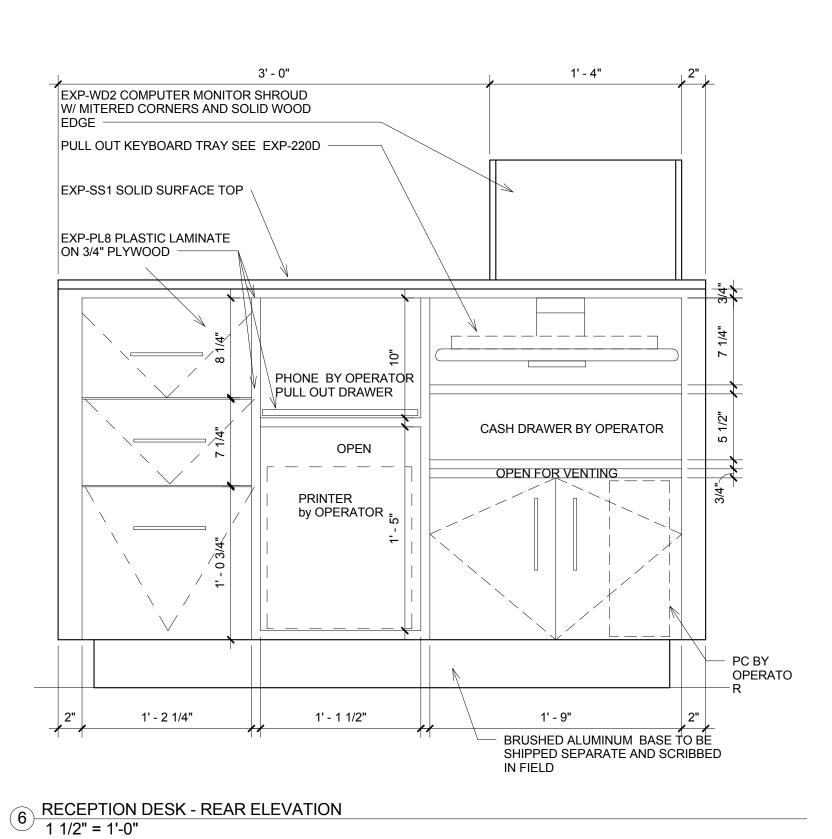

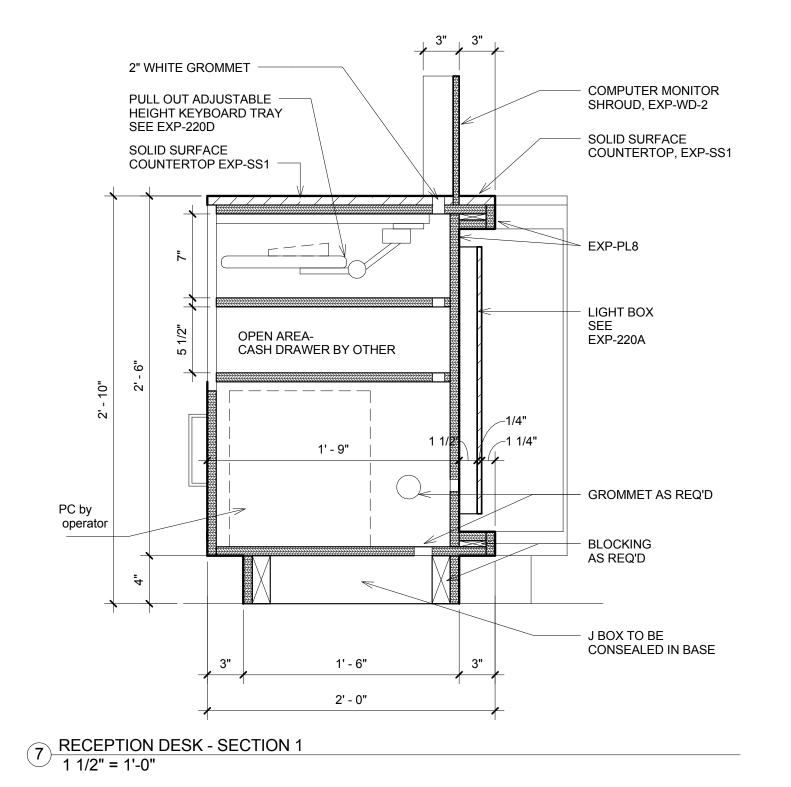

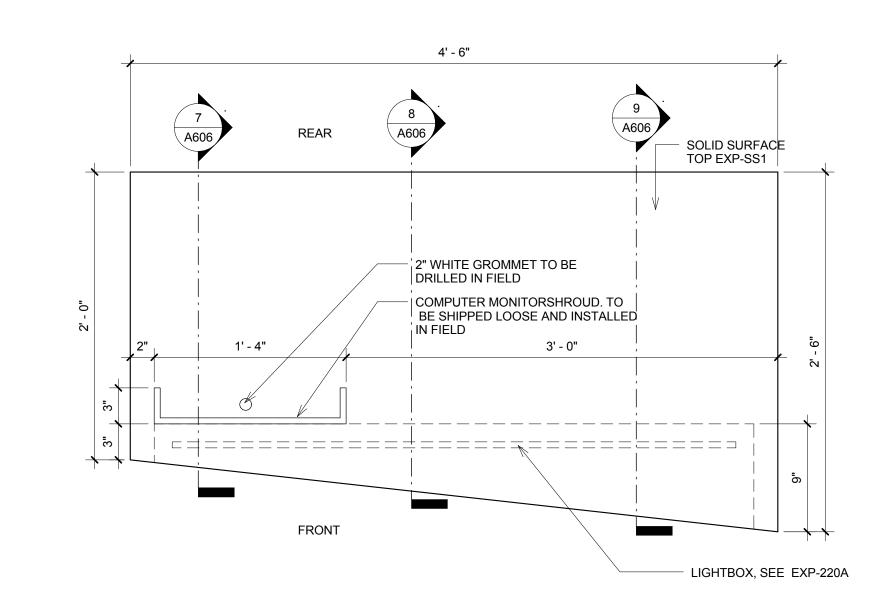

5 RECEPTION DESK - PLAN 1 1/2" = 1'-0"

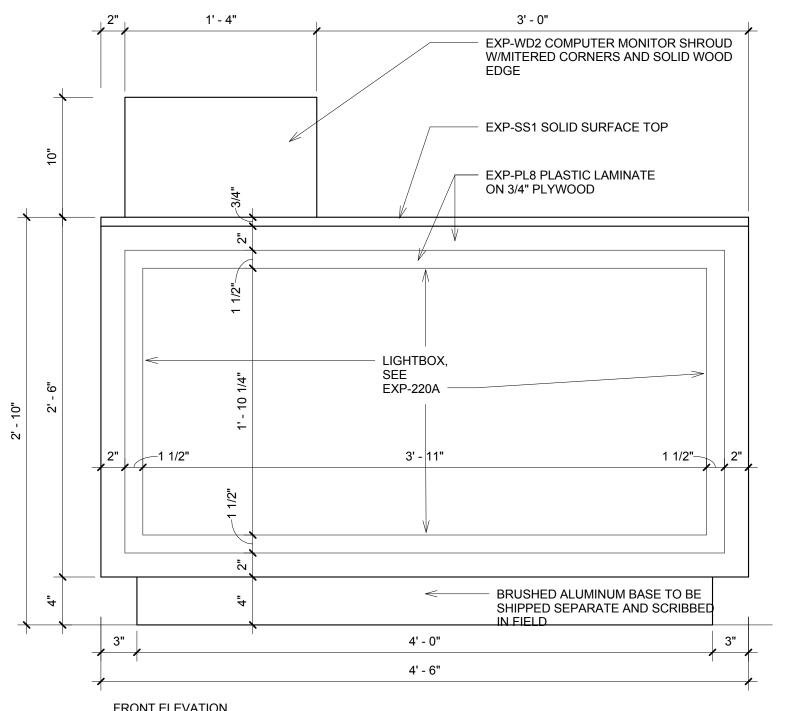



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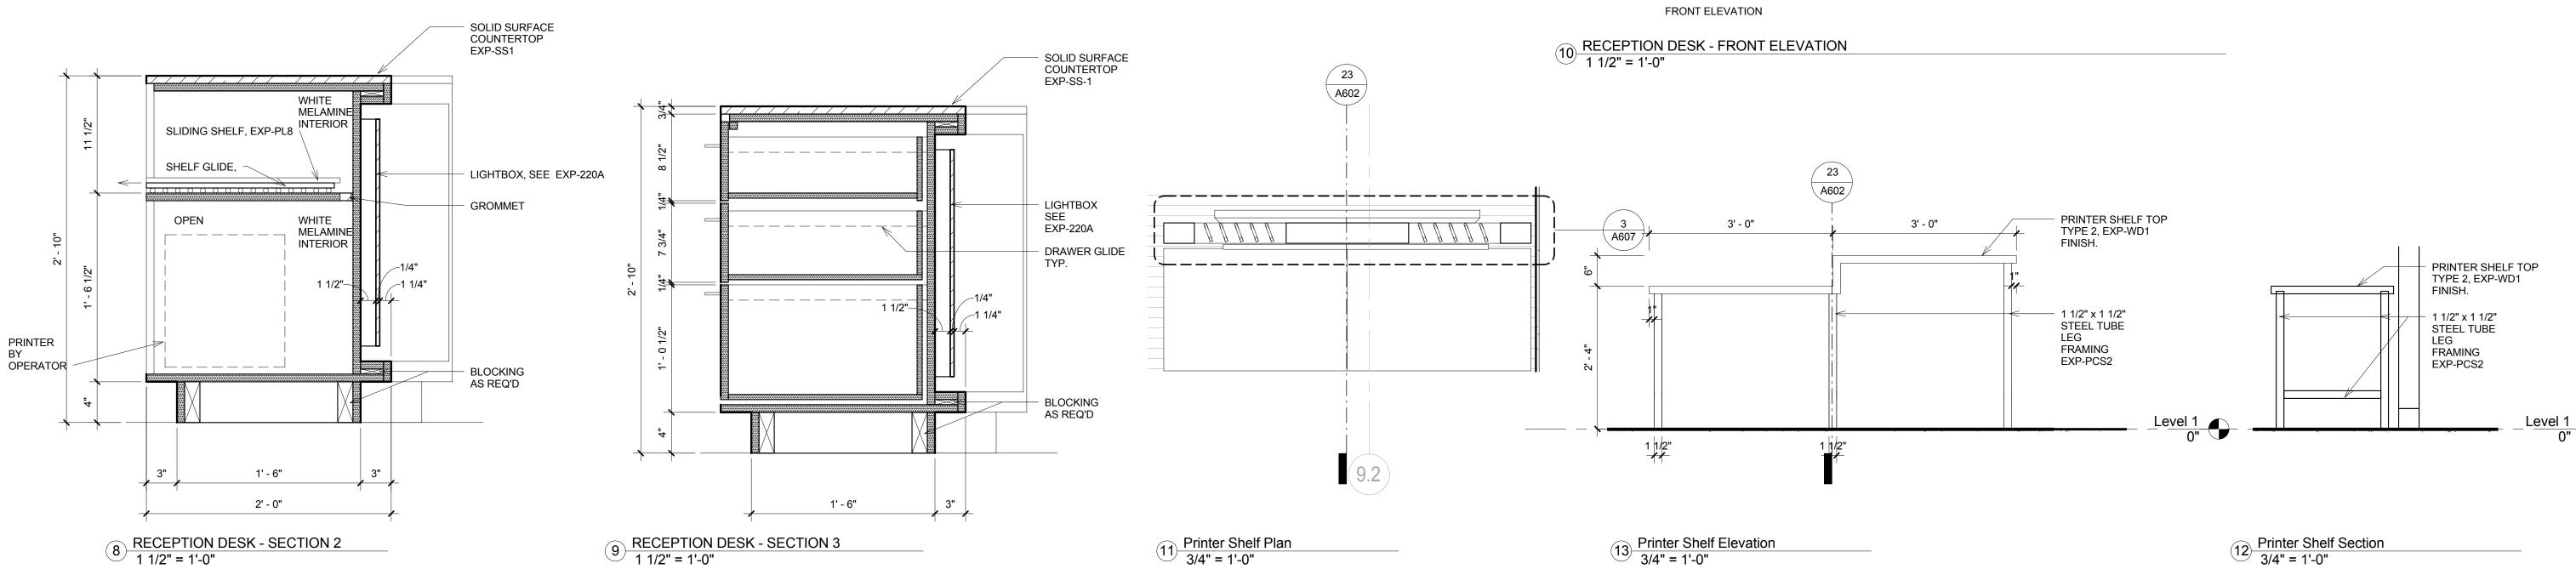
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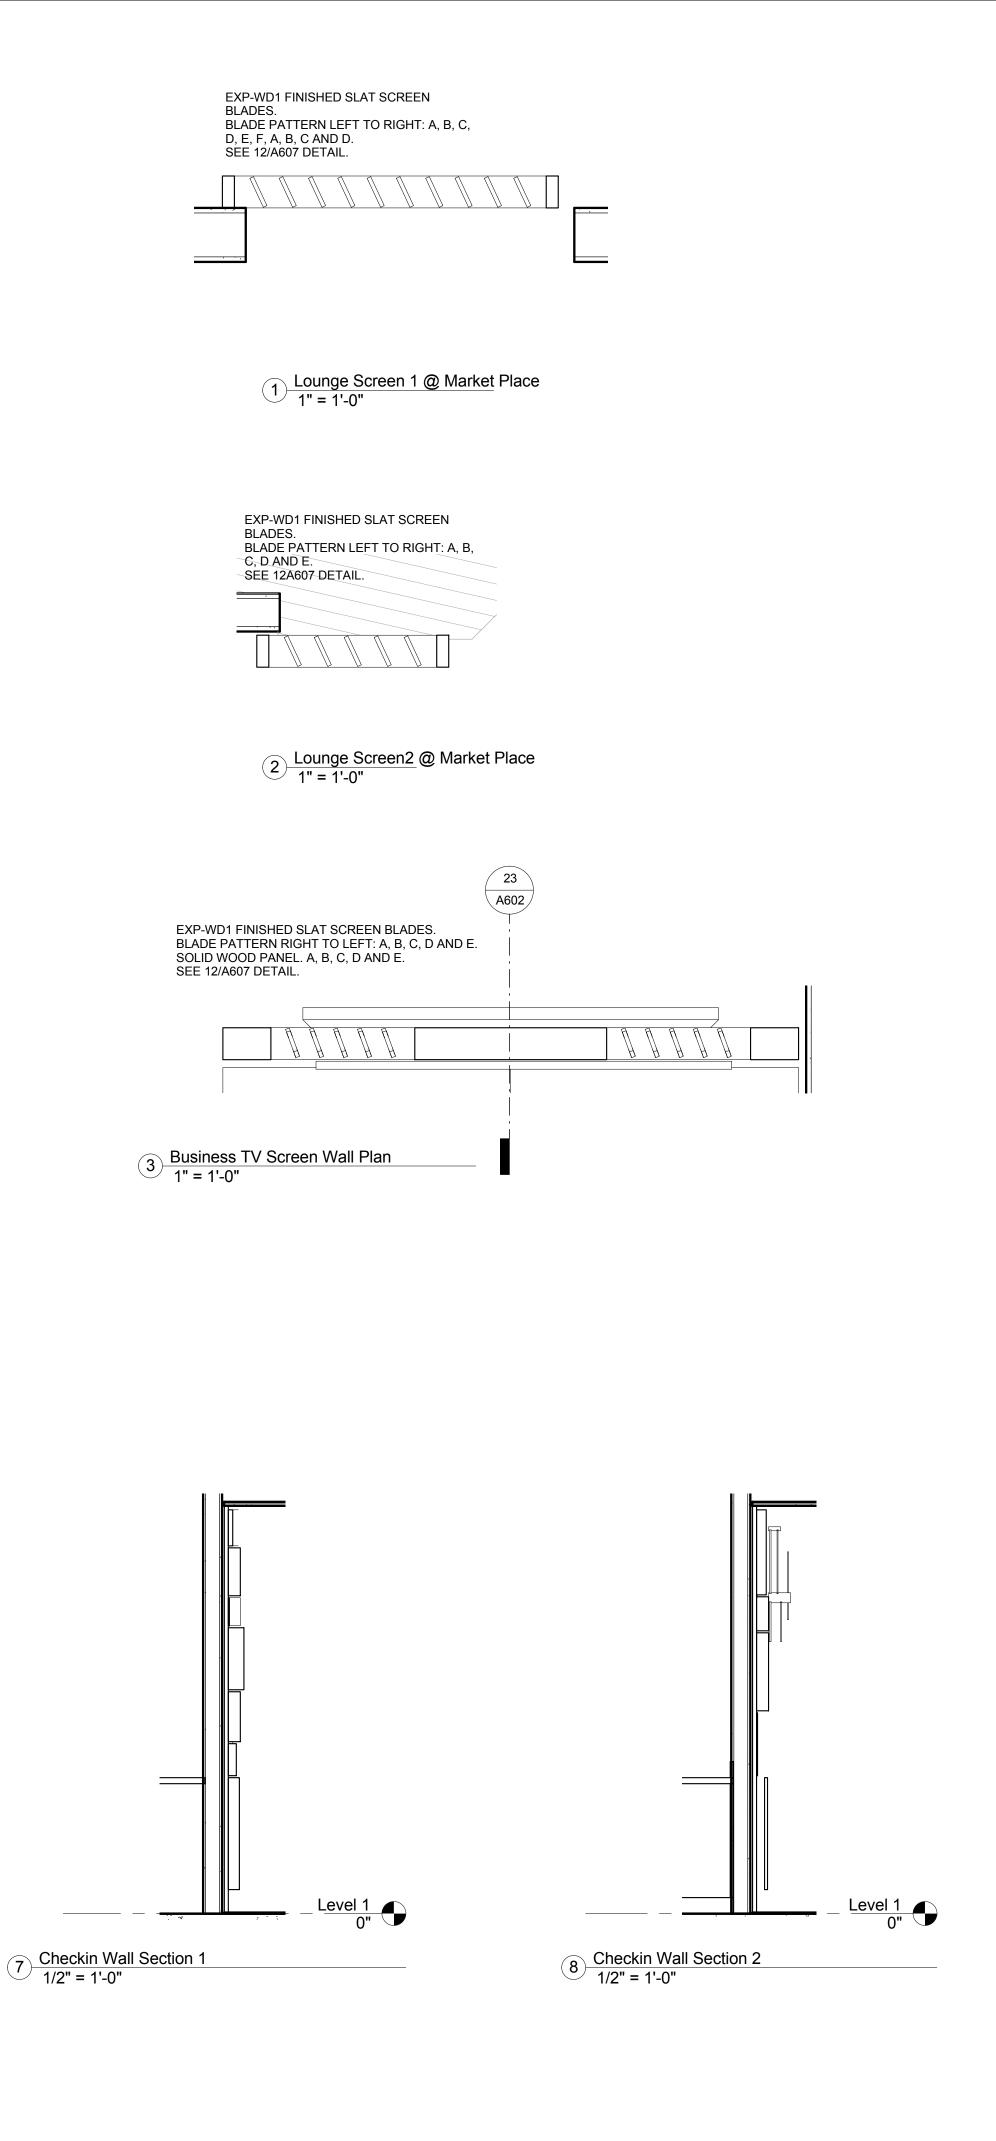
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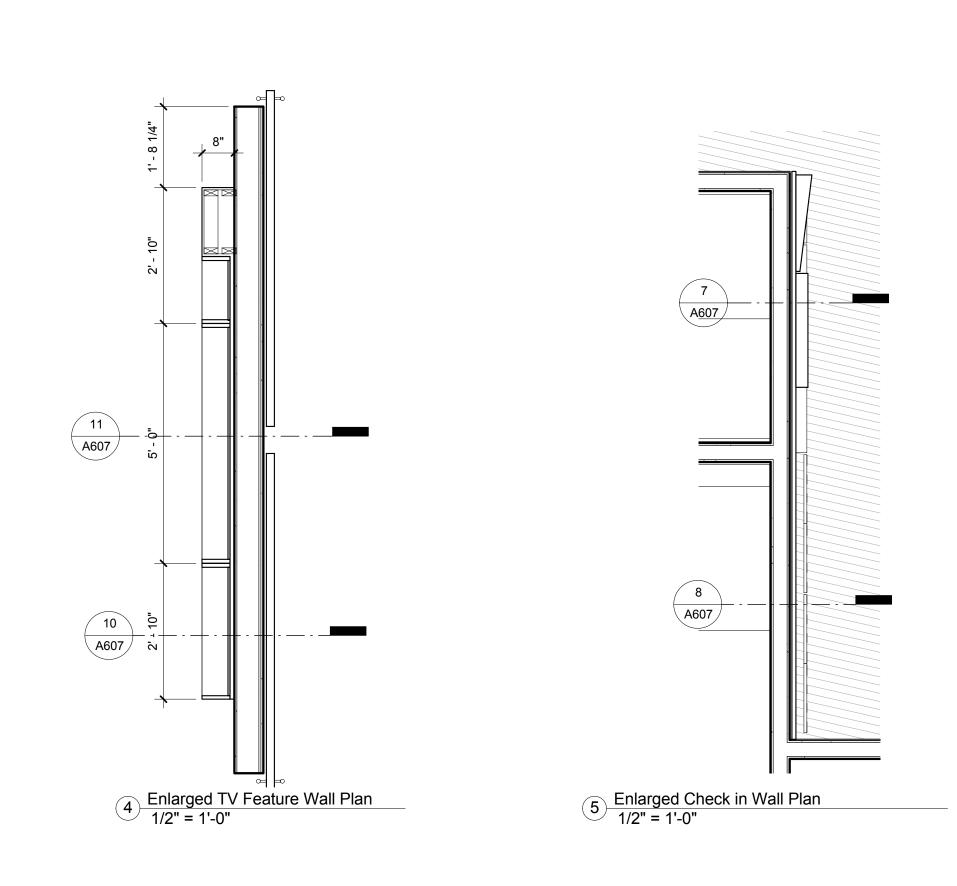
Casework Details


Construction Documents


Project No.	14-081	Sheet No.
Prepared by	Author	A COC
Checked by	Checker	A606
Date Feb.	. 27, 2015	








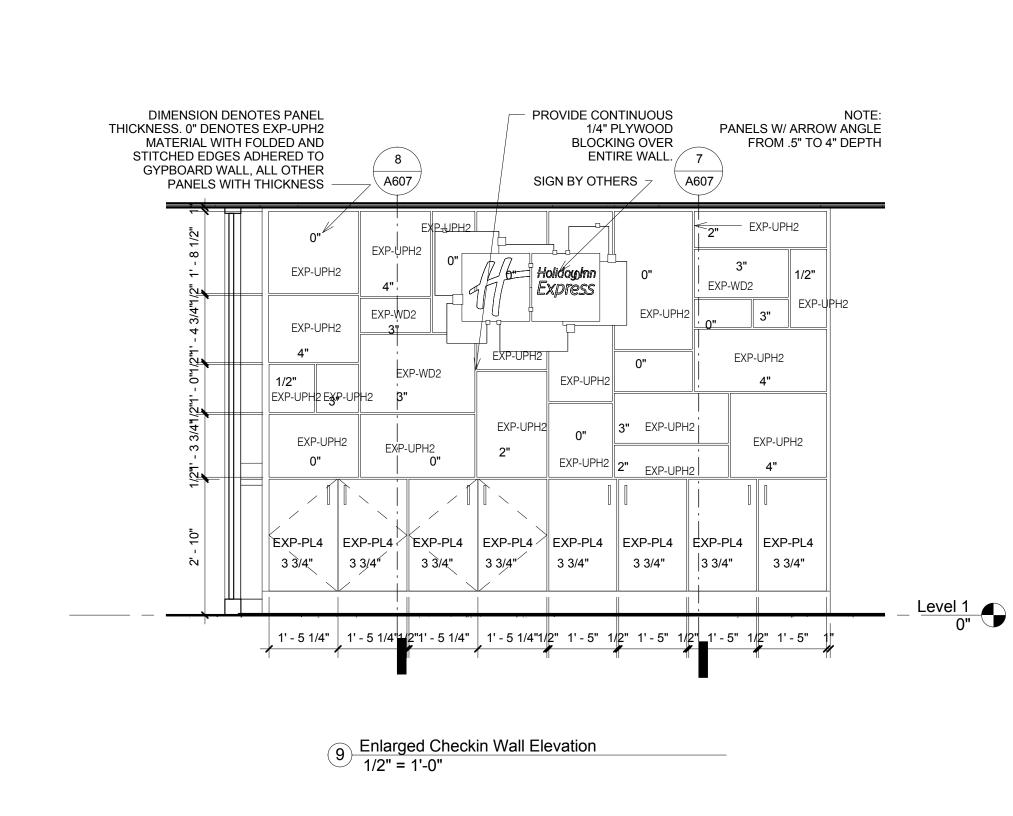

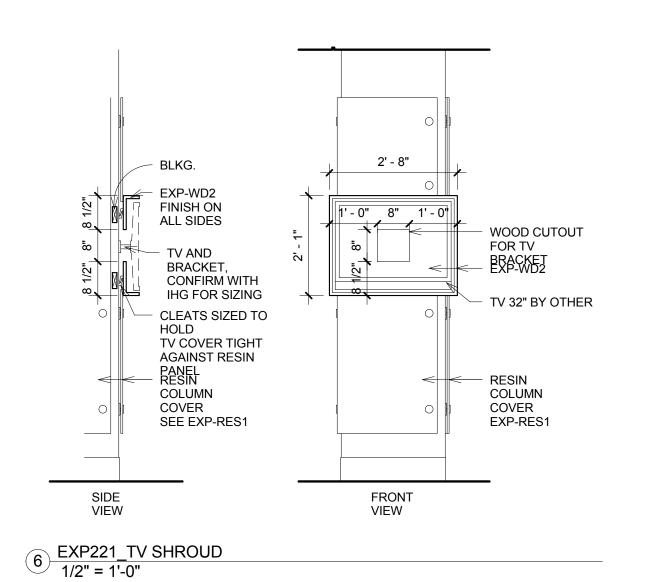

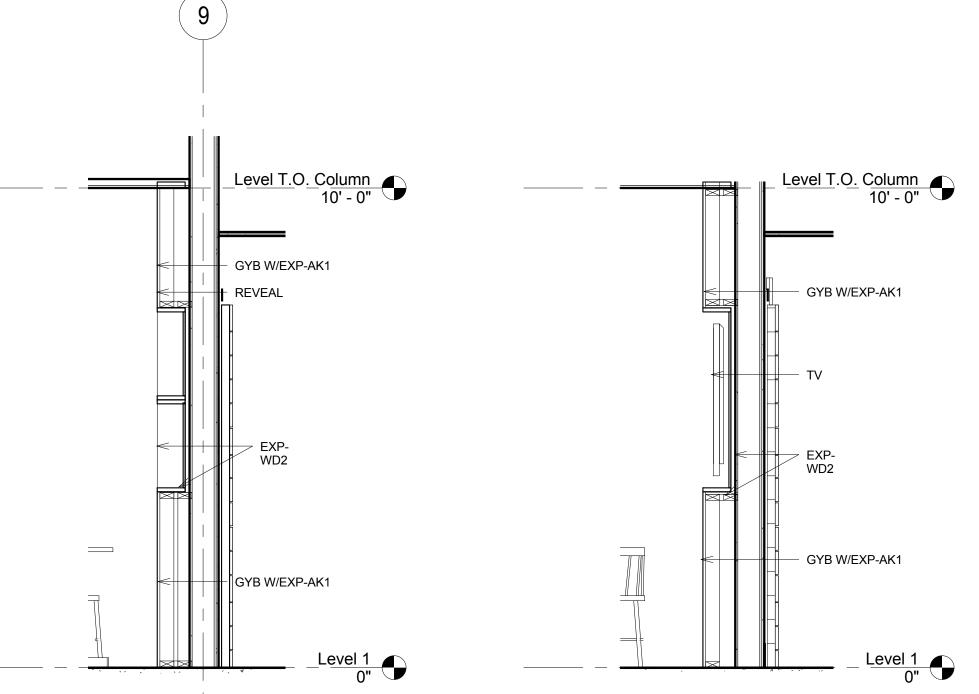


EXP-WD1 FINISHED SLAT SCREEN BLADES. PROVIDE SETBACK NOTCH TO RECESS INTO TOP AND BOTTOM RAILS.

11 TV Wall Section 2 1/2" = 1'-0"

> BLADE TYPE

BLADE

TYPE

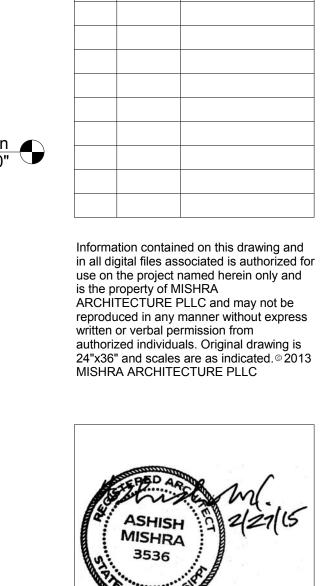

M I S H R A

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No. Date

Email: asoler@allied-engineers.com

REVISIONS

Description

Charlotte, NC 28277 Phone: (704) 542-7199

Shiva Southaven Inc.

**KEY PLAN** 

Holiday Inn Express & Suites

Lot 16 (Rev Lot 3) Southcrest Pkwy. Southcrest Subdivision Southaven, MS 38671

Drawing Title

Casework Details

Project No. 14-081
Prepared by Author Checked by Checker A607

Checked by Checker

Date Feb. 27, 2015

Author
Ado7

Review

Lounge Screen Blades
1/2" = 1'-0"

BLADE

TYPE

BLADE

TYPE

BLADE

TYPE

BLADE

TYPE

10 TV Wall Section 1 1/2" = 1'-0"

R8'-0 3/8"


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	Room Schedule						
Number	Name	Floor Finish	Base Finish	Wall Finish	Ceiling Finish	Ceiling Height	Nur
101	Vestibule	Tile	Tile	Ptd. Gyp. Bd.	Ptd. Gyp. Bd.	9'-0"	232
102	Checking	Carpet	Wood	Ptd. Gyp. Bd.	Ptd. Gyp. Bd.	8'-6"	233
103 104	Business Center Store	Carpet Tile	Wood Tile	Ptd. Gyp. Bd. Ptd. Gyp. Bd.	Ptd. Gyp. Bd. Ptd. Gyp. Bd.	9'-0" 9'-0"	234
105	Lifestyle Lounge	Tile	Tile	Ptd. Gyp. Bd.	ACT/Wood	10'-0"/9'-0"	236
106	Meeting	Carpet	Wood	Vinyl Wall Covering	Ptd. Gyp. Bd./Wood	9'-0"	237
107	Market	Tile	Tile	Ptd. Gyp. Bd.	Ptd. Gyp. Bd.	8'-6"	238
108	Breakfast Work Area	Tile	Tile	Vinyl Wall Covering	ACT/Ptd. Gyp. Bd.	8'-0"/9'-0" 9'-0"	301
109	Work Area Server	Carpet Sealed Conc.	Vinyl Vinyl	Ptd. Gyp. Bd. Ptd. Gyp. Bd.	Ptd. Gyp. Bd. Ptd. Gyp. Bd.	9'-0"	302
111	Pantry	Tile	Tile	Ptd. Gyp. Bd.	ACT	9'-0"	304
112	Sales	Carpet	Vinyl	Ptd. Gyp. Bd.	ACT	9'-0"	305
113	General Manager	Carpet	Vinyl	Ptd. Gyp. Bd.	ACT	9'-0"	306
114 115	Laundry  Mechanical	Tile Sealed Conc.	Tile	Ptd. Gyp. Bd. Ptd. Gyp. Bd.	ACT	9'-0" 9'-0"	307
116	Electrical	Sealed Conc.	Vinyl Vinyl	Ptd. Gyp. Bd.	Ptd. Gyp. Bd. Ptd. Gyp. Bd.	9'-0"	309
117	Storage	Tile	Tile	Ptd. Gyp. Bd.	Ptd. Gyp. Bd.	9'-0"	310
118	King	Tile/Carpet	Tile/Carpet	Ptd. Gyp. Bd.	Textured Gyp. Bd.	8'-0"/9'-0"	311
119	Elevators						312
120	Meeting Storage	Tile	Tile	Ptd. Gyp. Bd.	Ptd. Gyp. Bd.	9'-0"	313
121 122	Corridor Corridor	Tile Tile	Tile Tile	Vinyl Wall Covering Vinyl Wall Covering	ACT/Ptd, Cyp. Pd	9'-0" 8'-0"/9'-0"	314 315
123	Accessible Rollin X-Wide King	Tile/Carpet	Tile/Carpet	Ptd. Gyp. Bd.	ACT/Ptd. Gyp. Bd. Textured Gyp. Bd.	8'-0"/9'-0"	316
124	Unisex	Tile	Tile	Ptd. Gyp. Bd.	Ptd. Gyp. Bd.	8'-0"	317
125	Breakroom	Tile	Tile	Ptd. Gyp. Bd.	ACT	8'-0"	318
126	Ice	Tile	Tile	Ptd. Gyp. Bd.	ACT	9'-0"	319
127	Stairs #2	Sealed Conc.	Vinyl	Ptd. Gyp. Bd.			320
128 129	Storage	Sealed Conc. Sealed Conc.	Vinyl	Ptd. Gyp. Bd.	Ptd. Gyp. Bd.	9'-0" 9'-0"	321 322
130	Dryer Chute	Sealed Conc.	Vinyl Vinyl	Ptd. Gyp. Bd. Ptd. Gyp. Bd.	Ptd. Gyp. Bd. Ptd. Gyp. Bd.	9'-0"	323
131	Stairs #1	Sealed Conc.	Vinyl	Ptd. Gyp. Bd.	rta. Cyp. Ba.		324
132	Engineering	Tile	Vinyl	Ptd. Gyp. Bd.	Ptd. Gyp. Bd.	9'-0"	325
133	Fire Pump	Sealed Conc.	Vinyl	Ptd. Gyp. Bd.	Ptd. Gyp. Bd.	9'-0"	326
134	Elev. Equip.	Sealed Conc.	Vinyl	Ptd. Gyp. Bd.	Ptd. Gyp. Bd.	9'-0"	327
135 136	King Hearing Impaired King	Tile/Carpet Tile/Carpet	Tile/Carpet Tile/Carpet	Ptd. Gyp. Bd. Ptd. Gyp. Bd.	Textured Gyp. Bd. Textured Gyp. Bd.	8'-0"/9'-0" 8'-0"/9'-0"	328 329
137	Fitness	Carpet	Vinyl	Vinyl Wall Covering	ACT/Ptd. Gyp. Bd.	8'-0"/9'-0"	330
138	Pool Deck	Tile	Tile	Ptd. Gyp. Bd.	Ptd. Gyp. Bd.	8'-6"/9'-0"	331
139	Pool Vestibule	Tile	Tile	Ptd. Gyp. Bd.	Ptd. Gyp. Bd.	9'-0"	332
140	Guest Laundry	Tile	Tile	Ptd. Gyp. Bd.	Ptd. Gyp. Bd.	9'-0"	333
141	Pool Equip	Sealed Conc.	Vinyl	Ptd. Gyp. Bd.	Ptd. Gyp. Bd.	9'-0"	334
142 143	King Storage	Tile/Carpet Sealed Conc.	Tile/Carpet Vinyl	Ptd. Gyp. Bd. Ptd. Gyp. Bd.	Textured Gyp. Bd. Textured Gyp. Bd.	8'-0"/9'-0" 9'-0"	335 336
144	Janitor	Tile	Tile	Ptd. Gyp. Bd.	Ptd. Gyp. Bd.	8'-0"	337
145	Mens	Tile	Tile/Carpet	<u> </u>	ACT	9'-0"	338
146	Womens	Tile	Tile	Ptd. Gyp. Bd.	ACT	9'-0"	401
147	Elevator Lobby	Tile	Tile	Vinyl Wall Covering	Ptd. Gyp. Bd.	9'-0"	402
148 149	Carts Pool	Tile	Tile	Ptd. Gyp. Bd.	Ptd. Gyp. Bd.	9'-0" 8'-6"/9'-0"	403
150	Patio	Stamped Conc			Ptd. Gyp. Bd.	8-079-0	404
173	Dumpster	Sealed Conc.					406
201	Stairs #1	Sealed Conc.	Vinyl	Ptd. Gyp. Bd.			407
202	Chute	Sealed Conc.	Vinyl	Ptd. Gyp. Bd.	Ptd. Gyp. Bd.	9'-0"	408
203	King Wide	Tile/Carpet	Tile/Carpet	* * * * * * * * * * * * * * * * * * * *	Textured Gyp. Bd.	8'-0"/9'-0"	409
204	Double Queen King	Tile/Carpet Tile/Carpet	Tile/Carpet Tile/Carpet		Textured Gyp. Bd. Textured Gyp. Bd.	8'-0"/9'-0" 8'-0"/9'-0"	410
206	Double Queen	Tile/Carpet	Tile/Carpet	-	Textured Gyp. Bd.	8'-0"/9'-0"	412
207	Hearing Impaired King	Tile/Carpet	Tile/Carpet	* .	Textured Gyp. Bd.	8'-0"/9'-0"	413
208	Double Queen	Tile/Carpet	Tile/Carpet	-	Textured Gyp. Bd.	8'-0"/9'-0"	414
209	King Davida Overs	Tile/Carpet	Tile/Carpet	<u> </u>	Textured Gyp. Bd.	8'-0"/9'-0"	415
210	Double Queen King Suite	Tile/Carpet Tile/Carpet	Tile/Carpet Tile/Carpet	• •	Textured Gyp. Bd. Textured Gyp. Bd.	8'-0"/9'-0" 8'-0"/9'-0"	416 417
212	Double Queen	Tile/Carpet	Tile/Carpet		Textured Gyp. Bd.	8'-0"/9'-0"	417
213	King Suite	Tile/Carpet	Tile/Carpet		Textured Gyp. Bd.	8'-0"/9'-0"	419
214	Accessible King Suite	Tile/Carpet	Tile/Carpet	-	Textured Gyp. Bd.	8'-0"/9'-0"	420
215	King Suite	Tile/Carpet	Tile/Carpet	· · · · · · · · · · · · · · · · · · ·	Textured Gyp. Bd.	8'-0"/9'-0"	421
216	Hearing Impaired Double Queen Suite	Tile/Carpet	Tile/Carpet	Ptd. Gyp. Bd.	Textured Gyp. Bd.	8'-0"/9'-0"	422
217	King	Tile/Carpet	Tile/Carpet	Ptd. Gyp. Bd.	Textured Gyp. Bd.	8'-0"/9'-0"	423
218	Double Queen Suite	Tile/Carpet	Tile/Carpet		Textured Gyp. Bd.	8'-0"/9'-0"	425
219	Housekeeping	Tile/Carpet	Tile/Carpet	* * *	Textured Gyp. Bd.	8'-0"/9'-0"	426
220	Double Queen	Tile/Carpet	Tile/Carpet	· · · · · · · · · · · · · · · · · · ·	Textured Gyp. Bd.	8'-0"/9'-0"	427
221	King Flouritar Labby	Tile/Carpet	Tile/Carpet	ļ ·	Textured Gyp. Bd.	8'-0"/9'-0"	428
222 223	Elevator Lobby King	Tile Tile/Carpet	Tile Tile/Carpet	Vinyl Wall Covering Ptd. Gyp. Bd.	ACT/Ptd. Gyp. Bd. Textured Gyp. Bd.	8'-0"/8'-6" 8'-0"/9'-0"	429
223	Electrical/PBX	Sealed Conc.	Vinyl	Ptd. Gyp. Bd.	Ptd. Gyp. Bd.	9'-0"	430
225	King	Tile/Carpet	Tile/Carpet	<u> </u>	Textured Gyp. Bd.	8'-0"/9'-0"	431
226	Double Queen	Tile/Carpet	Tile/Carpet	Ptd. Gyp. Bd.	Textured Gyp. Bd.	8'-0"/9'-0"	433
227	King	Tile/Carpet	Tile/Carpet	<del>-</del> -	Textured Gyp. Bd.	8'-0"/9'-0"	434
228	Double Queen	Tile/Carpet	Tile/Carpet	<u> </u>	Textured Gyp. Bd.	8'-0"/9'-0"	435
229	King Hearing Impaired Double Queen	Tile/Carpet Tile/Carpet	Tile/Carpet Tile/Carpet	<u> </u>	Textured Gyp. Bd. Textured Gyp. Bd.	8'-0"/9'-0" 8'-0"/9'-0"	436
231	King	Tile/Carpet	Tile/Carpet	ļ ·	Textured Gyp. Bd.	8'-0"/9'-0"	437
		1 - 1				•	501

		Room	Schedule			
Number	Name	Floor Finish	Base Finish	Wall Finish	Ceiling Finish	Ceiling Height
232	Double Queen	Tile/Carpet	Tile/Carpet	Ptd. Gyp. Bd.	Textured Gyp. Bd.	8'-0"/9'-0"
233	King	Tile/Carpet	Tile/Carpet	Ptd. Gyp. Bd.	Textured Gyp. Bd.	8'-0"/9'-0"
234	Accessible X-Wide King	Tile/Carpet	Tile/Carpet	Ptd. Gyp. Bd.	Textured Gyp. Bd.	8'-0"/9'-0"
35	King	Tile/Carpet	Tile/Carpet	Ptd. Gyp. Bd.	Textured Gyp. Bd.	8'-0"/9'-0"
36	Stairs #2	Sealed Conc.	Vinyl	Ptd. Gyp. Bd.	· oxtanou oyp. Du.	
37	Ice	Tile	Tile	Ptd. Gyp. Bd.	Ptd. Gyp. Bd.	8'-0"
38	Corridor	Carpet	Carpet	Ptd. Gyp. Bd.	ACT/Ptd. Gyp. Bd.	8'-0"/8'-6"
301	Stairs #1	Sealed Conc.	Vinyl	Ptd. Gyp. Bd.	NOTH ta. Oyp. Ba.	0 0 70 0
301 302	Chute	Sealed Conc.	Vinyl	Ptd. Gyp. Bd.	Dtd Cyn Pd	9'-0"
					Ptd. Gyp. Bd.	
303	King Wide	Tile/Carpet	Tile/Carpet	Ptd. Gyp. Bd.	Textured Gyp. Bd.	8'-0"/9'-0"
304	Hearing Impaired Double Queen	·	Tile/Carpet	Ptd. Gyp. Bd.	Textured Gyp. Bd.	8'-0"/9'-0"
305	King	Tile/Carpet	Tile/Carpet	Ptd. Gyp. Bd.	Textured Gyp. Bd.	8'-0"/9'-0"
306	Double Queen	Tile/Carpet	Tile/Carpet	Ptd. Gyp. Bd.	Textured Gyp. Bd.	8'-0"/9'-0"
307	King	Tile/Carpet	Tile/Carpet	Ptd. Gyp. Bd.	Textured Gyp. Bd.	8'-0"/9'-0"
308	Double Queen	Tile/Carpet	Tile/Carpet	Ptd. Gyp. Bd.	Textured Gyp. Bd.	8'-0"/9'-0"
309	King	Tile/Carpet	Tile/Carpet	Ptd. Gyp. Bd.	Textured Gyp. Bd.	8'-0"/9'-0"
310	Double Queen	Tile/Carpet	Tile/Carpet	Ptd. Gyp. Bd.	Textured Gyp. Bd.	8'-0"/9'-0"
311	King Suite	Tile/Carpet	Tile/Carpet	Ptd. Gyp. Bd.	Textured Gyp. Bd.	8'-0"/9'-0"
312	Double Queen	Tile/Carpet	Tile/Carpet	Ptd. Gyp. Bd.	Textured Gyp. Bd.	8'-0"/9'-0"
313	King Suite	Tile/Carpet	Tile/Carpet	Ptd. Gyp. Bd.	Textured Gyp. Bd.	8'-0"/9'-0"
		· · · · · · · · · · · · · · · · · · ·	•		• • • • • • • • • • • • • • • • • • • •	
314	Acc. Double Queen Suite	Tile/Carpet	Tile/Carpet	* *	Textured Gyp. Bd.	8'-0"/9'-0"
315	King Suite	Tile/Carpet	Tile/Carpet	, , , , , , , , , , , , , , , , , , ,	Textured Gyp. Bd.	8'-0"/9'-0"
316	Double Queen Suite	Tile/Carpet		Ptd. Gyp. Bd.	Textured Gyp. Bd.	8'-0"/9'-0"
317	King	Tile/Carpet	Tile/Carpet	Ptd. Gyp. Bd.	Textured Gyp. Bd.	8'-0"/9'-0"
318	Double Queen Suite	Tile/Carpet	Tile/Carpet	· · · · · · · · · · · · · · · · · · ·	Textured Gyp. Bd.	8'-0"/9'-0"
319	Housekeeping	Tile	Tile	Ptd. Gyp. Bd.	Ptd. Gyp. Bd.	9'-0"
320	Double Queen	Tile/Carpet	Tile/Carpet	<u> </u>	Textured Gyp. Bd.	8'-0"/9'-0"
		•		· · · · · · · · · · · · · · · · · · ·		
321	King	Tile/Carpet	-	Ptd. Gyp. Bd.	Textured Gyp. Bd.	8'-0"/9'-0"
322	Elevator Lobby	Tile	Tile	Vinyl Wall Covering	ACT/Ptd. Gyp. Bd.	8'-0"/8'-6"
323	King	Tile/Carpet	Tile/Carpet	Ptd. Gyp. Bd.	Textured Gyp. Bd.	8'-0"/9'-0"
324	Electrical	Sealed Conc.	Vinyl	Ptd. Gyp. Bd.	Ptd. Gyp. Bd.	9'-0"
325	King	Tile/Carpet	Tile/Carpet	* .	Textured Gyp. Bd.	8'-0"/9'-0"
326	Double Queen	Tile/Carpet		Ptd. Gyp. Bd.	Textured Gyp. Bd.	8'-0"/9'-0"
327		·	<u> </u>	Ptd. Gyp. Bd.	· · · · · · · · · · · · · · · · · · ·	8'-0"/9'-0"
	King	Tile/Carpet		* * *	Textured Gyp. Bd.	
328	Double Queen	Tile/Carpet	Tile/Carpet	• •	Textured Gyp. Bd.	8'-0"/9'-0"
329	King	Tile/Carpet	Tile/Carpet	Ptd. Gyp. Bd.	Textured Gyp. Bd.	8'-0"/9'-0"
330	Double Queen	Tile/Carpet	Tile/Carpet	Ptd. Gyp. Bd.	Textured Gyp. Bd.	8'-0"/9'-0"
331	King	Tile/Carpet	Tile/Carpet	Ptd. Gyp. Bd.	Textured Gyp. Bd.	8'-0"/9'-0"
332	Double Queen	Tile/Carpet	Tile/Carpet	•	Textured Gyp. Bd.	8'-0"/9'-0"
333	King	Tile/Carpet	Tile/Carpet		Textured Gyp. Bd.	8'-0"/9'-0"
334	King X-Wide	Tile/Carpet	Tile/Carpet	-	Textured Gyp. Bd.	8'-0"/9'-0"
		•	· ·	· · · · · · · · · · · · · · · · · · ·		
335	Hearing Impaired King	Tile/Carpet	Tile/Carpet	7.	Textured Gyp. Bd.	8'-0"/9'-0"
336	Stairs #2	Sealed Conc.	Vinyl	Ptd. Gyp. Bd.		
337	Ice	Tile	Tile	Ptd. Gyp. Bd.	Ptd. Gyp. Bd.	8'-0"
338	Guest Corridor	Carpet	Carpet	Vinyl Wall Covering	ACT/Ptd. Gyp. Bd.	8'-0"/8'-6"
401	Stairs #1	Sealed Conc.	Vinyl	Ptd. Gyp. Bd.		
402	Chute	Sealed Conc.	Vinyl	Ptd. Gyp. Bd.	Ptd. Gyp. Bd.	9'-0"
103	King Wide	Tile/Carpet	Tile/Carpet	· · · · · · · · · · · · · · · · · · ·	Textured Gyp. Bd.	8'-0"/9'-0"
104	Double Queen	Tile/Carpet		Ptd. Gyp. Bd.	Textured Gyp. Bd.	8'-0"/9'-0"
		·		* *	• • • • • • • • • • • • • • • • • • • •	8'-0"/9'-0"
105	King	Tile/Carpet	Tile/Carpet	* *	Textured Gyp. Bd.	
406	Double Queen	Tile/Carpet	Tile/Carpet	71	Textured Gyp. Bd.	8'-0"/9'-0"
107	Hearing Impaired King	Tile/Carpet	Tile/Carpet	Ptd. Gyp. Bd.	Textured Gyp. Bd.	8'-0"/9'-0"
108	Double Queen	Tile/Carpet	Tile/Carpet	Ptd. Gyp. Bd.	Textured Gyp. Bd.	8'-0"/9'-0"
109	King	Tile/Carpet	Tile/Carpet	Ptd. Gyp. Bd.	Textured Gyp. Bd.	8'-0"/9'-0"
110	Hearing Impaired Double Queen	· · · · · · · · · · · · · · · · · · ·	Tile/Carpet		Textured Gyp. Bd.	8'-0"/9'-0"
<del>1</del> 11	Hearing Impaired King Suite	·	· · · · · · · · · · · · · · · · · · ·	• • • • • • • • • • • • • • • • • • • •	Textured Gyp. Bd.	8'-0"/9'-0"
		Tile/Carpet	Tile/Carpet		<u> </u>	
112	Double Queen	Tile/Carpet	Tile/Carpet	· ·	Textured Gyp. Bd.	8'-0"/9'-0"
113	King Suite	Tile/Carpet	Tile/Carpet	· · ·	Textured Gyp. Bd.	8'-0"/9'-0"
114	Accessible Double Queen	Tile/Carpet	Tile/Carpet	Ptd. Gyp. Bd.	Textured Gyp. Bd.	8'-0"/9'-0"
15	King Suite	Tile/Carpet	Tile/Carpet	Ptd. Gyp. Bd.	Textured Gyp. Bd.	8'-0"/9'-0"
116	Double Queen Suite	Tile/Carpet	Tile/Carpet	· · · · · · · · · · · · · · · · · · ·	Textured Gyp. Bd.	8'-0"/9'-0"
17	King	Tile/Carpet	Tile/Carpet	* *	Textured Gyp. Bd.	8'-0"/9'-0"
118	Double Queen Suite	Tile/Carpet	Tile/Carpet		Textured Gyp. Bd.	8'-0"/9'-0"
		·	-		· · · · · · · · · · · · · · · · · · ·	
119	Housekeeping	Tile	Tile	Ptd. Gyp. Bd.	Textured Gyp. Bd.	9'-0"
120	Double Queen	Tile/Carpet	Tile/Carpet	Ptd. Gyp. Bd.	Textured Gyp. Bd.	8'-0"/9'-0"
121	King	Tile/Carpet	Tile/Carpet		Textured Gyp. Bd.	8'-0"/9'-0"
122	Elevator Lobby	Tile	Tile	Vinyl Wall Covering	ACT/Ptd. Gyp. Bd.	8'-6"/9'-0"
123	King	Tile/Carpet	Tile/Carpet	-	Textured Gyp. Bd.	8'-0"/9'-0"
24	Electrical	Sealed Conc.	Vinyl	Ptd. Gyp. Bd.	Ptd. Gyp. Bd.	9'-0"
25	King	Tile/Carpet	Tile/Carpet	Ptd. Gyp. Bd.	Textured Gyp. Bd.	8'-0"/9'-0"
		•		* -	* *	
26	Double Queen	Tile/Carpet	Tile/Carpet	* *	Textured Gyp. Bd.	8'-0"/9'-0"
-27	King	Tile/Carpet	Tile/Carpet	Ptd. Gyp. Bd.	Textured Gyp. Bd.	8'-0"/9'-0"
28	Double Queen	Tile/Carpet	Tile/Carpet	Ptd. Gyp. Bd.	Textured Gyp. Bd.	8'-0"/9'-0"
29	King	Tile/Carpet	Tile/Carpet	•	Textured Gyp. Bd.	8'-0"/9'-0"
130	Double Queen	Tile/Carpet	Tile/Carpet		Textured Gyp. Bd.	8'-0"/9'-0"
		· · · · · · · · · · · · · · · · · · ·	-	* .	•	
31	King	Tile/Carpet		Ptd. Gyp. Bd.	Textured Gyp. Bd.	8'-0"/9'-0"
32	Double Queen	Tile/Carpet	-	Ptd. Gyp. Bd.	Textured Gyp. Bd.	8'-0"/9'-0"
133	King	Tile/Carpet	Tile/Carpet	Ptd. Gyp. Bd.	Textured Gyp. Bd.	8'-0"/9'-0"
134	KIng X-Wide	Tile/Carpet		Ptd. Gyp. Bd.	Textured Gyp. Bd.	8'-0"/9'-0"
35	King	Tile/Carpet	•	Ptd. Gyp. Bd.	Textured Gyp. Bd.	8'-0"/9'-0"
36	Stairs #2	Sealed Conc.	Vinyl	Ptd. Gyp. Bd.		
			+ -	· · · · · · · · · · · · · · · · · · ·	Dtd O D-1	01.0"
437	Ice	Tile	Tile	Ptd. Gyp. Bd.	Ptd. Gyp. Bd.	8'-0"
438	Guest Corrdior	Carpet	Carpet	Vinyl Wall Covering	ACT/Ptd. Gyp. Bd.	8'-0"/8'-6"
501	Stairs #1					

Stairs #1

Room Schedule

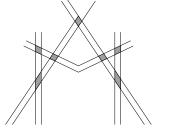

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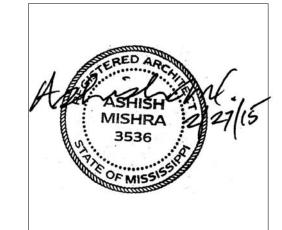
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	REVI	SIONS
No.	Date	Description

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KEY PLAN

### FINISH LEGEND

LOBBY, SITTING, GREAT ROOM.

ARCHITECT/OWNER.

- 1. ALL GUEST ROOM BATHROOMS WILL HAVE CERAMIC TILE FLOORS.
- 2. ALL PUBLIC BATHROOMS WILL HAVE CERAMIC TILE FLOORS.
- 3. VINYL WALL COVERING WILL BE PERFORATED AS PER THE PROJECT MANUAL.
- 4. ALL PUBLIC AREAS WILL HAVE CROWN MOULDING. THESE AREAS INCLUDE CORRIDORS, ELEVATOR LOBBIES, MEETING ROOM, FITNESS CENTER,
- 5. ALL WET AREAS INCLUDING GUEST BATHROOMS, PTAC UNIT WALLS AND
- LAUNDRY TO BE INSTALLED WITH MOISTURE RESISTANT GYPSUM BOARD.

  6. ACT II IS A MOISTURE-RESISTANT ACOUSTICAL CEILING TILE.
- 7. PUBLIC AREAS INCLUDING CORRIDORS, ELEVATOR LOBBIES, MEETING ROOM, FITNESS CENTER, LOBBY, SITTING, GREAT ROOM TO BE INSTALLED WITH TEGULAR ACOUSTICAL CEILING TILES WITH REVEAL AS APPROVED BY
- 8. ALL WET AREAS, INCLUDING GUEST BATHROOMS, POOL WILL HAVE TILE WITH A MINIMUM SLIP RESISTANCE OF 0.60 ON THE ASTM C-1028 TEST WET AND DRY.

Shiva Southaven

### Holiday Inn Express & Suites

Lot 16 (Rev Lot 3) Southcrest Pkwy. Southcrest Subdivision Southaven, MS 38671

Drawing Title

Room Schedule

Phase
Construction Documents

Project No.	14-081	Sheet No.
Prepared by	Author	A 704
Checked by	Checker	A701
<sup>Date</sup> Feb	. 27, 2015	


Review

3/2/2015 5:16:16 AN

				Door	Thickne			
Mark	Width	Height	Door Types	Material	SS	Material	Fire Rating	Comments
101A	12' - 0"	10' - 0"	ASD	ALUM.		ALUM.		Panic Hardware w/ Card Key
101B	12' - 0"	10' - 0"	ASD	ALUM.		ALUM.		Panic Hardware w/ Card Key
104	3' - 0"	6' - 8"	DP_F	WOOD	1 3/4"	H.M.	20 MINS.	Lockset
106A	6' - 0"	7' - 6"	DP_TU_WD	WOOD	2"	H.M.		Meeting Room sliding door.
106B	6' - 0"	7' - 6"	DP_TU_WD	WOOD	2"	H.M.	00.14110	Meeting Room sliding door.
106C	3' - 0"	6' - 8"	DP_N FLUSH	WOOD	1 3/4"	H.M.	20 MINS.	Panic Hardware
108A	7' - 0"	8' - 0"	DP-F-SD-M	WOOD	3"	H.M.		
108B	7' - 0"	8' - 0"	DP-F-SD-M	WOOD	3"	H.M.		
109	3' - 0"	6' - 8"	DP_F	WOOD	1 3/4"	H.M.	20 MINS.	
110	3' - 0"	6' - 8"	DP_F	WOOD	1 3/4"	H.M.	00 14110	
111 112	3' - 0"	6' - 8" 6' - 8"	DP_F	WOOD	1 3/4" 1 3/4"	H.M.	20 MINS.	
113	3' - 0"	6' - 8"	DP_F DP_F	WOOD	1 3/4"	H.M.		
114	4' - 0"	6' - 8"	DP_F	WOOD	1 3/4"	H.M.	20 MINS.	
115	4' - 0"	6' - 8"	DP_F	WOOD	1 3/4"	H.M.	20 MINS.	Lockset
116	4' - 0"	6' - 8"	DP_F	WOOD	1 3/4"	H.M.	20 MINS.	Lockset
117	3' - 0"	6' - 8"	DP_F	WOOD	1 3/4"	H.M.	20 MINS.	Lockset
120	3' - 0"	6' - 8"	DP_F	WOOD	1 3/4"	H.M.	20 MINS.	Lockset
122A	3' - 0"	6' - 8"	DP-FGAS	ALUM.		ALUM.	20 MINS.	Panic Hardware w/ Card Key
122B	3' - 0"	6' - 8"	DP-FGAS	ALUM.		ALUM.		Panic Hardware w/ Card Key
124	3' - 0"	6' - 8"	DP_F	WOOD	1 3/4"	H.M.		
127A	3' - 0"	6' - 8"	DP-N	H.M.	1 3/4"	H.M.	90 MINS.	Panic Hardware
127B	3' - 0"	6' - 8"	DP-N	H.M.	1 3/4"	H.M.	20 MINIO	Panic Hardware w/ Card Key
128 129	3' - 0" 2' - 0"	6' - 8" 6' - 8"	DP_F DP_F	WOOD	1 3/4" 1 3/4"	H.M.	20 MINS.	
130	3' - 0"	6' - 8"	DP_F	WOOD	1 3/4"	H.M.	45 MINS.	
131A	3' - 0"	6' - 8"	DP_N	H.M.	1 3/4"	H.M.	90 MINS.	Panic Hardware
131B	3' - 0"	6' - 8"	DP-N	H.M.	1 3/4"	H.M.		Panic Hardware w/ Card Key
131C	3' - 0"	6' - 8"	DP-FGA	ALUM.	2"	ALUM.		Panic Hardware w/ Card Key
131D	3' - 0"	6' - 8"	DP_F	WOOD	1 3/4"	H.M.	45 MINS.	
132	3' - 0"	6' - 8"	DP_F	WOOD	1 3/4"	H.M.	20 MINS.	
133A	3' - 0"	6' - 8"	DP_F	WOOD	1 3/4"	H.M.	45 MINS.	
133B	4' - 0"	7' - 0"	DP_F	H.M.	1 3/4"	H.M.		
134	3' - 0"	6' - 8"	DP_F	WOOD	1 3/4"	H.M.	45 MINS.	Lockset
137A	3' - 0"	7' - 0"	DP-FGA	WOOD	1 3/4"	H.M.		Panic Hardware
137B 138	3' - 0" 3' - 0"	7' - 0" 6' - 8"	DP-FGA	WOOD ALUM.	1 3/4"	H.M. ALUM.		Panic Hardware Panic Hardware w/ Card Key
130 139A	3' - 0"	6' - 8"	DP-FGA	ALUM.	_	ALUM.	20 MINS.	Panic Hardware W/ Card Key
139B	3' - 0"	6' - 8"	DP-FGA	ALUM.		ALUM.	20 MINS.	Panic Hardware
140	3' - 0"	6' - 8"	DP_F	WOOD	1 3/4"	H.M.		
141	4' - 0"	6' - 8"	DP_F	ALUM.	1 3/4"	ALUM.	20 MINS.	Lockset
143	4' - 0"	6' - 8"	DP_F	WOOD	1 3/4"	H.M.		
144	2' - 6"	6' - 8"	DP_F	WOOD	1 3/4"	H.M.		
145	3' - 0"	6' - 8"	DP_F	WOOD	1 3/4"	H.M.	20 MINS.	
146	3' - 0"	6' - 8"	DP_F	WOOD	1 3/4"	H.M.	20 MINS.	
201	3' - 0"	6' - 8"	DP-N	WOOD	1 3/4"	H.M.	90 MINS.	Panic Hardware
202 219	3' - 0"	6' - 8" 6' - 8"	DP_F	WOOD	1 3/4"	H.M.	45 MINS.	
219 224	3' - 0"	6' - 8"	DP_F DP_F	WOOD	1 3/4"	H.M.	20 MINS.	
224 236	3' - 0"	6' - 8"	DP_F DP-N	WOOD	1 3/4"	H.M.	90 MINS.	Panic Hardware
301	3' - 0"	6' - 8"	DP-N	WOOD	1 3/4"	H.M.	90 MINS.	Panic Hardware
302	3' - 0"	6' - 8"	DP_F	WOOD	1 3/4"	H.M.	20 MINS.	
319	3' - 0"	6' - 8"	DP_F	WOOD	1 3/4"	H.M.	20 MINS.	
324	3' - 0"	6' - 8"	DP_F	WOOD	1 3/4"	H.M.	20 MINS.	
336	3' - 0"	6' - 8"	DP-N	WOOD	1 3/4"	H.M.	90 MINS.	Panic Hardware
401	3' - 0"	6' - 8"	DP-N	WOOD	1 3/4"	H.M.	90 MINS.	Panic Hardware
402	3' - 0"	6' - 8"	DP_F	WOOD	1 3/4"	H.M.	20 MINS.	
419	3' - 0"	6' - 8"	DP_F	WOOD	1 3/4"	H.M.	20 MINS.	D II
436	3' - 0"	6' - 8"	DP-N	WOOD	1 3/4"	H.M.	90 MINS.	Panic Hardware
501 Δ	3' - 0" 3' - 0"	6' - 8" 6' - 8"	DP_F DP-G	H.M. WOOD	1 3/4"	H.M.	20-Minute	
<u>А</u> В	3' - 0"	6' - 8"	DP-G DP F	WOOD	1 3/4"	H.M.	20-WIII IULE	
<u>Б</u> С	3' - 4"	6' - 8"	DP_F DP-F-SD	WOOD	1 1/2"	H.M.		
C1	3' - 0"	6' - 8"	DP-F-SD-B	WOOD	1 1/2"	H.M.		Guestroom Bathroom sliding door, NT2.
C I	i -	- 1	<del>-</del>		I .	T. Control of the Con	1	<del> </del>
	3' - 0"	6' - 8"	DP_F	WOOD	2"	H.M.		Double acting Guestroom connecting door.
D G	3' - 0" 5' - 0"	6' - 8" 8' - 0"	DP_F DUM	WOOD WOOD	2" 2"	H.M. H.M.		Double acting Guestroom connecting door.  Dumpster-Metal with Privacy Panel

	W	indow Sched	ule	
Type Mark	Width	Height	Sill Height	Count
W1	8' - 0"	4' - 5"	2' - 7"	115
W3	8' - 0"	6' - 8"	3"	10
W4	5' - 0"	6' - 0"	1' - 0"	13
W5	4' - 0"	6' - 0"	1' - 0"	13
W6	5' - 0"	6' - 8"	2"	1

Grand total: 152

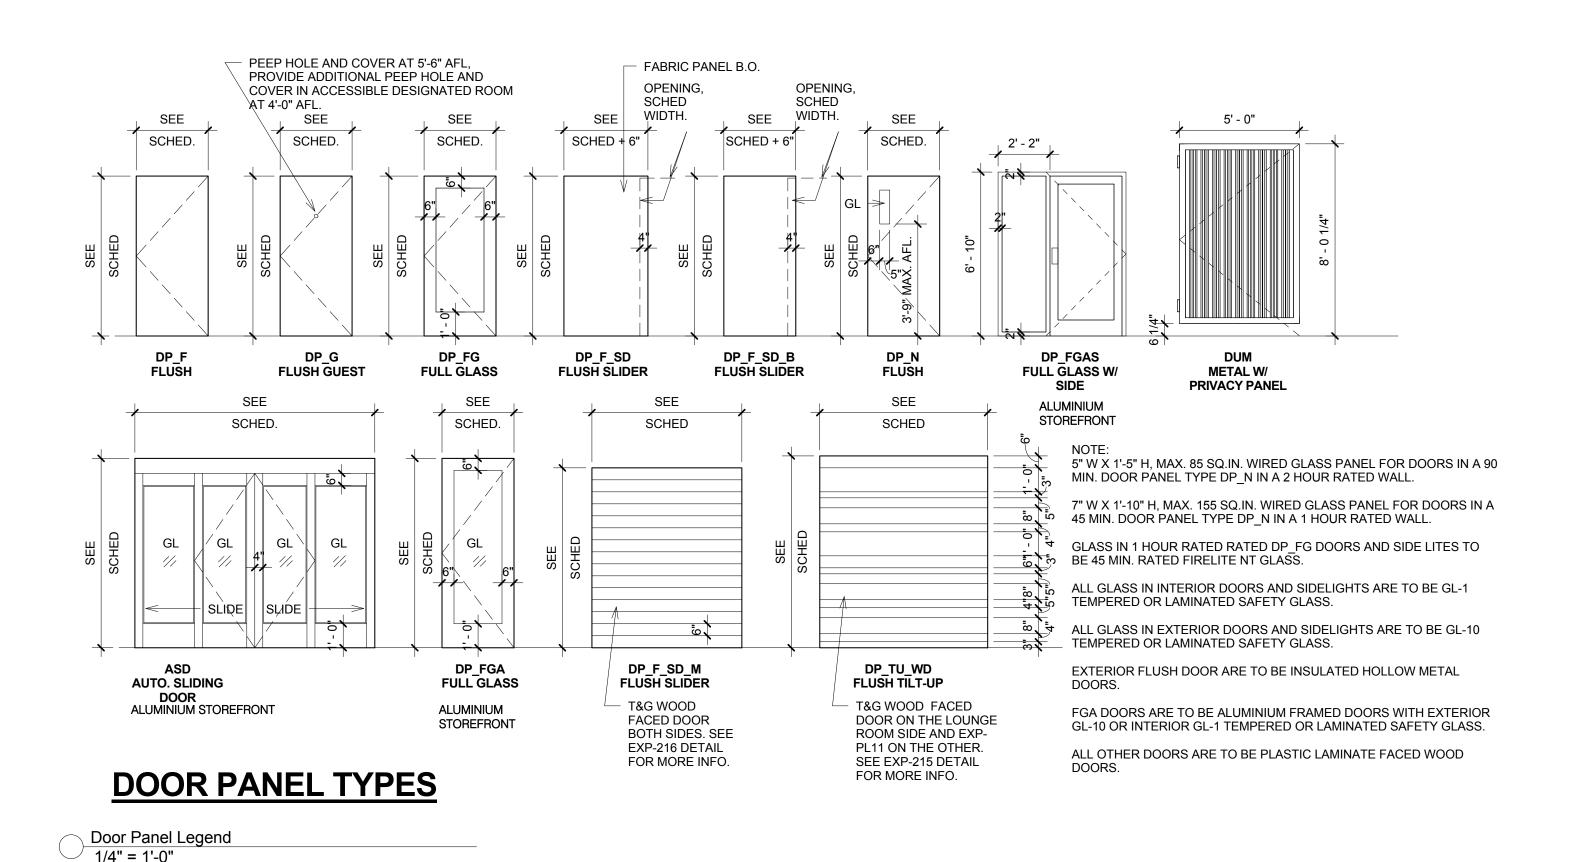

2° CENTER OF PULL
UNLESS NOTED OTHERWISE

1. KICK AND ARMOR PLATES TO BE 12° FROM EDGE OF DOOR LEAVES FOR PAIR OF
DOORS

2. ARMOR PLATE AFFIXED TO FIRE-RATED DOOR SMALL BE LABELED.
3. SEE SPECIFICATION FOR ADDITIONAL
INFORMATION

2° CENTER OF PULL
UNLESS NOTED OTHERWISE

1. KICK AND ARMOR PLATE AFFIXED TO FIRE-RATED DOOR SMALL BE LABELED.
3. SEE SPECIFICATION FOR ADDITIONAL
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2° CENTER OF PULL
UNLESS NOTED OTHERWISE

1. KICK AND ARMOR PLATE AFFIXED TO BE 12° FROM EDGE OF DOOR LEAVES FOR PAIR OF

1. KICK AND ARMOR PLATE AFFIXED TO BE 12° FROM EDGE OF DOOR LEAVES FOR PAIR OF

2° CENTER OF PULL
UNLESS NOTED OTHERWISE

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2° CENTER OF PULL
UNLESS NOTED OTHERWISE

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2° CENTER OF PULL
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2° CENTER OF PULL
UNLESS NOTED OTHERWISE

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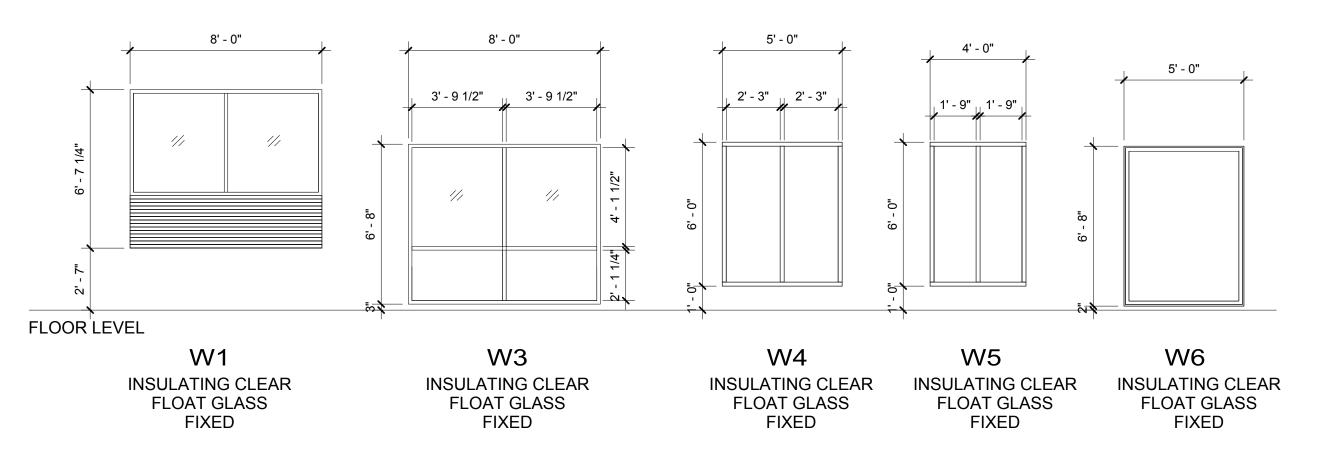
2° CENTER OF PULL
UNLESS NOTED OTHERWISE

1. KICK AND ARMOR PLATE AFFIXED TO BE 12° FROM EDGE OF DOOR LEAVES FOR PAIR OF

2° CENTER OF PULL
UNLESS NOTED OTHERWISE

2° CENTER OF PULL
UNLESS NOTED OTHERWISE

2° CENTER OF PULL
UNLESS NOTED OTHER




### **WINDOW LEGEND:**

Door Hardware Legend
1/2" = 1'-0"

- 1. ALL WINDOW FRAMES TO HAVE THERMAL BREAK.
- 2. PTAC UNITS, EXTERIOR LOUVERS TO BE INTEGRAL WITH THE WINDOW FRAMES.
- 3. GUEST ROOM WINDOWS TO HAVE DOUBLE-GLAZED.
- 4. CONTRACTOR TO SUBMIT WINDOW SUBMITTAL FOR REVIEW BY ARCHITECT.

Window Legend
1/4" = 1'-0"

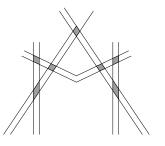

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**KEY PLAN** 

### NOTES:

1. DOOR FINISHES ARE STAIN GRADE OAK, PLASTIC LAMINATE, PAINTED OR PREFINISHED.

2. GLASS COLOR OF ENTRANCE
DOORS AND ALUMINUM STOREFRONTS
TO BE SELECTED BASED ON THE
EXTERIOR SCHEME THAT IS USED.
3. PROVIDE REMOTE CARD READERS
AT ALL EXTERIOR ENTRANCE DOORS

AT ALL EXTERIOR ENTRANCE DOORS, INCLUDING MAIN ENTRY, AND AT EXERCISE ROOM, GUEST LAUNDRY AND RECOMMENDED AT LINEN STORAGE ROOMS.

4. PROVIDE PANIC HARDWARE ON ALL EGRESS DOORS INCLUDING STAIRWELLS.

 AUTOMATIC SLIDING DOORS SHALL BE PROVIDED AT THE LOBBY ENTRANCE.
 SINGLE SLIDERS ARE NOT ALLOWED.
 ALL DOOR RATING REQUIREMENTS SHALL BE VERIFIED WITH THE LOCAL JURISDICTION.

JURISDICTION.

7. AUTOMATIC CLOSING AND
LATCHING DEVICE TO BE PROVIDED ON
ALL DOORS INCLUDING THE PUBLIC
RESTROOMS, STORAGE, MAINTENANCE,
EQUIPMENT ROOMS, GUESTROOMS AND
EGRESS DOOR AS PER FRANCHISE
STANDARDS.

Shiva Southaven

Holiday Inn Express & Suites

Lot 16 (Rev Lot 3) Southcrest Pkwy.
Southcrest Subdivision

Drawing Title

Southaven, MS 38671

Door & Window Schedule

Phase Construction Documents


Project No. 14-081
Prepared by Author
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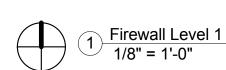
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A702

Review

2/2/2015 E:4E:20 AM



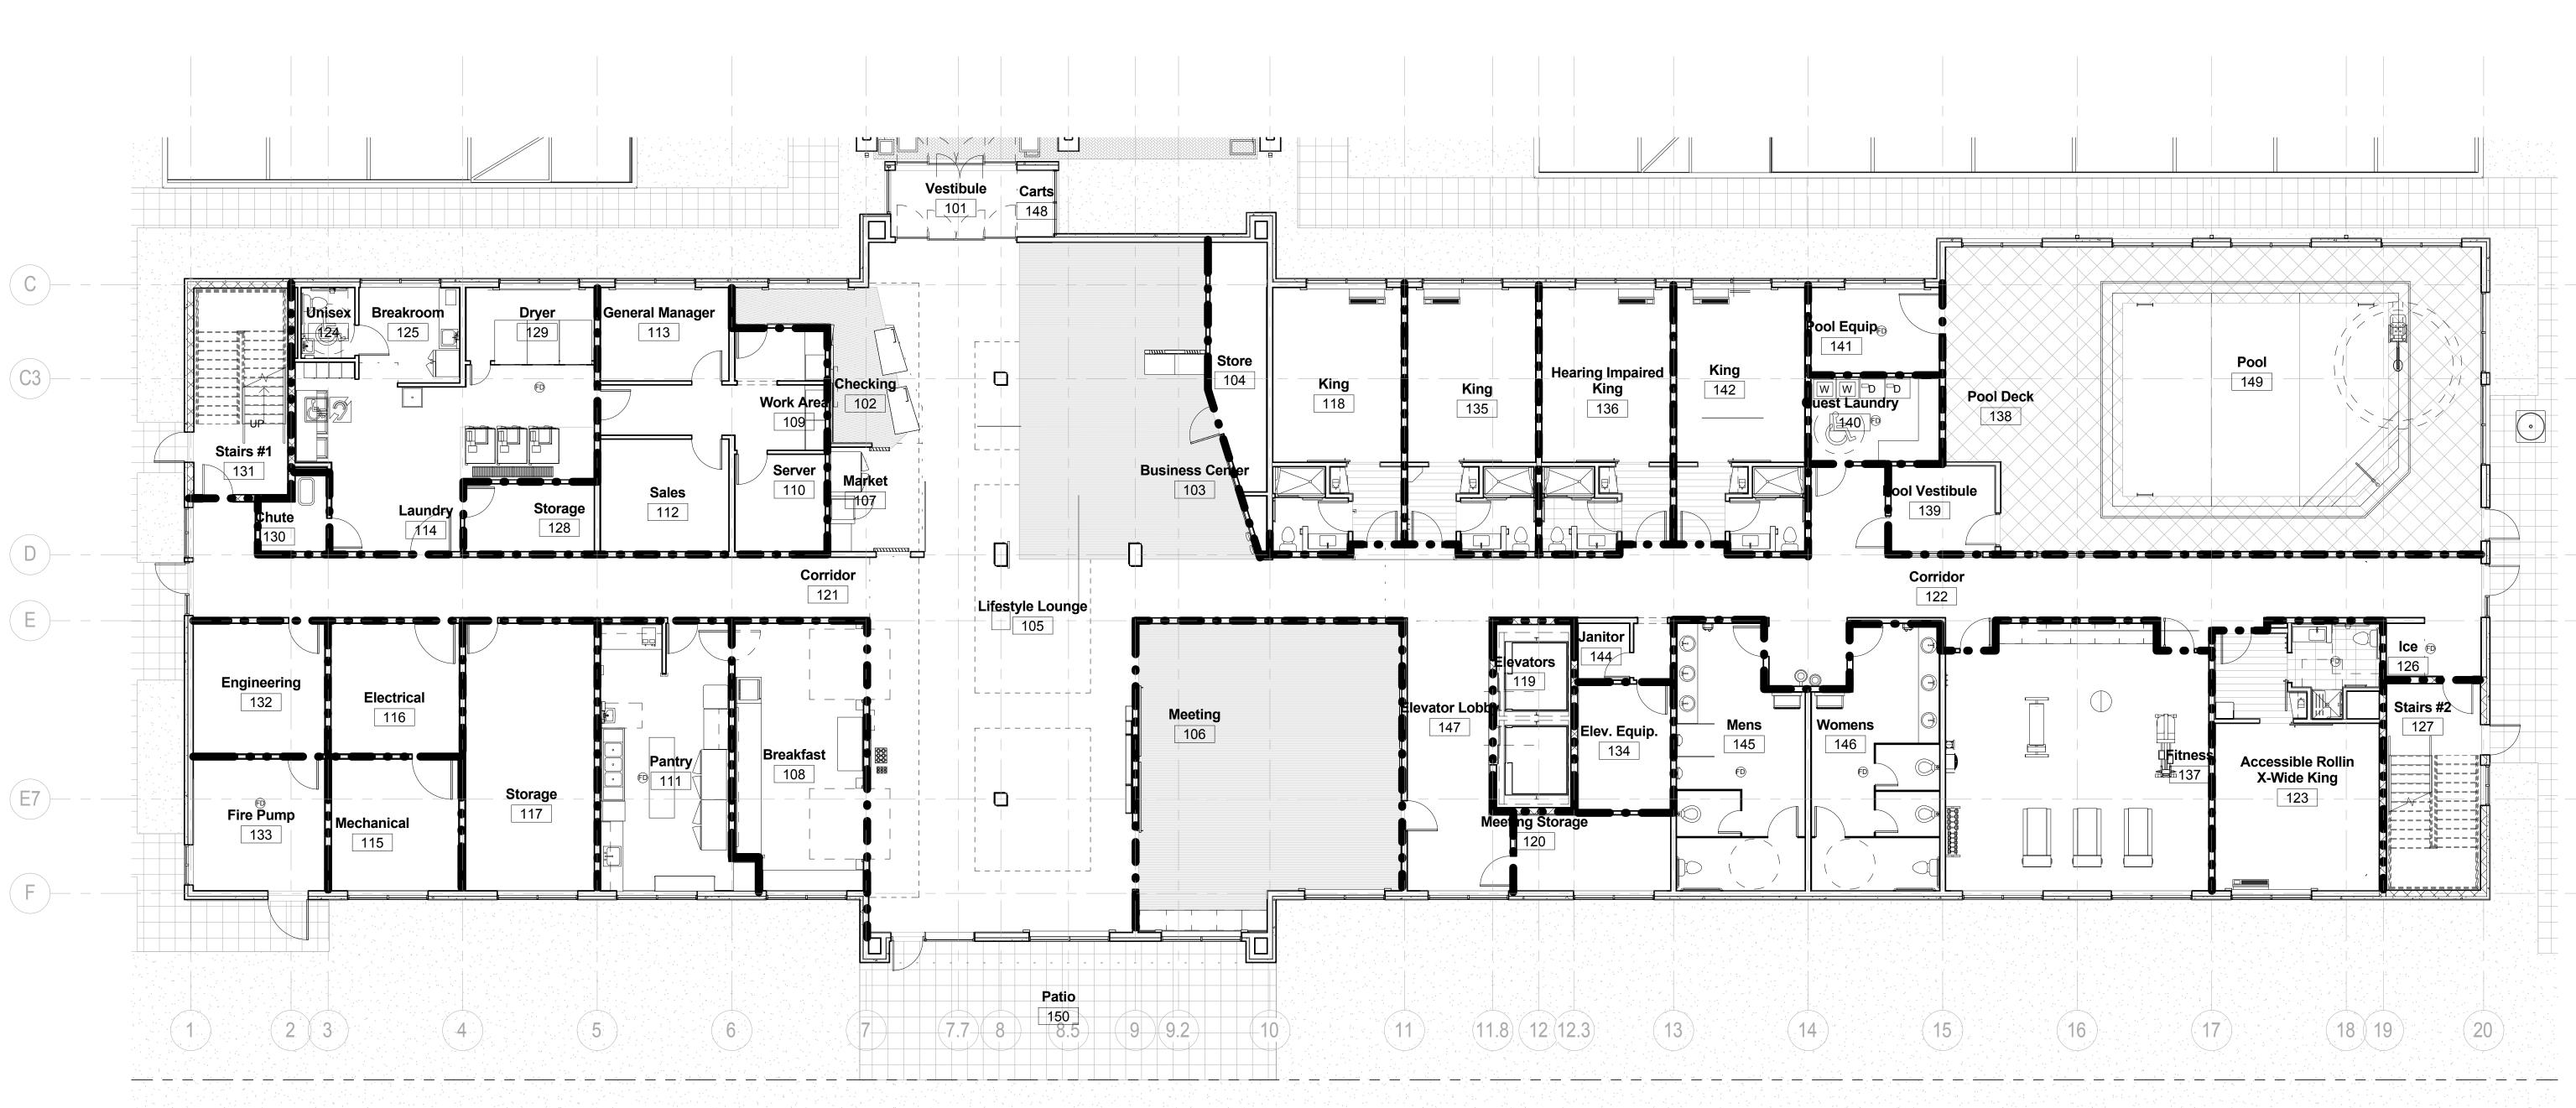

Level	Space	Area Sq. Ft.	Occupancy Classification	Area/Occupant Load	Occupant Load
1ST	ASSEMBLY	2,717	A-3	15	181
1ST	STORAGE/MECH.	1,430	S-2	300	5
1ST	LAUNDRY	469	F-1	100	5
1ST	OFFICE	651	В	100	7
1ST	RESIDENTIAL	6,318	R-1	200	32
2ND	RESIDENTIAL	10,492	R-1	200	52
2ND	STORAGE/MECH.	727	S-2	300	2
3 TO 5	RESIDENTIAL	10,823	R-1	200	54
3 TO 5	STORAGE	396	S-2	300	1

### FIRE WALL LEGEND

ALL MECHANICAL ROOMS TO BE 2 HOUR FIRE RATED.

INDICATES ONE HOUR FIRE RATED WALL CONSTRUCTION AS PER UL STANDARDS

INDICATES TWO HOUR FIRE RATED WALL CONSTRUCTION AS PER UL STANDARDS

NOTE:
ALL FIRE-RATED WALLS TO EXTEND TO STRUCTURE ABOVE AS PER FIRECODE.
ALL OPENINGS AND PENETRATIONS IN FIRE RATED WALLS NEED TO MEET CODE REQUIREMENTS
ALL DEMISING WALLS BETWEEN GUEST ROOMS TO BE 1 HOUR FIRE RATED.
ALL CORRIDOR WALLS TO BE 1 HOUR FIRE RATED
ALL VERTICAL SHAFTS BETWEEN FLOORS TO BE 2 HOUR FIRE RATED.

MISHRA

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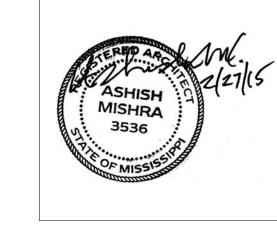
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**KEY PLAN** 

Shiva Southaven

Holiday Inn Express & Suites

Lot 16 (Rev Lot 3) Southcrest Pkwy. Southcrest Subdivision Southaven, MS 38671

Drawing Title
Firewall Plan 1st Floor

Construction Documents

Project No. 14-081
Prepared by Author
Checked by Checker
Date Feb. 27, 2015

Sheet No.

A801

Review



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No.	Date	Description				

King

235

Stairs #2

233

Accessible X-Wide

234

18 19

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**KEY PLAN** 

Shiva Southaven

Holiday Inn Express & Suites

Lot 16 (Rev Lot 3) Southcrest Pkwy. Southcrest Subdivision Southaven, MS 38671

Drawing Title

Firewall Plan 2nd Floor

Construction Documents

14-081 Sheet No. Project No. Prepared by Author Checked by Checker Date Feb. 27, 2015

Review

FIRE WALL LEGEND

INDICATES ONE HOUR FIRE RATED WALL CONSTRUCTION AS PER UL STANDARDS

INDICATES TWO HOUR FIRE RATED WALL CONSTRUCTION AS PER UL STANDARDS

**Double Queen** 

232

223

224

219

225

Double Queen

226

227

238

**Double Queen** 

228

229

Hearing Impaired

**Double Queen** 

230

ALL FIRE-RATED WALLS TO EXTEND TO STRUCTURE ABOVE AS PER FIRECODE.

ALL OPENINGS AND PENETRATIONS IN FIRE RATED WALLS NEED TO MEET CODE REQUIREMENTS ALL DEMISING WALLS BETWEEN GUEST ROOMS TO BE 1 HOUR FIRE RATED.

ALL CORRIDOR WALLS TO BE 1 HOUR FIRE RATED ALL VERTICAL SHAFTS BETWEEN FLOORS TO BE 2 HOUR FIRE RATED. ALL MECHANICAL ROOMS TO BE 2 HOUR FIRE RATED.

Level	Space	Area Sq. Ft.	Occupancy Classification	Area/Occupant Load	Occupant Load
1ST	ASSEMBLY	2,717	A-3	15	181
1ST	STORAGE/MECH.	1,430	S-2	300	5
1ST	LAUNDRY	469	F-1	100	5
1ST	OFFICE	651	В	100	7
1ST	RESIDENTIAL	6,318	R-1	200	32
2ND	RESIDENTIAL	10,492	R-1	200	52
2ND	STORAGE/MECH.	727	S-2	300	2
3 TO 5	RESIDENTIAL	10,823	R-1	200	54

S-2

300

217

**Double Queen** 

220

**Double Queen** 

Suite

218

222

**Hearing Impaired** 

**Double Queen** 

216

3 TO 5 STORAGE

396

1/8" = 1'-0"

Stair's #1

**Double Queen** 

204

Hearing Impaired

**Double Queen** 

210

209

**Double Queen** 

212

Accessible King

Suite

214

King Wide

203

**Double Queen** 

206

205

**Double Queen** 

208

(C3)

E7



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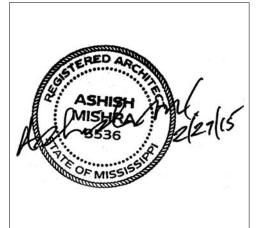
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KEY PLAN

Shiva Southaven

Holiday Inn Express & Suites

Lot 16 (Rev Lot 3) Southcrest Pkwy.
Southcrest Subdivision
Southaven, MS 38671

Drawing Title
Firewall Plan 3rd Floor

INDICATES ONE HOUR FIRE RATED WALL CONSTRUCTION AS PER UL STANDARDS

INDICATES TWO HOUR FIRE RATED WALL CONSTRUCTION AS PER UL STANDARDS

ALL FIRE-RATED WALLS TO EXTEND TO STRUCTURE ABOVE AS PER FIRECODE.

ALL DEMISING WALLS BETWEEN GUEST ROOMS TO BE 1 HOUR FIRE RATED.

ALL VERTICAL SHAFTS BETWEEN FLOORS TO BE 2 HOUR FIRE RATED.

ALL CORRIDOR WALLS TO BE 1 HOUR FIRE RATED

ALL MECHANICAL ROOMS TO BE 2 HOUR FIRE RATED.

ALL OPENINGS AND PENETRATIONS IN FIRE RATED WALLS NEED TO MEET CODE REQUIREMENTS

Phase
Construction Documents

 Project No.
 14-081
 Sheet No.

 Prepared by
 Author

 Checked by
 Checker

 Date
 Feb. 27, 2015

Review



1ST ASSEMBLY

1ST LAUNDRY

1ST OFFICE

1ST STORAGE/MECH.

1ST RESIDENTIAL

2ND RESIDENTIAL

3 TO 5 RESIDENTIAL

3 TO 5 STORAGE

2ND STORAGE/MECH.

2,717

1,430

469

651

6,318 10,492

727

10,823

396

A-3

S-2

F-1

R-1

R-1

S-2

R-1

S-2

15

300

100

100

200

200

300

200

300


181

5

32

52


54

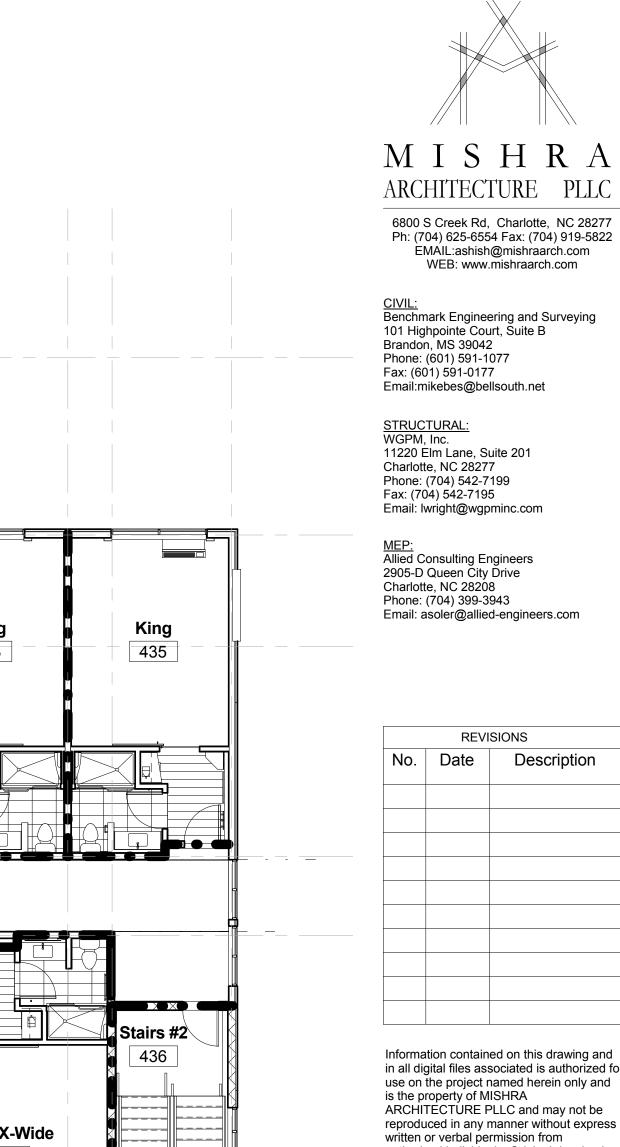

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REVISIONS

Description

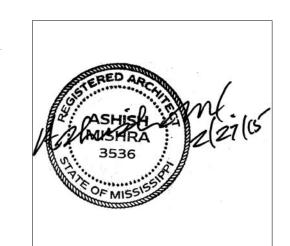

**KEY PLAN** 

Shiva Southaven

Holiday Inn Express & Suites


Lot 16 (Rev Lot 3) Southcrest Pkwy. Southcrest Subdivision Southaven, MS 38671

Drawing Title

Firewall Plan 4th Floor

Construction Documents					
Project No.	14-081	Sheet No.			
Prepared by	Author	4804			
Checked by	Checker	A804			

Date Feb. 27, 2015

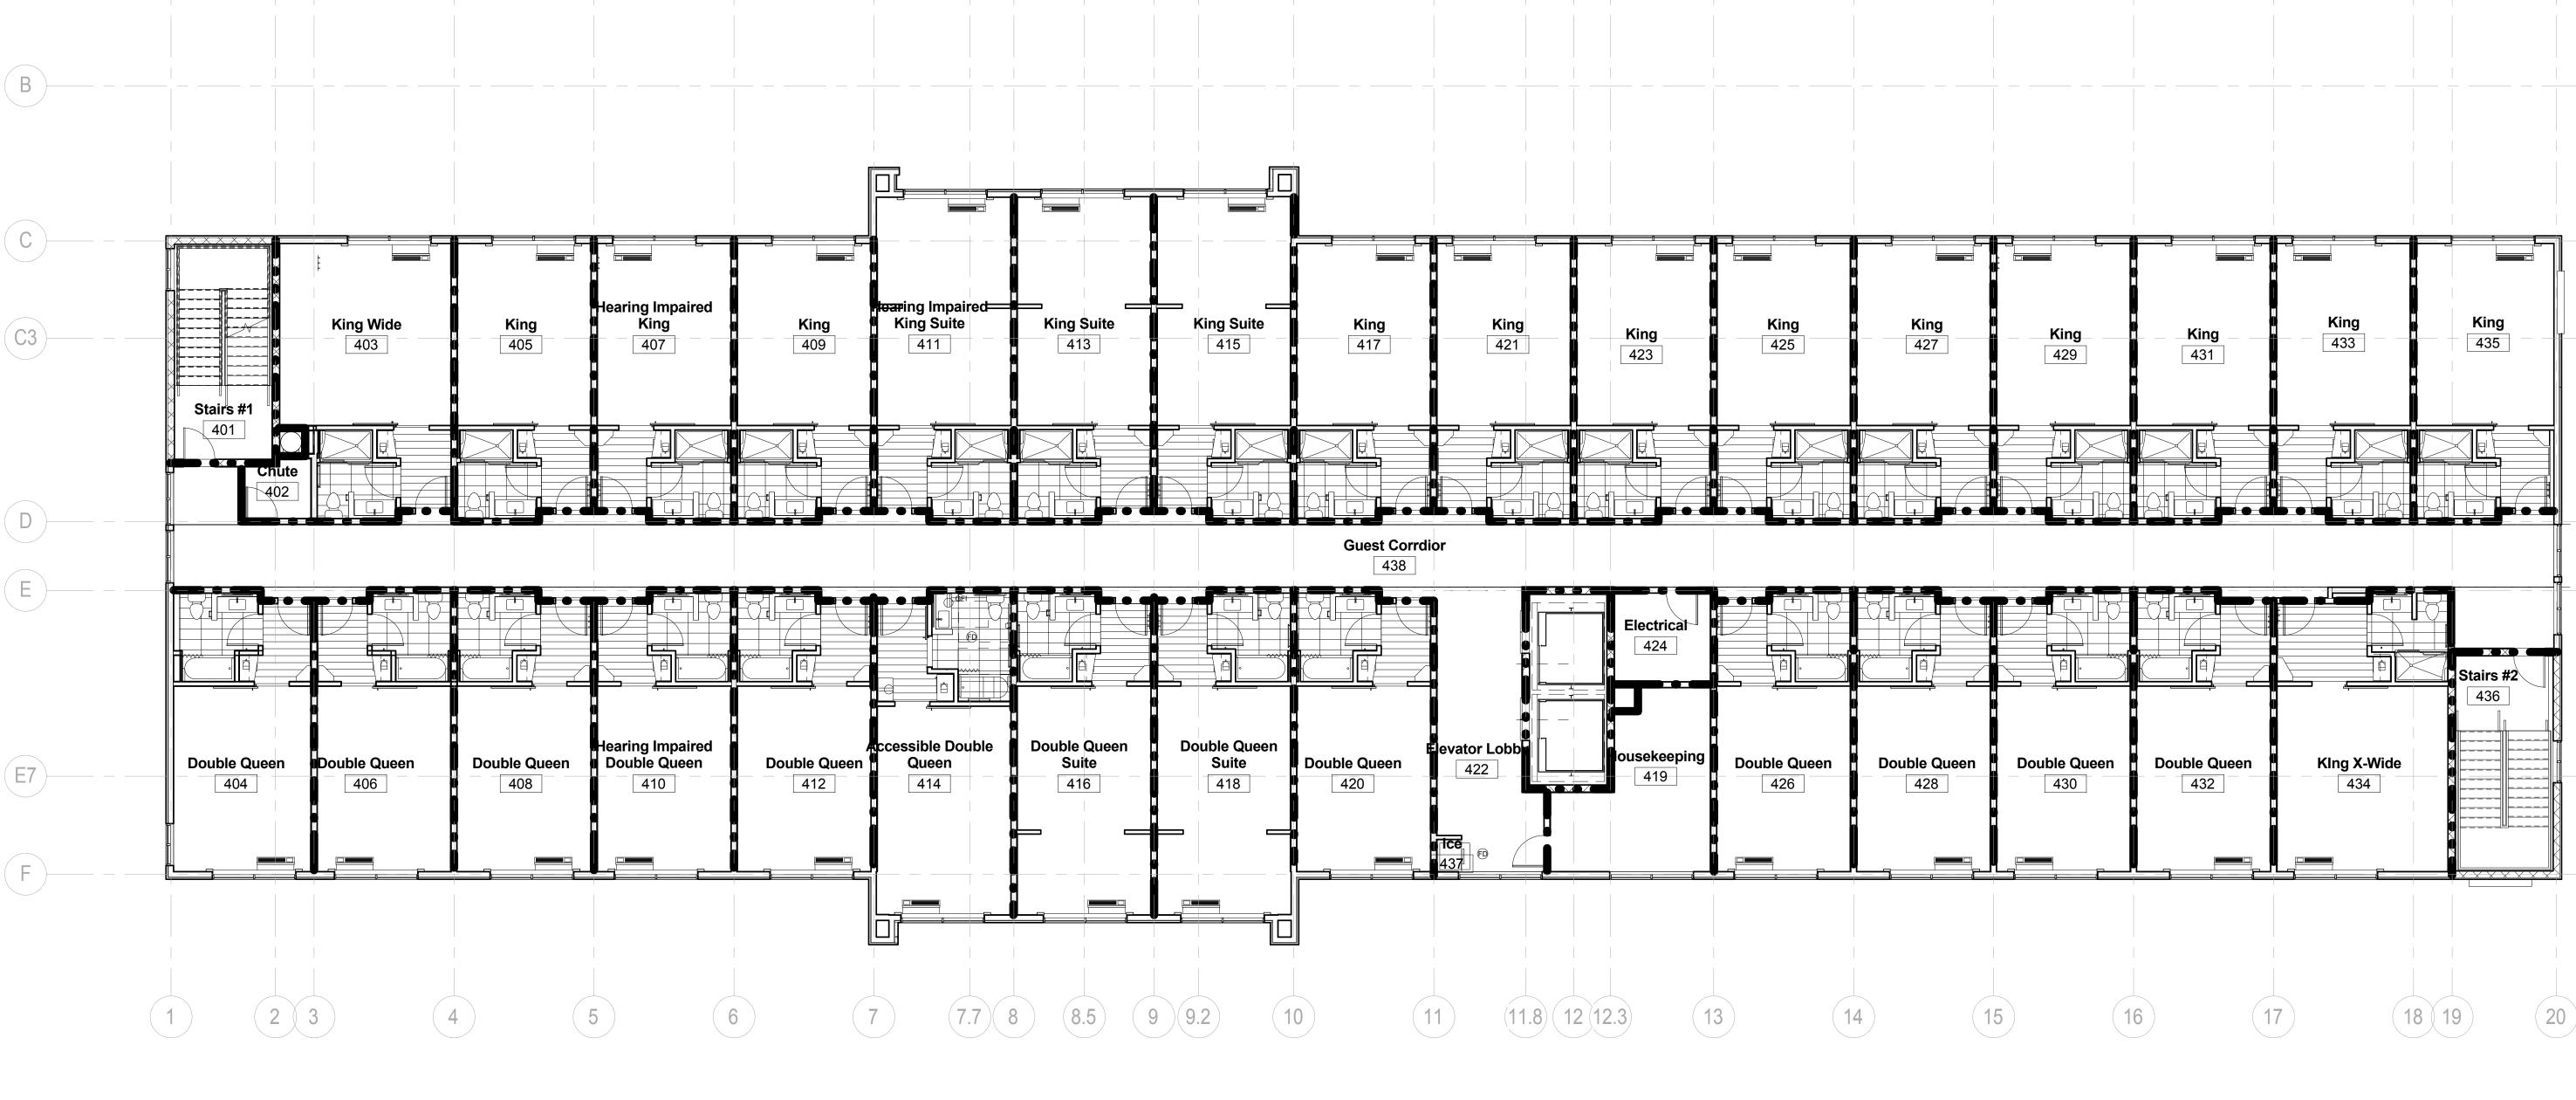

Level	Space	Area Sq. Ft.	Occupancy Classification	Area/Occupant Load	Occupant Load
1ST	ASSEMBLY	2,717	A-3	15	181
1ST	STORAGE/MECH.	1,430	S-2	300	5
1ST	LAUNDRY	469	F-1	100	5
1ST	OFFICE	651	В	100	7
1ST	RESIDENTIAL	6,318	R-1	200	32
2ND	RESIDENTIAL	10,492	R-1	200	52
2ND	STORAGE/MECH.	727	S-2	300	2
3 TO 5	RESIDENTIAL	10,823	R-1	200	54
3 TO 5	STORAGE	396	S-2	300	1

### FIRE WALL LEGEND

INDICATES ONE HOUR FIRE RATED WALL CONSTRUCTION AS PER UL STANDARDS

INDICATES TWO HOUR FIRE RATED WALL CONSTRUCTION AS PER UL STANDARDS

- ALL FIRE-RATED WALLS TO EXTEND TO STRUCTURE ABOVE AS PER FIRECODE.
  ALL OPENINGS AND PENETRATIONS IN FIRE RATED WALLS NEED TO MEET CODE REQUIREMENTS
- ALL DEMISING WALLS BETWEEN GUEST ROOMS TO BE 1 HOUR FIRE RATED.
  ALL CORRIDOR WALLS TO BE 1 HOUR FIRE RATED
- ALL VERTICAL SHAFTS BETWEEN FLOORS TO BE 2 HOUR FIRE RATED.
  ALL MECHANICAL ROOMS TO BE 2 HOUR FIRE RATED.

Firewall Level 4 1/8" = 1'-0"