

IRRIG KEY	ATION EQUIPME	ENT SCHEDULE DESCRIPTION	MODEL
С	HUNTER	IRRIGATION CONTROLLER	I-CORE, I2 STA PLASTIC CABI
(Ef)	HUNTER	Et SENSOR/RAIN SENSOR	WIRELESS SOL WSS-SEN SEE
Н	NETAFIM	HYDROMETER	I.5" NORMALLY ADDITIONAL E
	WILKINS	REDUCED PRESSURE BACKFLOW DEVICE	WILKINS 375XL WITH CAGE AN
	KBI	BALL VALVE	SCH 80 LO-TC
\blacklozenge	HUNTER	I" QUICK COUPLER	HQ-5 ON SWING
\oplus	HUNTER	DRIP CONTROL ZONE KIT	
Ð	HUNTER	VALVE	ICV SERIES, SI
٠	TORO	PVC TO SUBSURFACE DRIP	TORO FTF-16
Ê	TORO	SUB SURFACE FLUSH VALVE	E TFCH-H-FIPT
Â	TORO	SUB SURFACE AIR RELEASE VALVE (NOT SHOWN)	E TYD-500-34 L ONE REQUIRED
⇔	RAINBIRD	TREE BUBBLERS	PRESSURE CO
_	MAINLINE		SCH. 40 PVC, E DRIVING SURFA SHOWN 1.5" UNLI
	LATERAL LINES		CL 200 PVC, E SURFACE - SEE UNLESS OTHERI VELOCITY EXC
-	SUBSURFACE DRIF	PLINE	TORO DL2000 5/8" I.O GPH.
	DRIPLINE HEADER	CL 200 PVC, 9	
	SLEEVING (NOT	SHOWN)	SCH. 40 PVC, 2 IRRIGATION LIN SURFACE. SEE
	× VALVE NU VALVE SIZ APPROXIM GALLONS	ZE 0 - 12 IATE 12 - 28 PER MINUTE 28 - 4	AL PIPE SIZING 2 GPM: 1" 3 GPM: 1.5" 5 GPM: 2" 2 GPM: 2.5"
Ē	XCEPT WHERE CR	PTH FOR ALL PIPE UNDER F OSSING UNDERDRAINS WHEF E DETAIL, SHEET C6	PAVEMENT IS 24

SEE LANDSCAPE IRRIGATION NOTES SHEET L4.0

12 STA. WALL MOUNT CABINET

S SOLAR-SYNC I SEE DETAILS FOR MOUNTING

MALLY CLOSED HYDROMETER - SEE MFR REQ'TS FOR NAL EQUIPMENT REQUIRED FOR HUNTER CONTROLLER

375XL LEAD FREE - 1.5" GE AND POLAR BLANKET LO-TORQUE, FULL PORT, LINE SIZE

N SWING JOINT FURNISH ONE SET CHING KEY AND SWIVEL ELL TO OWNER

IES, SIZE PER PLAN

D-34 LOCATE AT HIGH POINT ON LINE RUIRED FOR EACH CIRCUIT

E COMPENSATING BUBBLERS - .25 GPM

PVC, BURY 18", 24" UNDER SURFACE - SEE NOTE BELOW. MIN. SIZE 5" UNLESS OTHERWISE NOTED ON PLAN.

PVC, BURY 12", 24" UNDER DRIVING E - SEE NOTE BELOW . MIN. SIZE SHOWN I" DTHERWISE NOTED ON PLAN. IN NO CASE MAY Y EXCEED 5 FPS.

.2000, 18" EMITTER SPACING GPH. FITTINGS TO MATCH

PVC, SEE DETAIL L3.0/I & J

PVC, 2 TIMES LARGER THAN ON LINE. BURY 24" UNDER DRIVING . SEE SPECS/ DETAILS AND NOTE BELOW

IS 24" BELOW PAVING COURSE. ION PIPE MUST CROSS BELOW

> CALL BEFORE YOU DIG 48 HOURS CALL "USA" TOLL FREE 8-1-1



UNDERGROUND SERVICE ALERT


 SCALE:1"=20'-0"

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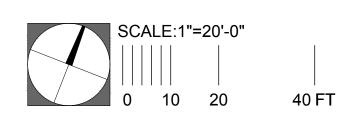
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Sierra Designs, inc Landscape Architecture • Planning 113 N. Church Street Suite 310 Visalia, CA 93291 T: 559.733.3690 F: 559.733.3694 khutmacher@sierradesignsla.com dan@sierradesignsla.com Revision/Issued for: 6.15.17 ISSUED FOR BRAND REVIEW 8.3.17 ISSUED FOR PLAN CHECK Professional Seal: __NO, 2455 DATE: __ ST EXP 5 2018 OF CALIF ANDSCAP NO. 2409 DATE: ____ 、EXP. 1-2018 / Gateway Hotel 550 Gateway Blvd. South San Francisco, Ca A Project For: Sri Krishna Enterprise 300 Gateway Boulevard South San Francisco, CA Vijay Patel, Project Manager Sheet Title: IRRIGATION PLAN SDI Job No: 16-032 Project Manager: kh Drawn By: kd Date: 8-29-17 Scale: 1" = 20'

of 4 Sheets



<u>SYM</u>	BOTANICAL NAME	COMMON NAME	SIZE	<u>WUCOLS</u>
ARB MAR CUP MAC CUP TT GIN BIL LOP CON MEL QUI MET EXC PHO DAC TRA HUM TRI LAU	CUPRESSUS MACROCARPIA CUPRESSUS S. 'TINY TOWERS' GINKGO BILBOBA LOPHOSTEMON CONFERTUS MELALEUCA QUINQUENERVIA METROSIDEROS EXCELSA PHOENIX DACTYLIFERA TRACHYCARPUS HUMILIS	MARINA STRAWBERRY 1 MONTEREY CYPRESS TINY TOWERS ITAL CYP MAIDENHAIR TREE BRISBANE BOX CAJEPUT TREE N. Z. CHRISTMAS TREE DATE PALM MEDITERRANEAN FAN F WATER GUM	24" BOX RESS 24" BOX 24" BOX 24" BOX 24" BOX 24" BOX 24" BOX 12' BROWN TRUNK	
SHRUBS				
AGA AFR ARC SUN ARC SUN AZ SUN AZ SUN AZ TREP BAC TP BAC TP BAC CAR MAC CEA MAC CEA MAC CEA MAC COR T LAC COR T COR TA COR T COR T LAC COR T COR T COR T LAC COR T COR T C	BACCHARIS P. 'TWIN PEAKS' BERBERIS THUNBERGII CAREX BARBARAE CARISSA MACROCARPA'TOMLIN CEANOTHUS 'JOYCE COULTER' CLIVIA MINIATA CISTUS X PURPUREUS COPROSMA X KIRKII CORDYLINE FESTIVAL GRASS COTONEASTER LACTEUS ERICA CANALICULATA HEBE 'PATTY'S PURPLE' HETEROMELES ARBUTIFOLIA JUNCUS PATENS LANTANA 'WHITE LIGHTENING' LIRIOPE MUSCARI LOROPETALUM CHINENSE MAHONIA REPENS MUHLENBERGIA RIGENS MUHLENBERGIA C. REGAL MIST OLEA E. 'LITTLE OLLIE' PHORMIUM 'MAORI QUEEN' PRUNUS ZABELIANA RHAMNUS CALIFORNIA RHAPHIOLEPIS UMBELLATA 'MINO RHUS OVATA	JOYCE COULTER M ORANGE CLIVIA ORCHID ROCKROSE CREEPING COPROS FESTIVAL CORDYL COTONEASTER TWISTED HEATH PATTY'S PURPLE HE CHRISTMAS BERRY GREY RUSH WHITE LIGHTENING I BIG BLUE LILYTURF FRINGE FLOWER OREGON GRAPE CREEPING OREGON DEER GRASS REGAL MIST PINK N DWF OLIVE TREE 'L MAORI QUEEN FLA ZABELIANA ENGLIS COFFEEBERRY OR' YEDDO DWF INDIAN SUGAR BUSH	IITA 5 GAL AZALEA 5 GAL AZALEA 5 GAL 5 GAL 5 GAL 2 GAL 1 GAL PLUM 1 GAL PLUM 1 GAL T. LILAC 5 GAL I GAL 5 GAL I MA 5 GAL INE 5 GAL I GAL 5 GAL I GAL 5 GAL I MA 5 GAL I GAL 5 GAL I GAL 6 GAL I GAL 5 GAL I HLAUREL 5 GAL I LAUREL 5 GAL I HAWTHORN 5 GAL 5 GAL	הרררראררררעראעעאנאעראעראעראערעערעער
	ACHILLEA MILLEFOLIUM 'ISLAND	9 PINK', 18" OC FROM I G	AL CONTAINERS. WU	COLS 'L'
	GREEN LEAF GAZANIA, 14" OC F		·	
	GRASSCRETE PAVERS WITH KUR AVAILABLE FROM FLORASOURC			
	COBBLE - ROUND, ³ / ₄ " TO 2". 2" PROHIBITED	DEEP OVER COMPACTEI	O NATIVE GRADE. W	EED FABRIC
* QUANTI	TIES FOR CONVENIENCE ONLY, CO	NTRACTOR TO FURNISH ,	ALL PLANTS SHOWN (ON PLANS
********	VESPRO 24" ROOT GUIDE & B. ANTICIPATED REQUIRED LOCA			

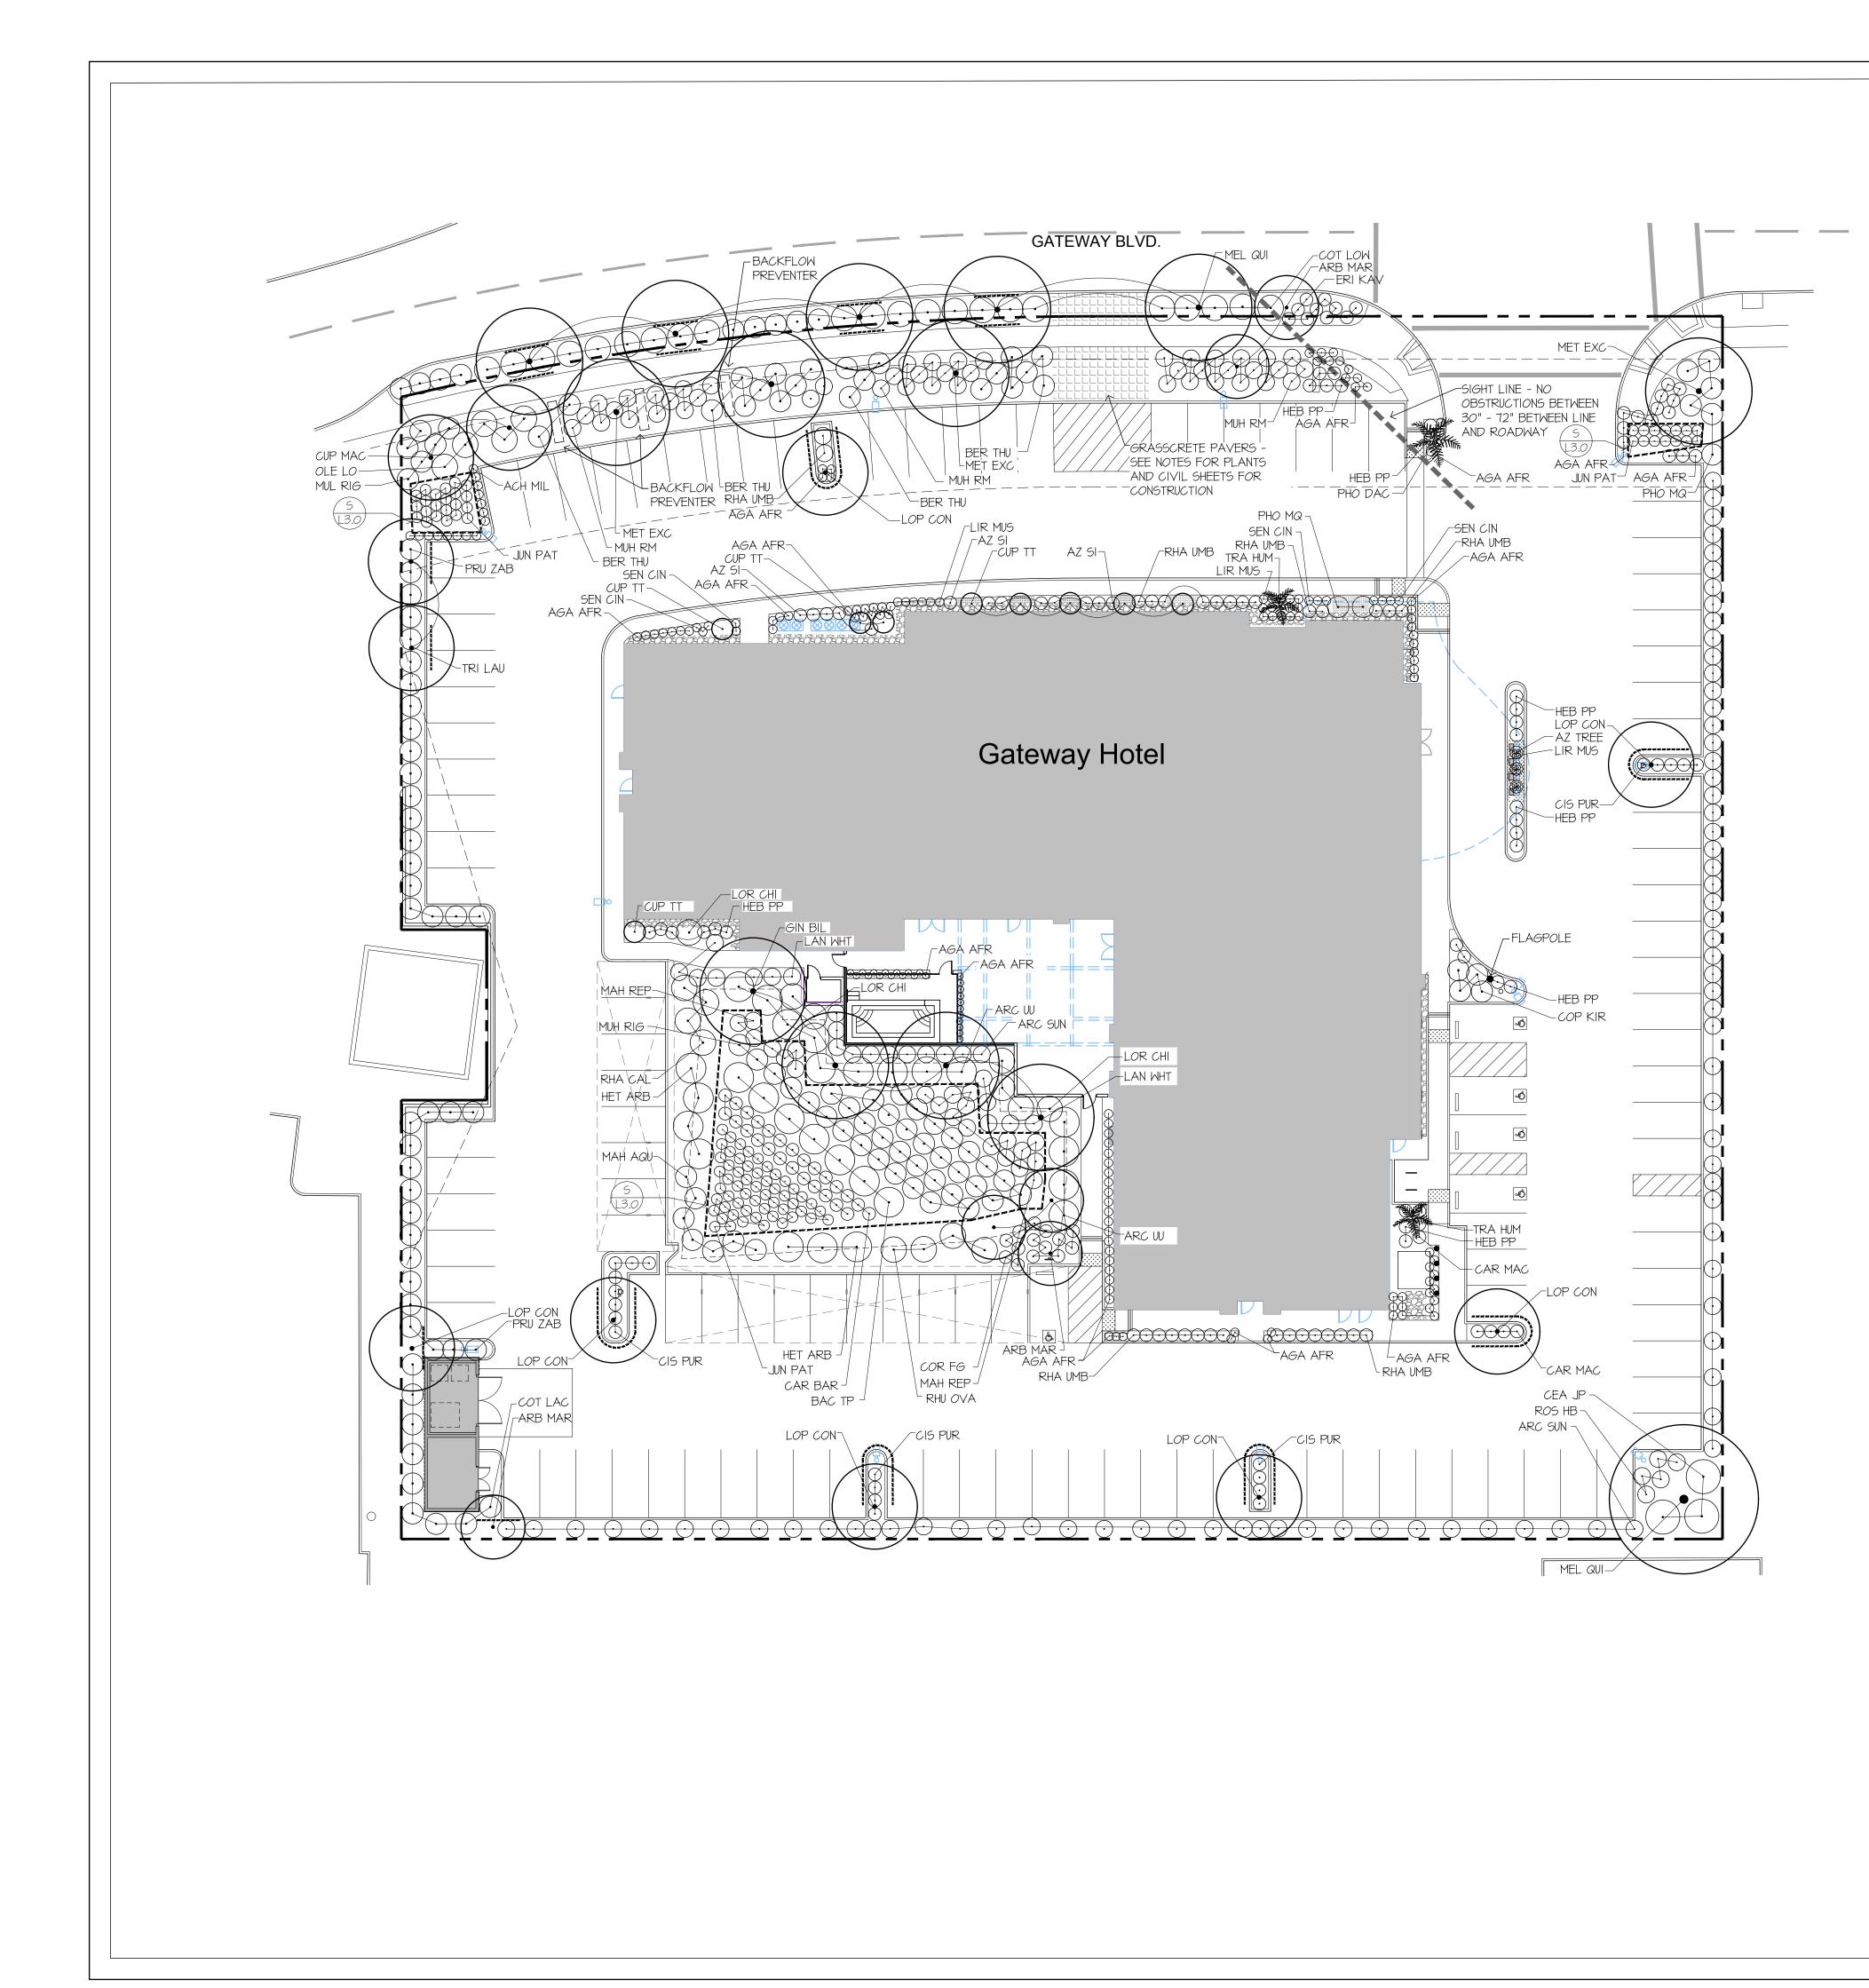

UNDERGROUND SERVICE ALERT







Scale: |" = 20'

of 4 Sheets

SDI Job No: 16-032

Drawn By: kd Date: 8-29-17

Project Manager: kh

48 HOURS CALL "USA" TOLL FREE 8-1-1

CALL BEFORE YOU DIG

Vijay Patel, Project Manager

Sheet Title:

PLAN

PLANTING

Sri Krishna Enterprise 300 Gateway Boulevard South San Francisco, CA

A Project For:

Gateway Hotel 550 Gateway Blvd. South San Francisco, Ca

Sierra

Designs, inc

Landscape Architecture • Planning

113 N. Church Street Suite 310 Visalia, CA 93291 T: 559.733.3690 F: 559.733.3694

khutmacher@sierradesignsla.com dan@sierradesignsla.com

6.15.17 ISSUED FOR BRAND REVIEW 8.3.17 ISSUED FOR PLAN CHECK

NO. 2455

ST EXPECT 2018


NO. 2409

EXP. 1−2018 /

DATE:

Revision/Issued for:

Professional Seal:

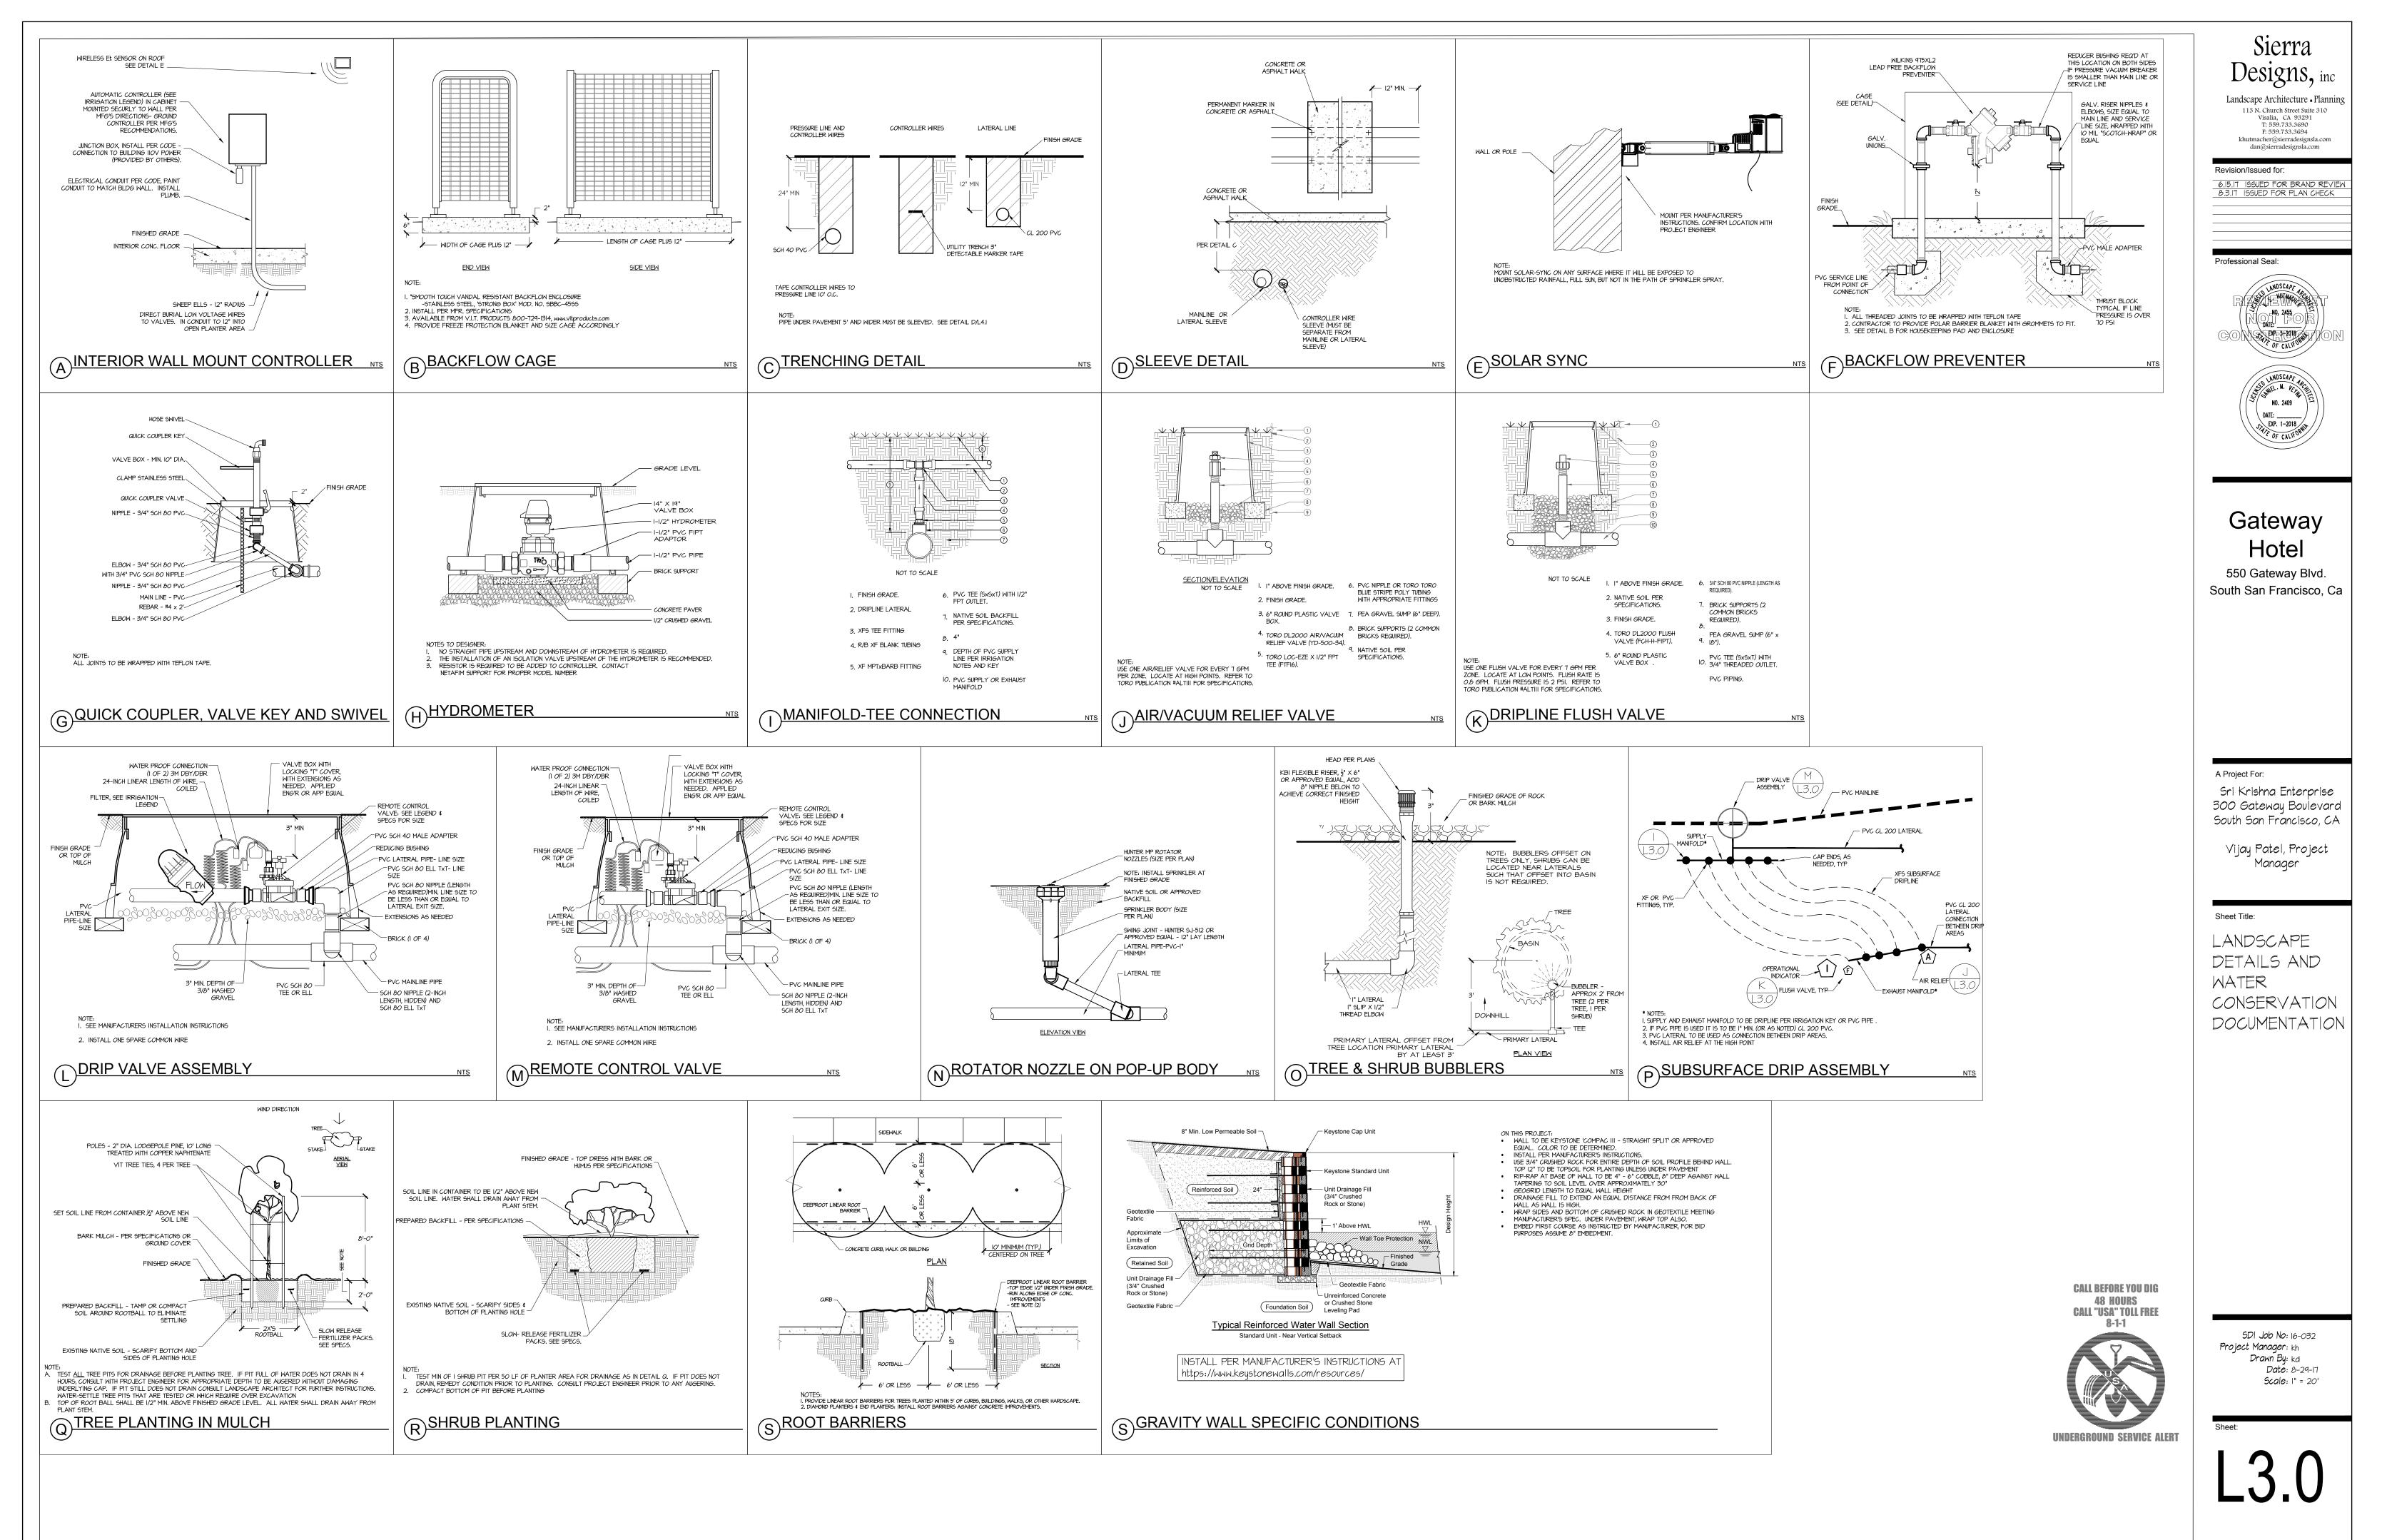

IRRIGATION NOTES

HE SYSTEM IS BASED ON 50 P.S.I. AND 25 G.P.M. AVAILABLE AT THE DISCHARGE OUTLET OF THE METER OR OTHER POINT OF CONNECTION. THE CONTRACTOR SHALL VERIFY THE SAME AT THE AWARD OF THE CONTRACT. THE CONTRACTOR SHALL NOTIFY THE ARCHITECT IMMEDIATELY IF THE DATA IS SIGNIFICANTLY DIFFERENT AND WOULD ADVERSELY AFFECT THE OPERATION OF THE SYSTEM. SUCH NOTICE SHALL BE IN WRITING AND SHALL OCCUR A MINIMUM OF TWO WEEKS PRIOR TO START OF INSTALLATION.

HE SYSTEM FEATURES ARE SHOWN SCHEMATICALLY FOR GRAPHIC CLARITY. INSTALL ALL PIPING AND VALVES IN COMMON TRENCHES WHERE FEASIBLE AND INSIDE PLANTING AREAS. VALVES AND MAIN LINES SHALL BE LOCATED IN PLANTER AREAS.

<u>UTILITIES:</u> NO UTILITY SURVEY HAS BEEN PERFORMED. CONTRACTOR SHALL BE RESPONSIBLE FOR CONTACTING UNDERGROUND SERVICE ALERT TWO (2) DAYS PRIOR TO THE START OF

WORK. DURING TRENCHING OPERATIONS, CONTRACTOR SHALL PROTECT EXISTING UTILITIES IN PLACE. IN THE EVENT OF CONFLICT BETWEEN UTILITIES AND TRENCHING OPERATIONS, CONTRACTOR SHALL HAND DIG TRENCH TO AVOID DAMAGE TO EXISTING UTILITIES.

THE IRRIGATION SYSTEM AND ALL OTHER MECHANICAL, ELECTRICAL AND STRUCTURAL SYSTEMS SHALL BE

INSTALLED IN ACCORDANCE WITH ALL FEDERAL, STATE AND LOCAL CODES AND MANUFACTURER'S SPECIFICATIONS, RECOMMENDATIONS AND REQUIREMENTS. ALL ELECTRICAL EQUIPMENT SHALL BE U.L. LISTED. NOTIFY THE ARCHITECT IMMEDIATELY IN WRITING PRIOR TO SIGNING A CONTRACT OWNER OF ANY CONFLICTS. CONFLICTS NOTED AFTER SIGNING OR AFTER THE COMMENCEMENT OF WORK SHALL BE THE SOLE RESPONSIBILITY OF THE CONTRACTOR.

ALL MATERIALS SHALL BE INSTALLED IN ACCORDANCE WITH MANUFACTURES RECOMMENDATIONS. NOTIFY ARCHITECT PRIOR TO BIDDING IN THE EVENT OF CONFLICTS BETWEEN MANUFACTURER'S RECOMMENDATIONS, PLANS, DETAILS, NOTES, OR SITE FEATURES.

THE LANDSCAPE ARCHITECT SHALL NEITHER HAVE CONTROL OVER OR CHARGE OF, NOR BE RESPONSIBLE FOR, THE CONSTRUCTION MEANS, METHODS, TECHNIQUES, SEQUENCES OR PROCEDURES, OR FOR SAFETY PRECAUTIONS AND PROGRAMS IN CONNECTION WITH THE WORK, SINCE THESE ARE SOLELY THE CONTRACTOR'S RIGHTS AND RESPONSIBILITIES UNDER THE CONTRACT DOCUMENTS.

EXAMINE AREAS AND CONDITIONS UNDER WHICH IRRIGATION WORK IS TO BE PERFORMED. DO NOT PROCEED WITH WORK UNTIL UNSATISFACTORY CONDITIONS HAVE BEEN CORRECTED.

NO PART OF THIS SYSTEM SHALL BE INSTALLED IN ANY LOCATION OR MANNER WHICH MAY ENDANGER THE HEALTH, SAFETY, OR WELFARE OF THE PUBLIC. OPEN EXCAVATIONS SHALL BE BARRICADED OR COVERED. PROVIDE AND MAINTAIN ALL LIGHTS, WARNING SIGNS, BARRICADES, ETC. AS MAY BE REQUIRED OR NECESSARY TO PROTECT THE PUBLIC. ALL ABOVE GROUND EQUIPMENT SHALL BE INSTALLED ADJACENT TO STRUCTURES, FENCES, OR WALLS, OR IT SHALL BE PERMANENTLY BARRICADED IN SUCH A WAY AS TO PREVENT TRIPPING OVER IT OR RUNNING INTO IT INADVERTENTLY.

PROTECT BUILDINGS, WALKS, WALLS AND OTHER PROPERTY FROM DAMAGE. DAMAGE CAUSED TO ASPHALT, CONCRETE, OR OTHER BUILDING MATERIAL SURFACES SHALL BE REPAIRED OR REPLACED AT NO COST TO THE OWNER. RESTORE DISTURBED AREAS TO ORIGINAL CONDITIONS. EXPENSES DUE TO VANDALISM BEFORE FINAL ACCEPTANCE SHALL BE BORNE BY THE CONTRACTOR.

INSTALL ANY SLEEVING UNDER ASPHALT OF CONCRETE PAVING WIDER THAN 5' PRIOR TO PAVING OPERATIONS TO ACCOMMODATE PIPING. COMPACT BACKFILL AROUND SLEEVES TO 95 % MODIFIED PROCTOR DENSITY WITHIN 2 % OF OPTIMUM MOISTURE CONTENT IN ACCORDANCE WITH ASTM DI557 OR AS DIRECTED BY CIVIL ENGINEER. ANY SETTLING OF BACKFILLED TRENCHES WHICH A OCCUR DDURING GUARANTEE PERIOD SHALL BE REPAIRED AT NO EXPENSE TO THE OWNER, INCLUDING COMPLETE RESTORATION OF DAMAGED PROPERTY.

TRENCH EXCAVATION SHALL FOLLOW, AS MUCH AS POSSIBLE, LAYOUT SHOWN ON DRAWING. DIG TRENCHES STRAIGHT AND SUPPORT PIPE CONTINUOUSLY ON BOTTOM OF TRENCH. TRENCH BOTTOM SHALL BE CLEAN AND SMOOTH WITH ALL ROCK AND DEBRIS REMOVED. TRENCHES FOR PIPING SMALLER THAN 3 INCHES SHALL HAVE A MINIMUM WIDTH OF 7 INCHES.

PROVIDE NOT LESS THAN 6 INCHES OF CLEARANCE BETWEEN EACH LINE, AND NOT LESS THAN 12 INCHES OF CLEARANCE BETWEEN LINES OF OTHER TRADES. ALL IRRIGATION LINES SHOULD BE A MINIMUM OF 18" BELOW BOTTOM OF BASE COURSE UNDER PAVING. SNAKE PIPE IN TRENCH AS MUCH AS POSSIBLE TO ALLOW FOR EXPANSION AND CONTRACTION. DO NOT INSTALL PIPE WITH AIR TEMPERATURE IS BELOW 40F. WHEN PIPE LAYING IS NOT IN PROGRESS, OR AT END OF EACH DAY, CLOSE PIPE ENDS WITH TIGHT PLUG OF CAP. FLUSH EACH LINE COMPLETELY BEFORE INSERTING NOZZLES. PERFORM WORK IN ACCORDANCE WITH GOOD PRACTICE PREVAILING IN PIPING TRADES.

HEAD AND EQUIPMENT ALLOWANCE: THE CONTRACTOR IS REQUIRED TO PROVIDE THE OWNER WITH A COMPLETE PROJECT. HE/SHE SHALL INSTALL ANY ADDITIONAL HEADS, NOZZLE CHANGES, VALVES, IRRIGATION LINES, DRIP LINE, WIRE, ETC. AS NECESSARY TO ACCOMMODATE ANY NECESSARY FIELD CHANGES. THE CONTRACTOR SHALL MAKE ALL NEEDED CHANGES AS DIRECTED BY THE LANDSCAPE ARCHITECT AND PROVIDE THE OWNER WITH A COMPLETE PROJECT.

(A)IRRIGATION NOTES

WATER EFFICIENT LANDSCAPE WORKSHEET

Project Name	Gateway Hot	el			Date:	6.15.2017	
Reference Evapotranspir	-		42.8 South San Francisco				
MAWA Allowance	0.45						
(.45 for Commercial, .55	for Residentia		1				
	Tor nesidentit	ii, :03 23/(j					
							Estimated
Hydrozone # and	Plant Factor	Irrigation	Irrigation	ETAF	Landscape		Total Water
Planting Description	(PF)	Method	Efficiency*	(PF/IE)	Area (sf)	ETAF x Area	
REGULAR LANDSCAPE AR		methou	2	(,.=)	/		
HZ #1 Med WU Plants		Drip	0.81	0.62	4688	2893.83	76790.60
HZ #2 Low WU Plants		Drip	0.81			2040.25	
HZ #3 Med WU-Basin		MP Rotators	0.75	0.67	2565	1710.00	
HZ #4 Tree Bubblers	0.4	Bubblers	0.81	0.49	1000	493.83	
			1	0.00		0.00	0.00
			1	0.00		0.00	0.00
			1	Totals	16516	7137.90	
SPECIAL LANDSCAPE AREAS							
			_	1		0.00	0
			_	1		0.00	0
				1		0.00	0
				Totals	0	0	
						ETWU Total	189411.35
			Maximur	n Allowed V	Water Allowa	nce (MAWA)	197220.86
		ET.	AF Calculatio	ons			
REGULAR LANDSCAPE AR	<u>EA</u>		ALL LANDSCAPE AREAS		<u>*IE</u>		
Total ETAF x Area	7137.90		Total ETAF x	Area	7137.90		drip = .81
Total Area	16516		Total Area		16516		spray = .75
Average ETAF 0.43]	Sitewide ETA	۲.	0.43		
		<u>Pro</u>	ject Informa	<u>tion</u>			
Project:	South San Fr	ancisco Hotel		Total Land	lscape Area:		
Location:	550 Gateway	/ Blvd.,South	San Francisco	o P	roject Type:	Commercial	
Applicant: Sri Krishna Enterprise Water Source: City of South San Franicisco							
300 Gateway Blvd.			Checklist of Provided Documents:				
South San Francisco, CA				✓ Water Efficient Worksheet and Budget			
							vided prior to
					-	of Completio	
				\checkmark		d Irrigation F	
					-	ns – by Civil	
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C WATER BUDGET

CHECK VALVES:

ELECTRICAL SERVICE CONDUIT.

VISIBLE LEAKS STOP.


FINAL ACCEPTANCE:

WARRANTY/GUARANTEE:

I. BY APPLICANT: "I/We agree to comply with the requirements of the water efficient landscape ordinance and submit a complete Landscape Documentation Package:

For the Applicant

2. BY LANDSCAPE ARCHITECT:

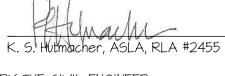

3. BY THE CIVIL ENGINEER "I have complied with the criteria of the ordinance and applied them accordingly for the efficient use of water in the grading design plan"

For the Civil Engineer

4. The LANDSCAPE CONTRACTOR will be required to certify that the project has been installed per plan on the City's Certificate of Completion, available from the City. At this time, Contractor will be also be required to deliver the project Irrigation Schedule, Maintenance Schedule and Irrigation Audit to the Owner, with copies to the City. include these services in Bid Price.

5. The Certificate of Completion will also require the Owner to certify that the Landscape Documentation materials have been received and that the Owner will maintain the project in accordance with the irrigation and maintenance schedules.



ISTALL CHECK VALVES AT THE BASE OF ANY LINES OR HEADS THAT DISPLAY LOW END DRAINAGE. THESE SHALL BE INCLUDED IN THE CONTRACTORS PRICE AND SHALL BE ADDED AS DIRECTED BY THE ARCHITECT AND PROVIDE THE OWNER WITH A COMPLETE PROJECT WITH NO ADDITIONAL COST TO THE OWNER.

<u>SLEEVING:</u> THE CONTRACTOR SHALL BE RESPONSIBLE FOR PROVIDING ADEQUATELY SIZED SLEEVING FOR ALL IRRIGATION, LIGHTING AND OTHER LANDSCAPE COMPONENTS. THE DRAWINGS ARE INTENDED TO BE A GUIDE ONLY. SLEEVES SHALL BE CLEARLY MARKED DURING CONSTRUCTION AND SHALL OCCUR UNDER ALL PAVED AREAS WIDER THAN 5' AND SHALL EXTEND I' MINIMUM BEYOND ALL PAVING.

ALL EXPOSED 110V WIRES SHALL BE PLACED IN RIGID METAL CONDUIT AND HARD WIRED DIRECTLY TO IIOV SERVICE. ALL EXPOSED LOW VOLTAGE WIRE FOR IRRIGATION SHALL ALSO BE PLACED IN RIGID METAL

WHILE TRENCHES ARE OPEN, PLACE ALL LINES UNDER WORKING PRESSURE FOR 2 HOURS UNDER OBSERVATION OF OWNER'S REPRESENTATIVE. REPAIR OR REPLACE ANY DEFECTIVE ELEMENTS AND REPEAT TEST UNTIL ALL

OPERATE EACH IRRIGATION ZONE FOR THE LANDSCAPE ARCHITECT. ITEMS DEEMED NOT ACCEPTABLE SHALL BE REPAIRED OR REPLACED TO SATISFACTION.

MANUFACTURERS SHALL WARRANTY MATERIALS AGAINST DEFECTS FOR A MINIMUM PERIOD OF ONE YEAR FROM DATE OF FINAL ACCEPTANCE. INSTALLER SHALL GUARANTEE WORKMANSHIP FOR THE SAME PERIOD.

PLANTING NOTES

HE CONTRACTOR SHALL CONFIRM AVAILABILITY OF PLANT MATERIALS IMMEDIATELY AFTER THE SIGNING OF THE CONTRACT WITH THE OWNER. SUBSTITUTIONS WITHOUT PRIOR WRITTEN AUTHORIZATION BY THE LANDSCAPE ARCHITECT ARE NOT ALLOWED.

THE FEATURES ARE SHOWN SCHEMATICALLY FOR GRAPHIC CLARITY. NO UTILITY SURVEY HAS BEEN CONDUCTED. PRIOR TO PLANTING, VERIFY EXACT LOCATIONS WITH THE PROJECT ENGINEER AND OWNER. TREES LOCATIONS SHALL RESPECT THE FOLLOWING

OFFSETS FROM UTILITIES: • 30' FROM STREET CORNERS FOR VISIBILITY & 15' FROM DRIVEWAY, STOP SIGNS, ALLEYS, LIGHT

- POLES AND POWERS POLES • 10' FROM FIRE HYDRANTS & 8' FROM SEWER LINES
- 5' FROM BUILDINGS OVERHANGS AND 2' FROM ADJACENT CONCRETE AND ADJOINING PROPERTY IINES

• 3' FROM GAS, ELECTRICAL, AND WATER LINES, AND ROOF DRAINS IE CONFLICTS ARISE BETWEEN PLANS AND FIELD

CONDITIONS NOTIFY PROJECT ENGINEER AND LANDSCAPE ARCHITECT.

ALL PLANTINGS SHALL BE INSTALLED IN ACCORDANCE WITH ALL FEDERAL, STATE AND LOCAL CODES AND NURSERY AND MANUFACTURER'S SPECIFICATIONS, RECOMMENDATIONS AND REQUIREMENTS. NOTIFY THE LANDSCAPE ARCHITECT IMMEDIATELY IN WRITING PRIOR TO SIGNING OF A CONTRACT WITH THE OWNER OF ANY CONFLICTS. CONFLICTS NOTED AFTER CONTRACT SIGNING OR AFTER THE COMMENCEMENT OF WORK SHALL BE THE SOLE RESPONSIBILITY OF THE CONTRACTOR.

LANDSCAPE CONTRACTOR SHALL NOT FINE GRADE, AMEND SOIL OR DO ANY PLANTING OR IRRIGATION WORK UNTIL FINAL GRADES ARE ESTABLISHED WITHIN O.I' BY GENERAL CONTRACTOR.

FINISH GRADES IN PLANTING AREAS: FINISH GRADES SHALL CONFORM TO GRADING PLAN. FINISH GRADES SHALL BE I" BELOW ADJACENT HARDSCAPE IN TURF AREAS AND 2" BELOW ADJACENT HARDSCAPE IN SHRUB AREAS. POSITIVE DRAINAGE AWAY FROM BUILDINGS AND WALKWAYS SHALL BE MAINTAINED.

PLANT ALLOWANCE: THE CONTRACTOR IS REQUIRED TO PROVIDE THE OWNER WITH A COMPLETE PROJECT. HE/SHE SHALL INSTALL ANY AND ALL PLANT MATERIAL AS SHOWN ON THE DRAWINGS AND LEGENDS. SHOULD A DISCREPANCY OCCUR BETWEEN THE PLANS, NOTES OR LEGENDS THE ONE THAT REQUIRES THE GREATER NUMBER OF PLANTS SHALL PREVAIL. THE CONTRACTOR SHALL MAKE ALL NEEDED CHANGES AS DIRECTED BY THE LANDSCAPE ARCHITECT AND PROVIDE THE OWNER WITH A COMPLETE PROJECT.

TREE PLANTING: THE CONTRACTOR SHALL BE RESPONSIBLE TO ADEQUATELY PLAN FOR TREE PLANTING WHILE

PLANTING NOTES

INSTALLING THE IRRIGATION SYSTEM. NO TREES OR SHRUBS SHALL BE PLANTED DIRECTLY ON TOP OF IRRIGATION LINES.

<u>ROOT BARRIER</u>

REQUIRED WHERE TREES ARE WITHIN 6' FROM CURBS, WALLS, PAVEMENT OR OTHER HARDSCAPE, WHETHER ILLUSTRATED ON THE PLANS OR NOT. SEE DETAILS REGARDING ADDITIONAL ROOT BARRIER REQUIREMENTS.

PLANTING DEPTH: THE CONTRACTOR SHALL PLANT ALL PLANTS AS SHOWN ON THE DETAILS. SHOULD THE CONTRACTOR OVERDIG PLANTING HOLES, AND THE PLANT OR PLANTS SETTLE, THE CONTRACTOR SHALL BE RESPONSIBLE TO REPLANT THESE PLANTS CORRECTLY. SHOULD REPLANTING WEAKEN THE PLANT, THE CONTRACTOR SHALL REPLACE THE PLANT IMMEDIATELY. SHOULD ANY PLANTS SETTLE DURING THE ONE YEAR WARRANTY PERIOD, THEY SHALL BE REPLACED BY THE CONTRACTOR. ALL REPLANTING AND REPLACEMENT SHALL BE DONE BY THE CONTRACTOR WITHIN TWO WEEKS OF NOTIFICATION AT NO ADDITIONAL COST TO THE OWNER. ALL REPLACEMENT PLANTING SHALL BE PROVIDED BY THE CONTRACTOR TO MATCH THE SAME SIZE OF THE SURROUNDING PLANTING. THE LANDSCAPE ARCHITECT SHALL HAVE THE FINAL DETERMINATION AS TO WHICH PLANTS ARE PLANTED TOO DEEP AND IF ANY PLANTS HAVE BEEN WEAKENED BY REPLANTING AND REQUIRE REPLACEMENT.

DRAINAGE: ALL TREE PITS SHALL BE TESTED FOR ADEQUATE DRAINAGE BY FILLING PLANT PIT WITH WATER. SEE DETAILS FOR REQUIREMENTS.

BACKFILL FOR PLANTING WITH 50% CLEAN NATIVE SOIL AND 50% NITROLIZED FOREST HUMUS OR NITROLIZED SAWDUST. PLANT TREES AND SHRUBS WITH TOP OF ROOTBALL SLIGHTLY ABOVE GROUND LEVEL. SET PLANT ON NATIVE GRADE. SET PLANT, BACKFILL HALFWAY, TAMP SOIL, ADD FERTILIZER TABLETS THEN COMPLETE BACKFILL. SEE DETAIL. SLOW RELEASE FERTILIZER PACKS SHALL BE ADDED WHEN PLANTING AS FOLLOWS: I PER I GALLON, 3 PER 5 GALLON, 6 PER 15 GALLON, 12 PER 24" BOX. PROVIDE WATERING BASIN AROUND EACH PLANT. WATER IMMEDIATELY.

SOIL PREPARATION: REMOVE STONES, ROOTS AND OTHER DEBRIS FROM THE PLANTING AREA. COMPACTED SOIL SHALL BE RETURNED TO A FRIABLE CONDITION. APPLY WATER AS NEEDED TO OBTAIN OPTIMUM MOISTURE CONTENT FOR SOIL PREPARATION AND PLANTING.

FERTILIZER AND AMENDMENTS: CONTRACTOR TO GET SOIL ANALYSIS FOR THE PLANTER AREAS AFTER ROUGH GRADING. FERTILIZERS AND AMENDMENTS SHALL BE REVISED TO MATCH RECOMMENDATIONS BASED ON SOIL ANALYSIS. FOR BID PURPOSES ASSUME APPLICATION OF 20# GYPSUM/1000 SF OF PLANTER, MIXED WELL INTO TOP 6" OF SOIL. ADD 8# 16-16-16 AND 4# HYDRA-HUME DG (AVAILABLE FROM HELENA CHEMICALS) PER 1000 SF. BEFORE PLANTING. PROVIDE 4 CY/IOOO SF MATURE COMPOST AND TILL INTO TOP 6" OF SOIL. PROVIDE

WATER EFFICIENT LANDSCAPE ORDINANCE CERTIFICATIONS

"I have complied with the criteria of the ordinance and applied them for the efficient use of water in the landscape and irrigation plans"

Date

8.3.2017 Date

Date License No.

WEIGHT TAGS OR BAG RECEIPTS TO PROJECT ARCHITECT WITH WORK INVOICES.

BIORETENTION BASINS: UNLESS OTHERWISE INDICATED IN CIVIL PLANS, BIORETENTION AREA BACKFILL AND DRAINLINES BY SITE GRADING CONTRACTOR.

CONTRACTOR WILL APPLY RONSTAR OR APPROVED EQUAL PER MANUFACTURER'S REQUIREMENTS AFTER PLANTING. CONFORM TO ALL NATIONAL, STATE AND LOCAL REPORTING REQUIREMENTS. CONTRACTOR WILL MAINTAIN THE PROJECT IN A WEED-FREE CONDITION UNTIL END OF MAINTENANCE PERIOD.

ALL TREES SHALL MEET THE REQUIREMENTS OF THE AMERICAN ASSN. OF NURSERYMEN 'AMERICAN STANDARD FOR NURSERY STOCK'. TREES SHALL BE OF EXCELLENT HEALTH WITHOUT DAMAGED OR CIRCLING ROOTS OR FOLIAR DAMAGE FROM FUNGUS, INSECT, SUN OR WIND EXPOSURE OR OTHER BIOLOGICAL OR CLIMATIC CAUSE. THE LANDSCAPE ARCHITECT OR OWNER RESERVE THE RIGHT TO REJECT UNSUITABLE TREES EVEN AFTER PLANTING. CONTRACTOR SHALL REQUEST EVALUATION FROM LANDSCAPE ARCHITECT PRIOR TO PLANTING IF HE/SHE HAS QUESTIONS REGARDING SUITABILITY. IF EVALUATION REQUIRES A SITE VISIT NOT PREVIOUSLY SCHEDULED, THE COST OF THE EVALUATION SHALL BE BORNE BY THE CONTRACTOR. TREES SHALL BE STAKED PER DETAIL

<u>REE CALIPER</u> TREES WILL HAVE THE FOLLOWING CALIPER AT 6" ABOVE GRADE:

5 GAL.	.5"75"
15 GAL.	.75"-1.5"
24" BOX	1.5"-2.5"

WARRANTY PERIOD, MAINTENANCE PERIOD CONTRACTOR SHALL WARRANT PLANTING AND ALL OF ITS COMPONENTS FOR 12 MONTHS AFTER FINAL ACCEPTANCE OF PROJECT. CONTRACTOR SHALL BE RESPONSIBLE FOR ALL MATERIALS AND LABOR ASSOCIATED WITH THE GUARANTEE, INCLUDING BUT NOT LIMITED TO THE LOSS OF PLANT MATERIAL OR DAMAGE TO STRUCTURES. CONTRACTOR SHALL PROVIDE MAINTENANCE OF THE PROJECT FOR 90 DAYS BEGINNING AT SUBSTANTIAL COMPLETION OF THE PROJECT.

MULCH: THE CONTRACTOR SHALL INSTALL 3" OF WOOD CHIPS OR BARK ON ALL NON-TURF PLANTING AREAS, EXCEPT IN BIORETENTION BASINS.



Vijay Patel, Project Manager

Sheet Title

_ANDSCAPE NOTES AND WATER EFFICIENCY DOCUMENTATION

CALL BEFORE YOU DIG **48 HOURS CALL "USA" TOLL FREE**



UNDERGROUND SERVICE ALERT

SDI Job No: 16-032 Project Manager: kh **Drawn By**: kd Date: 8-29-17 Scale: 1" = 20'

